### ROOF REPLACEMENT

# SCHOOL OF SOCIAL WORK BUILDING

5447 WOODWARD AVENUE

DETROIT, MICHIGAN 48202

### WSU PROJECT NUMBER: 063-304298

#### **ALTERNATES:**

075216-STYRENE-BUTADINE-STYRENE (SBS) MODIFIED BITUMINOUS WITH NEW. REFER TO SPECIFICATION SECTION 231123-FACILITY MEMBRANE ROOFING, AND DRAWINGS.

- 1. BASE BID: 2-PLY STYRENE-BUTADIENE-STYRENE (SBS) MODIFIED BITUMINOUS MEMBRANE ROOFING, 2-INCH MINERAL WOOL ROOF INSULATION (R-8), 3.8-INCH POLYISOCYANURATE ROOF INSULATION (R-22), 2-PLY VAPOR BARRIER (APPROXIMATELY 6-1/2 INCHES).
- 2. ALTERNATE BID: 2-PLY STYRENE-BUTADIENE-STYRENE (SBS) MODIFIED BITUMINOUS MEMBRANE ROOFING, 5/8-INCH COVER BOARD, 2.6-INCH POLYISOCYANURATE ROOF INSULATION (R15), BASE LAYER OF 2.6-INCH POLYISOCYANURATE ROOF INSULATION (R15), 2-PLY VAPOR BARRIER (APPROXIMATELY 6-1/8 INCHES).

ALTERNATE NO. 2: INCREASE SBS ROOF MANUFACTURER'S WARRANTY FROM 20 TO 25 YEARS - REFER TO SPECIFICATION SECTION 075216-STYRENE-BUTADIENE-STYRENE (SBS) MODIFIED BITUMINOUS MEMBRANE ROOFING, AND DRAWINGS. 1. BASE BID: ONE BASE LAYER MOPPED-IN BASE SHEET.

2. ALTERNATE BID: 2 LAYERS BASE SHEET, MOPPED-IN INDIVIDUALLY. (3-PLY SYSTEM)

ALTERNATE NO. 1: NEW ROOF - REFER TO SPECIFICATION SECTION ALTERNATE NO. 3: REMOVE GAS PIPE COMPLETE AND REPLACE NATURAL-GAS PIPING, AND DRAWINGS


- 1. BASE BID: REMOVE GAS PIPE FOR REINSTALLATION.
- 2. ALTERNATE BID: REMOVE GAS PIPE COMPLETE. REPLACE GAS PIPE WITH NEW MATERIALS.

ALTERNATE NO. 4: GUARD RAIL. REFER TO SPECIFICATION SECTION 055000-METAL FABRICATIONS, AND DRAWINGS

- 1. BASE BID: REMOVE GALVANIZED STEEL TUBE GUARD RAIL AND PERFORATED STAINLESS STEEL METAL PANELS, STORE TO BE REUSED PER DETAIL 2/A-501.
- 2. ALTERNATE BID: REMOVE GALVANIZED STEEL TUBE GUARD RAIL AND PERFORATED STAINLESS STEEL METAL PANELS COMPLETE. FABRICATE ALL NEW ELEMENTS PER REQUIREMENTS OF DETAIL 3/A-501.

SECTION 076200-SHEET METAL FLASHING AND TRIM, AND DRAWINGS

- 1. BASE BID: 24 GAUGE STAINLESS STEEL COPING.
- 2. ALTERNATE BID: 24 GAUGE GALVANIZED SHEET STEEL WITH THREE-COAT FLUOROPOLYMER COIL-COATED FINISH. FINISH COLOR TO MATCH COLOR OF EXISTING GUARD RAIL

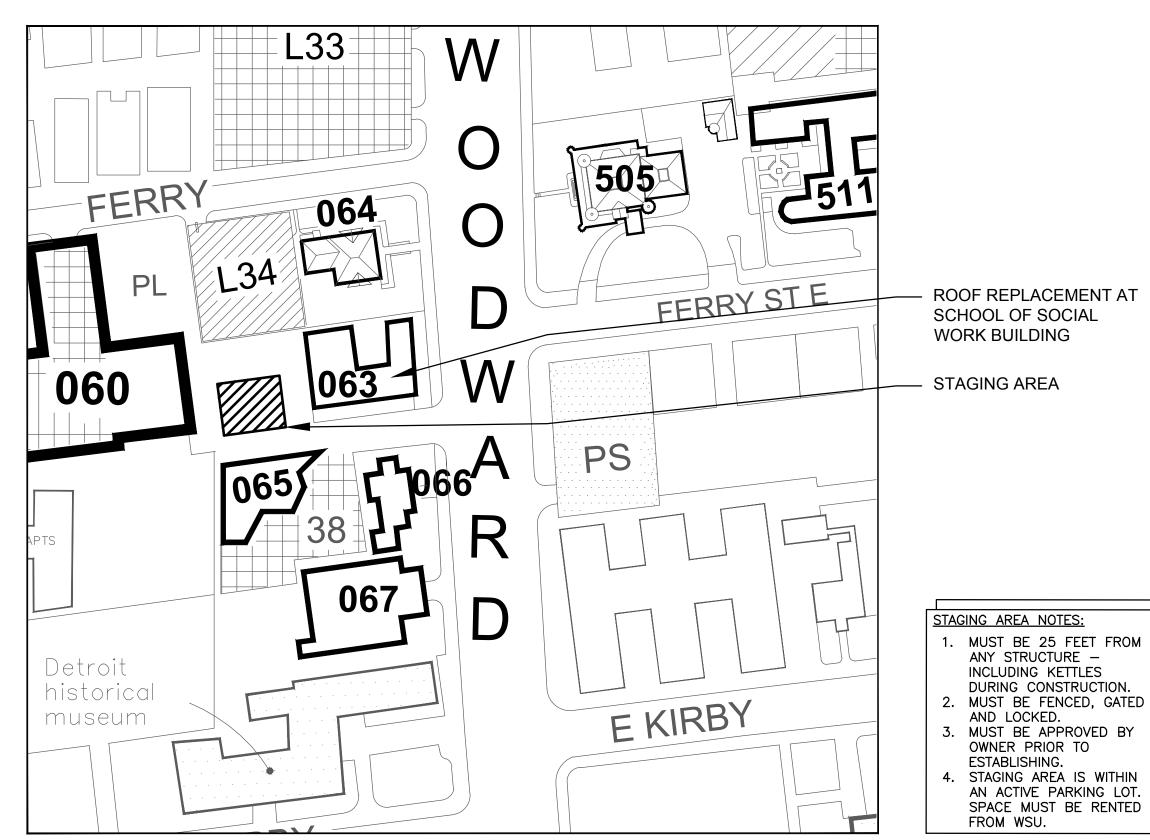



**DRAWING LIST** 

**ARCHITECTURAL** 

**MECHANICAL** 

**ELECTRICAL** 

**ROOF PLAN** 

G-100 DRAWING LIST / LOCATION PLAN

DEMOLITION ROOF PLAN

**ELECTRICAL SYMBOLS LIST** 

ELECTRICAL NEW ROOF PLAN

**MECHANICAL ROOF PLAN - DEMOLITION** MECHANICAL ROOF PLAN - NEW WORK

**ELECTRICAL DEMOLITION ROOF PLAN** 

**GENERAL** 

A-500

BIDS

### **CLIENT:**

WAYNE STATE UNIVERSITY FACILITIES PLANNING & MANAGEMENT

5454 CASS AVENUE DETROIT, MICHIGAN 48202

### **ARCHITECT:**


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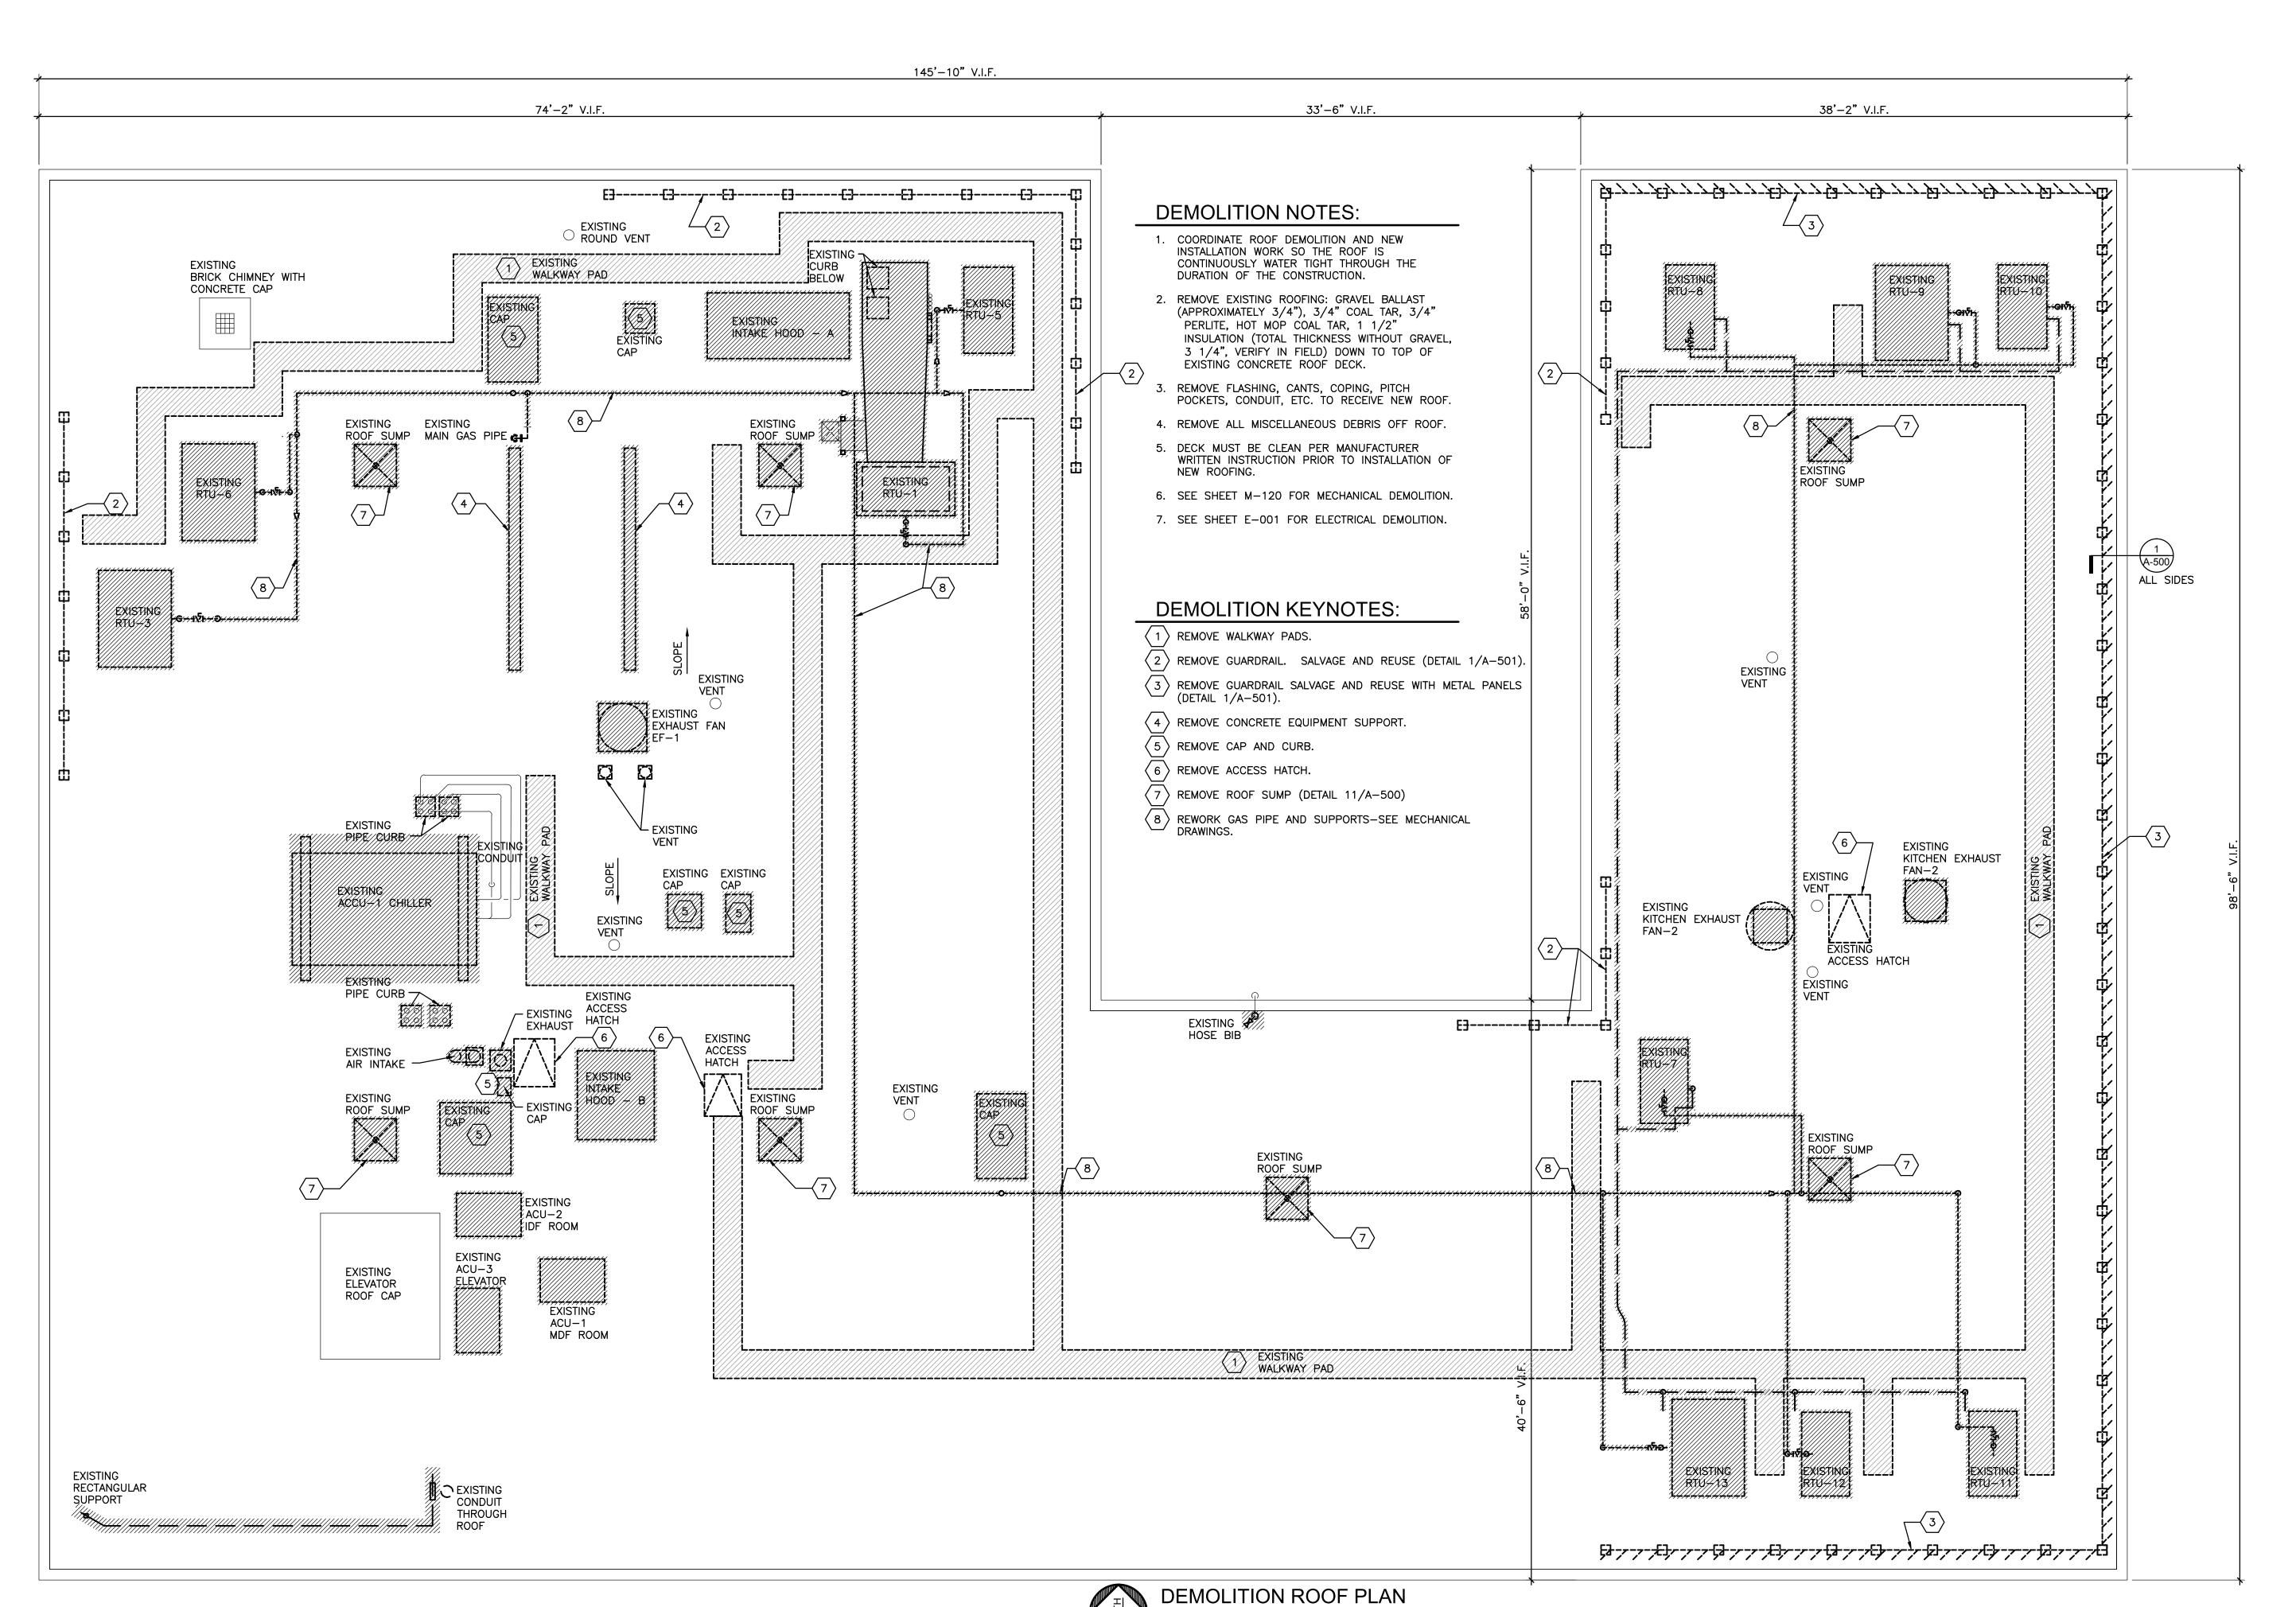
23761 RESEARCH DRIVE,


FARMINGTON HILLS, MICHIGAN 48335

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23761 Research Drive Farmington Hills Michigan 48335 248.477.2444 248.477.2445 fax www.nsa-ae.com Founded 1960

# WAYNE STATE UNIVERSITY

WSU - FACILITIES **PLANNING & MANAGEMENT** 

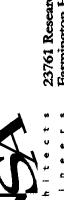**MICHIGAN** 

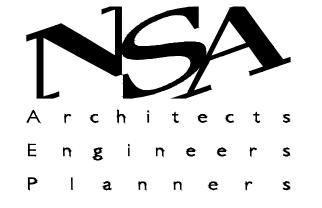**DETROIT** 

Project Title: ROOF REPLACEMENT SCHOOL OF SOCIAL **WORK BUILDING** 

Date:	Issued for:
03-14-2018	OWNER REVIEW
03-22-2018	OWNER REVIEW
05-01-2018	BIDS
07-24-2018	BIDS

Drawn:	ERM	Designed:	ERM
Checked:	,	Approved:	

CAD Drawing File:


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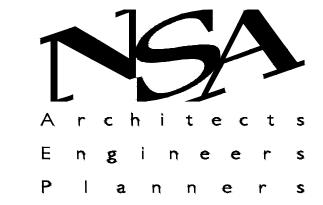
Project Number: 217031.00

Sheet Title: **DEMOLITION ROOF PLAN** 

Sheet Number:

A-120



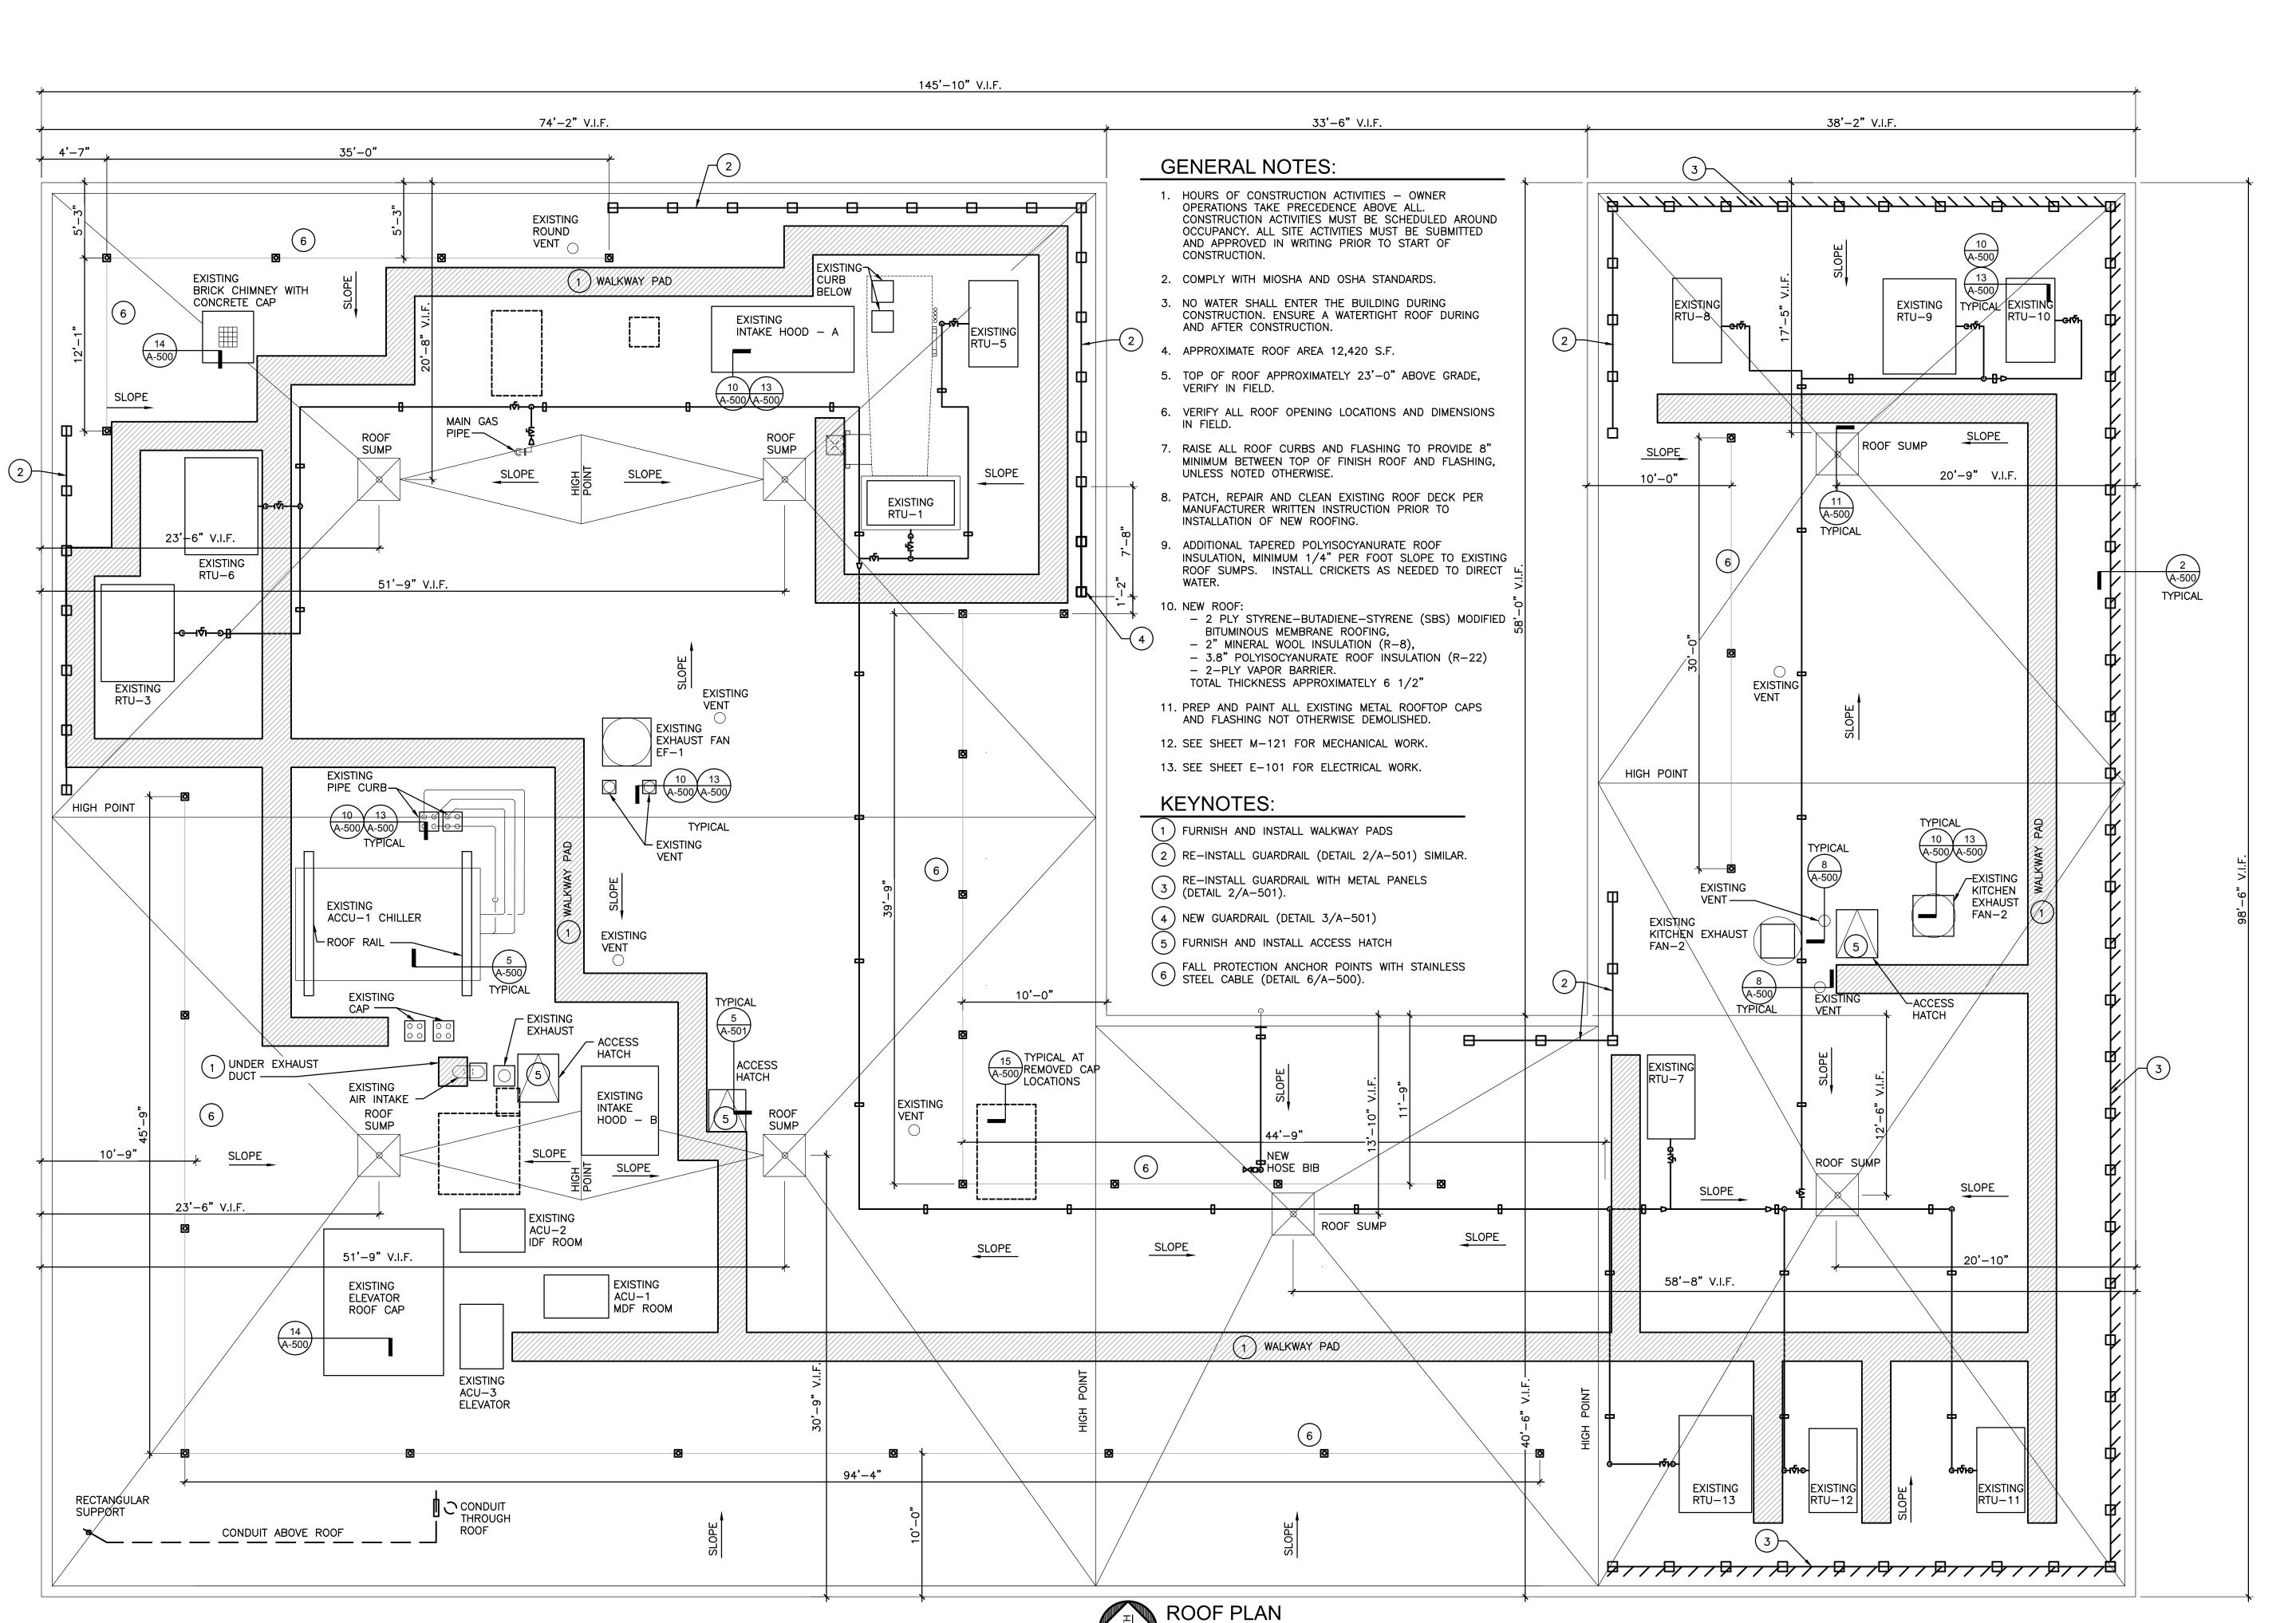

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248.477.2444 248.477.2445 fax www.nsa-ae.com Founded 1 9 6 0

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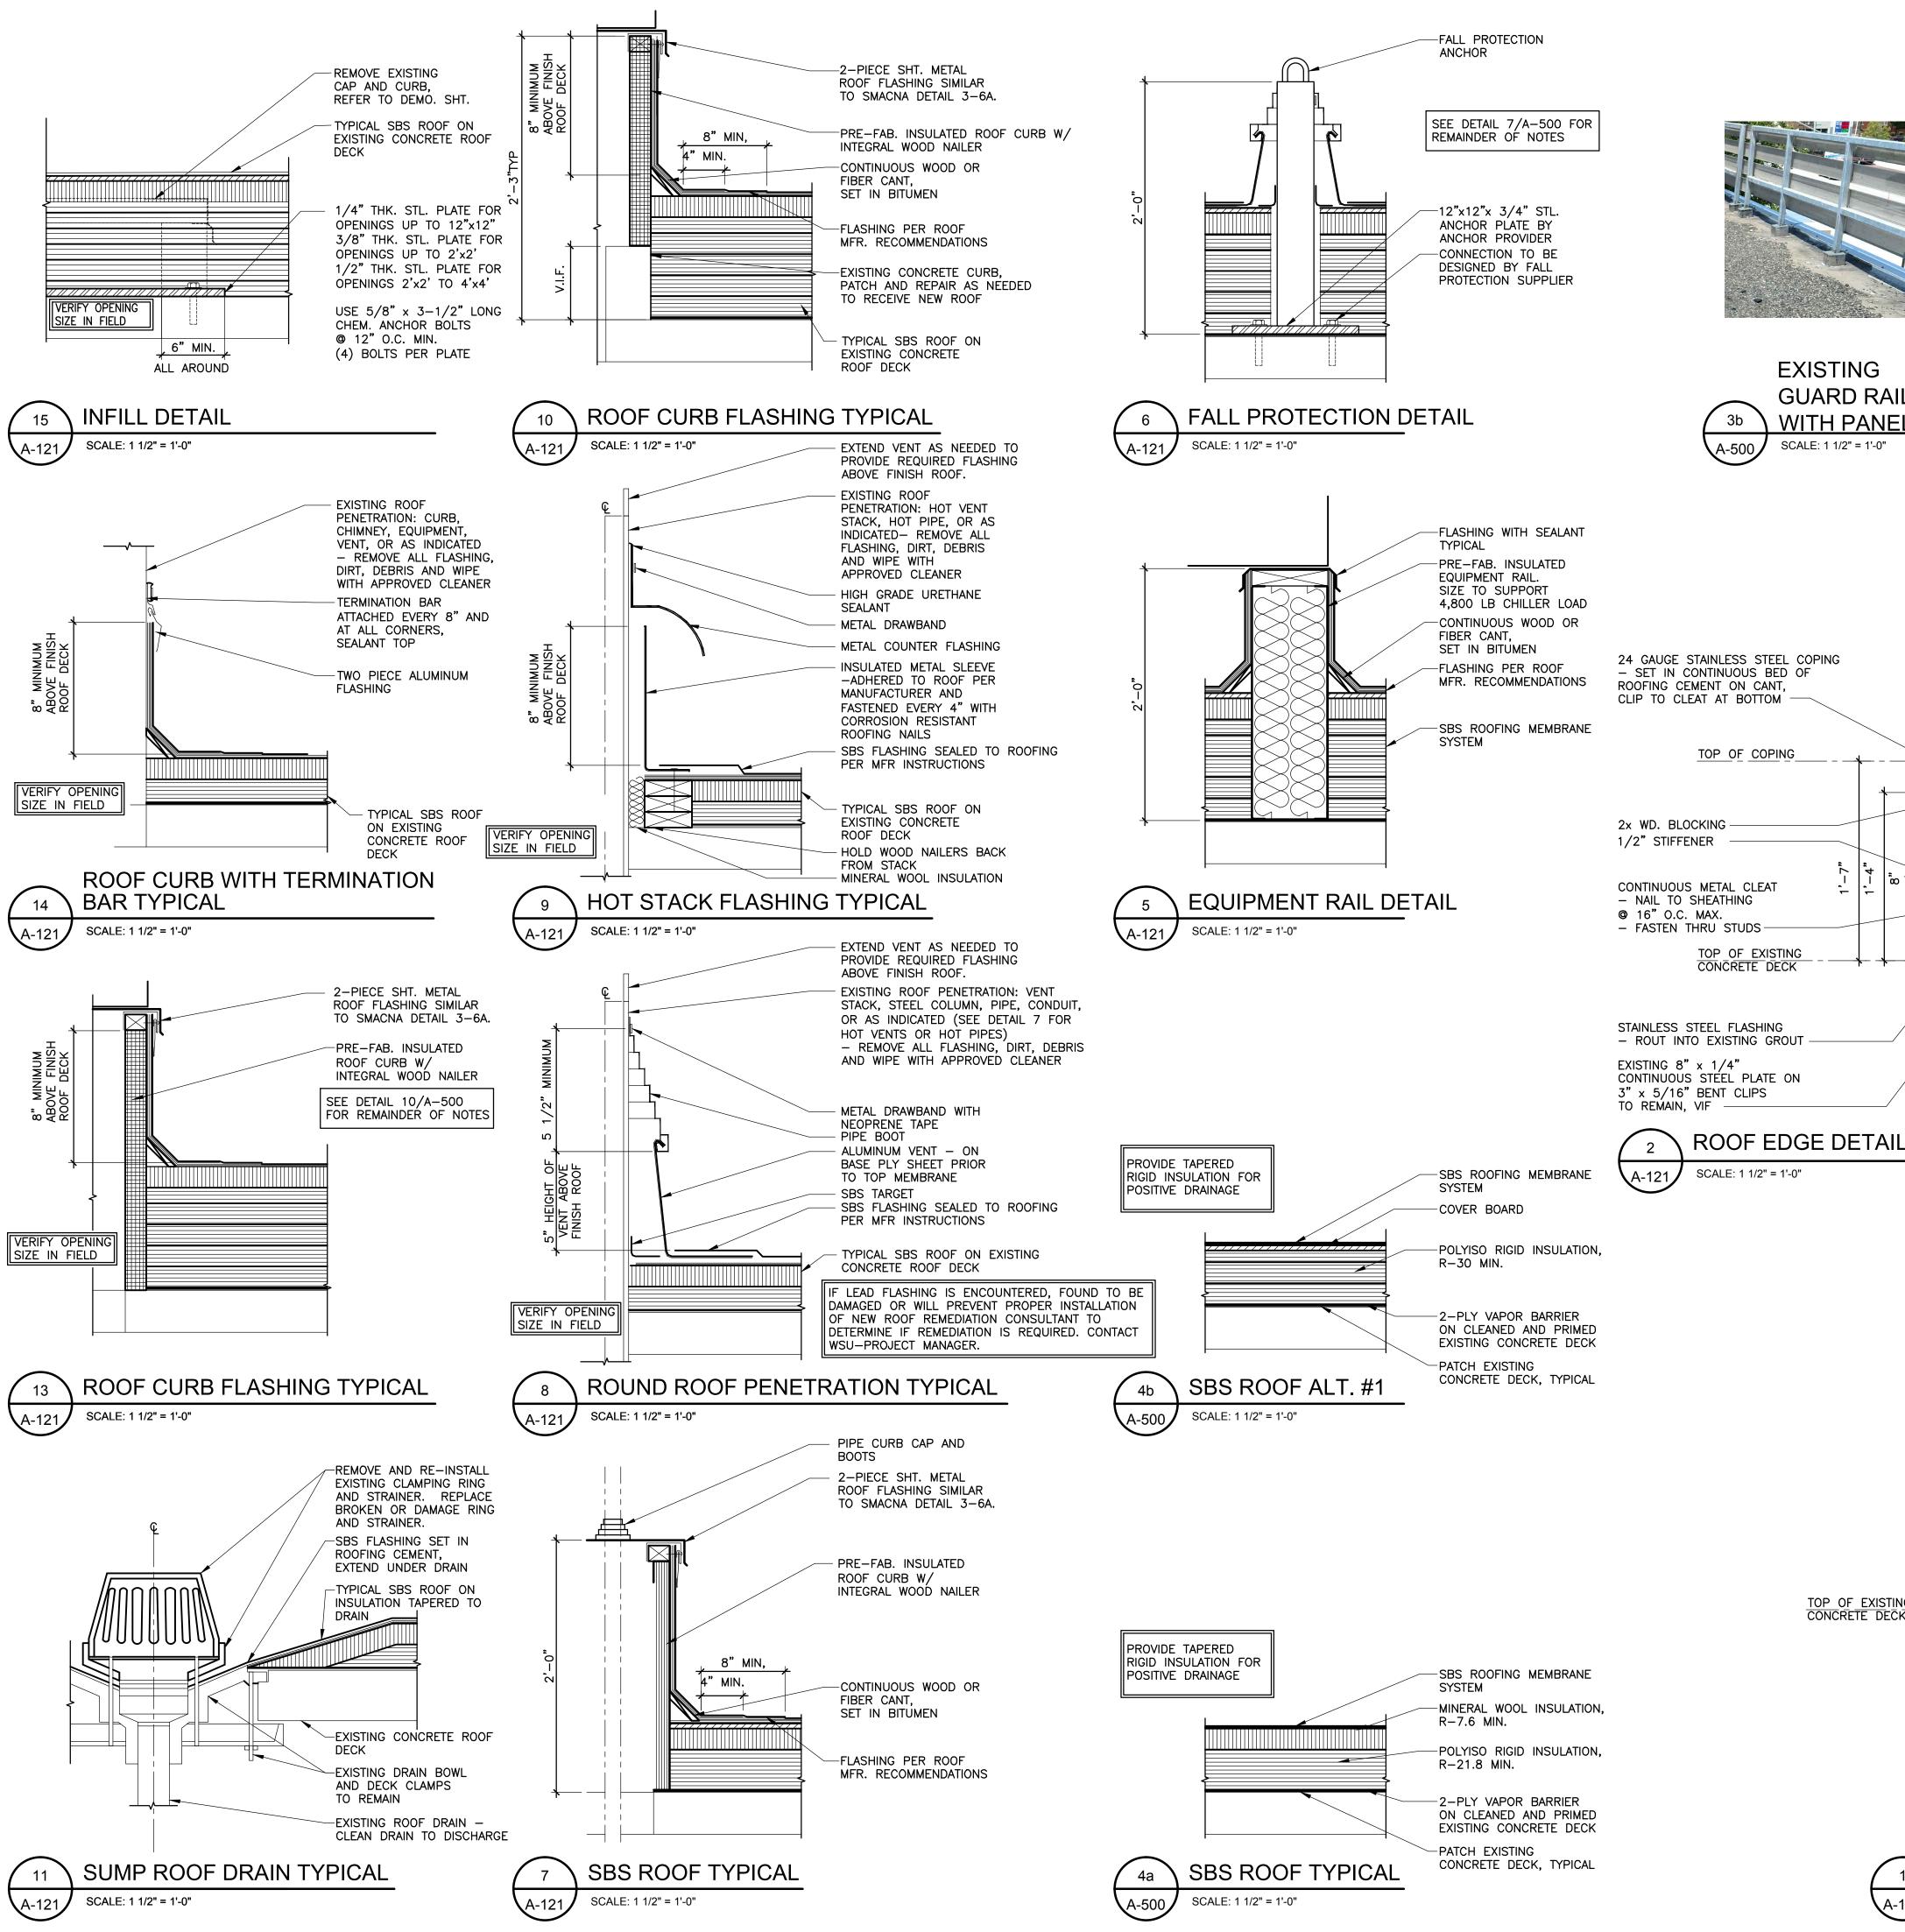
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Project Number:

217031.00
Sheet Title:

Sheet Title:
ROOF PLAN

Sheet Number: A-121











-EXISTING GUARD RAIL SYSTEM

- RETURN OVER TOP OF KNEE WALL

CONTINUOUS WOOD OR FIBER CANT,

- 4", 16 GAUGE STEEL STUDS AT

16" O.C. 1/2" EXTERIOR PLYWOOD

- FASTEN RUNNER TO COLD FORM

METAL FRAMING WITH .145 POWER ACTUATED FASTENERS AT 12" O.C.

- PACK VOID WITH BATT INSULATION

16 GA. GALVANIZED BENT PLATES

16" HORIZONTAL, BENT AS SHOWN.

-ATTACH COLD FORM METAL FRAMING

EXISTING STEEL PLATES WITH

ANCHOR TO CONCRETE DECK WITH

3" MIN. EMBEDMENT,

4 1/2" HILTI ANCHORS WITH

HILTI ANCHORS @ 16" O.C. &

HILTI HIT-HY 150 MAX. ADHESIVE,

3 ANCHORS PER 3'-0" LENGTH

-3'-0" LONG COLD FORM METAL FRAMING,

@ 4'-0" O.C. TO WORK AROUND EXISTING

SHEATHING ON BOTH SIDES

TO BE RE-WORKED,

-SHEET FLASHING

HEIGHT VARIES

SEE 3a/A-500

KNEE WALL

GUARD RAIL.

8" VERTICAL.

BENT PLATE TO

TYPICAL SBS ROOF

SEE DETAIL 2/A-501





Engineers

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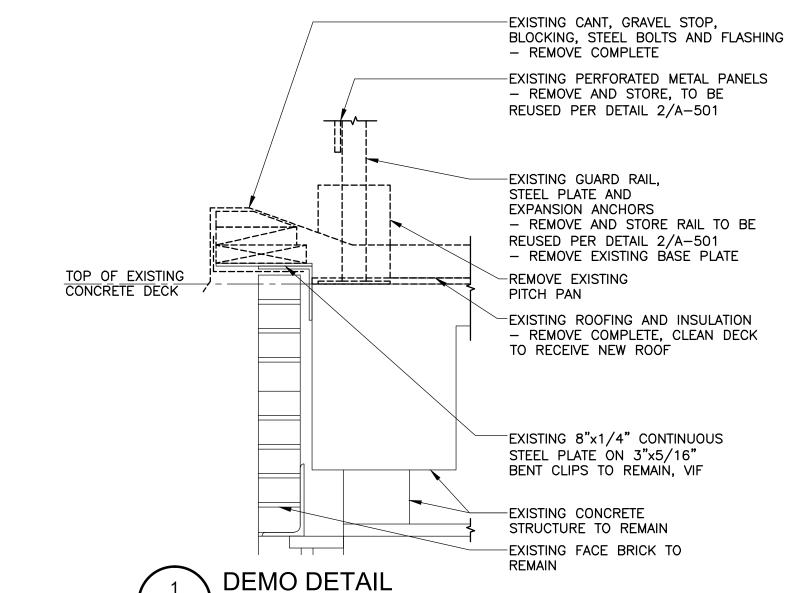
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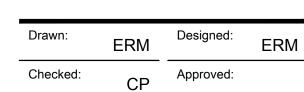
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SCALE: 1 1/2" = 1'-0"

A-120

6" MIN.



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CAD Drawing File:

Project Number:

Sheet Title:

**DETAILS** 

Sheet Number:

A-500

217031.00




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LADDER AND HATCH DETAIL

SCALE: 3/4" = 1'-0"

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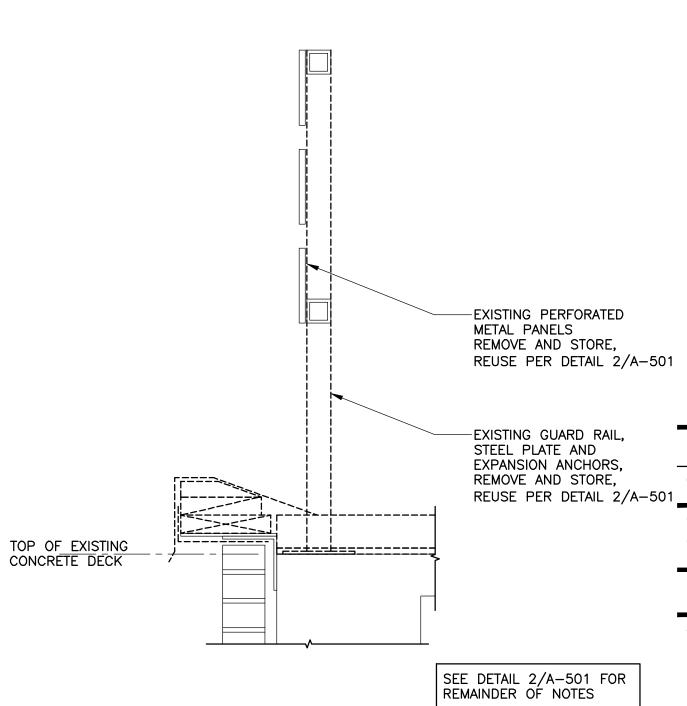
**WORK BUILDING** 


05-01-2018

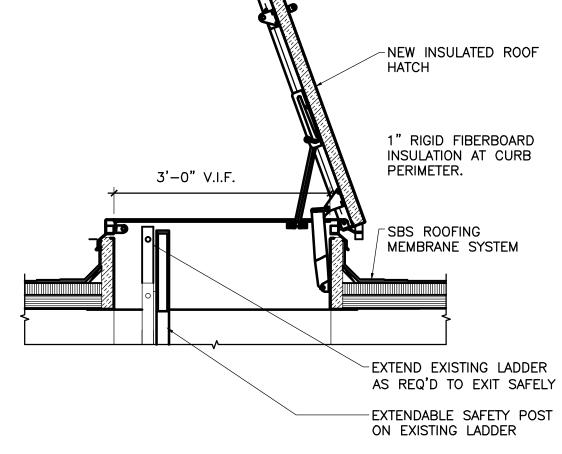07-24-2018


Issued for: 03-14-2018 OWNER REVIEW OWNER REVIEW 03-22-2018 OWNER REVIEW 03-23-2018

BIDS



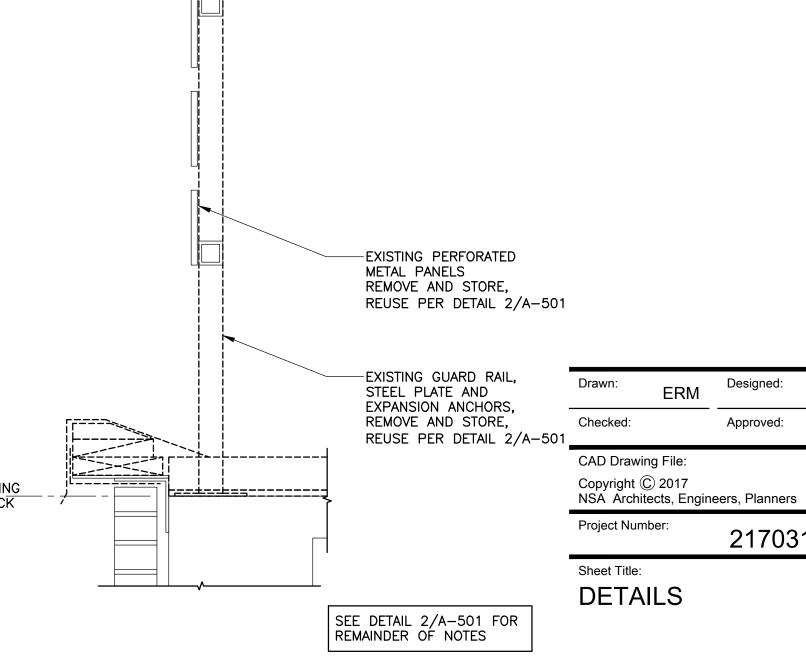



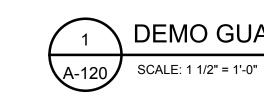


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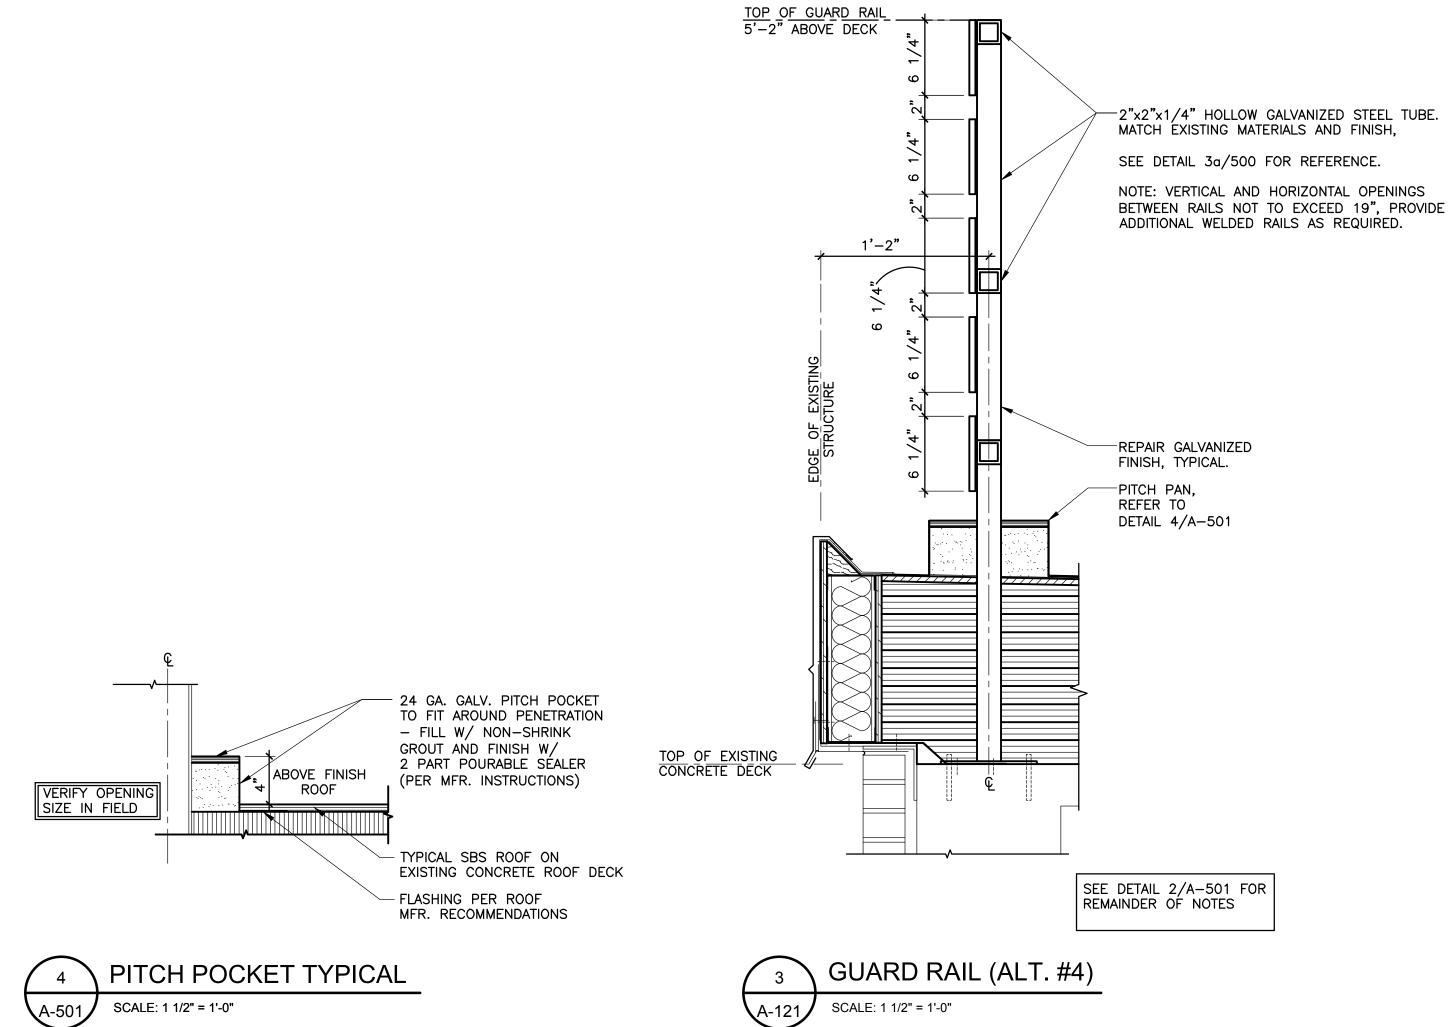
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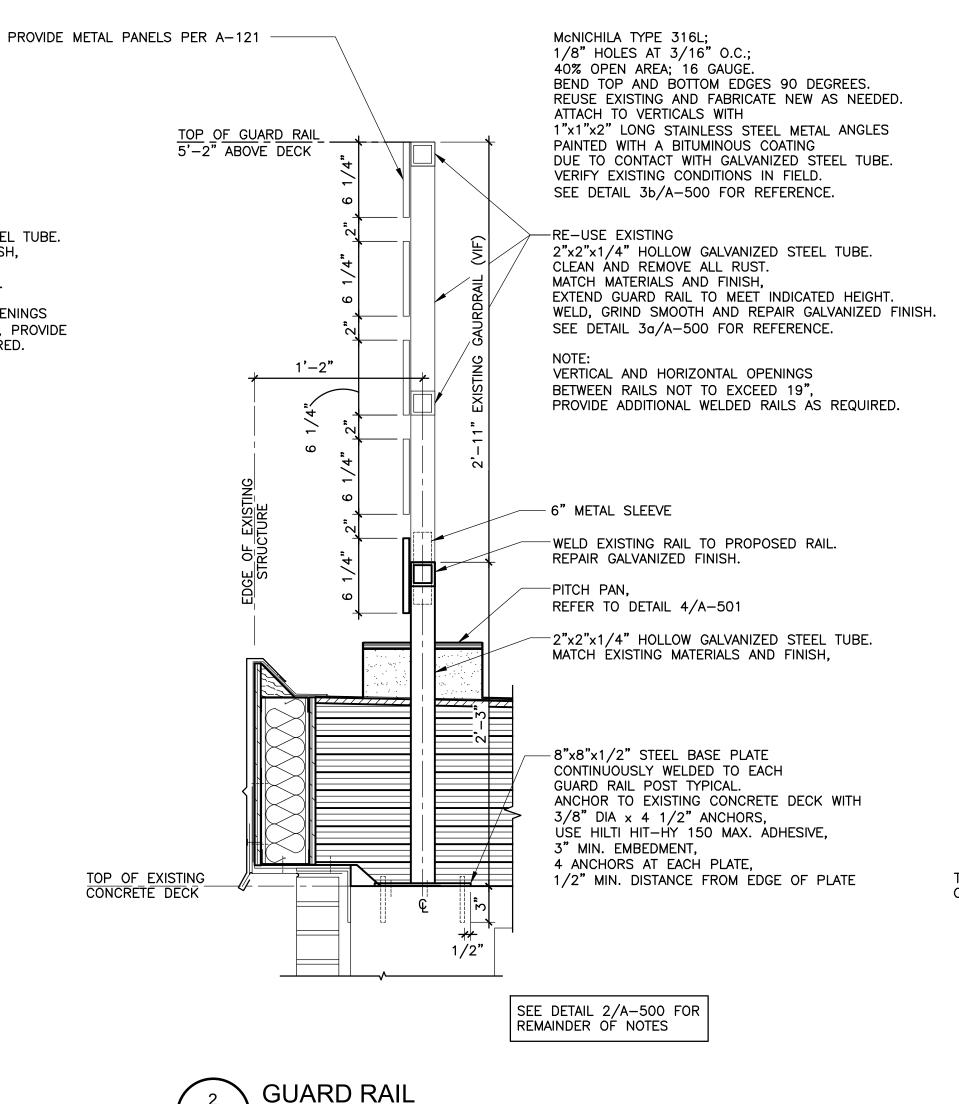
Approved:

217031.00

Sheet Number: A-501





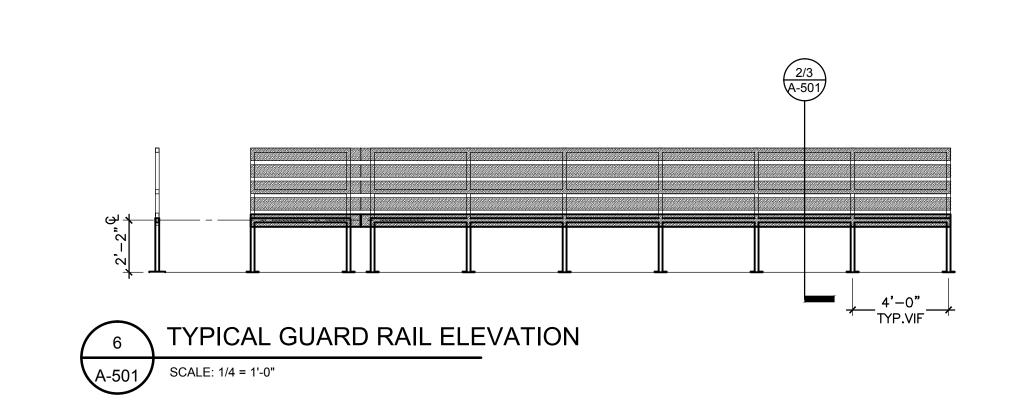

SCALE: 1 1/2" = 1'-0"

#### CONTROLS SCOPE OF WORK

(E)36" HIGH BRICK CHIMNEY

(E)42½"x43"x11"

<u>NEXIRTUI-6</u>

(E)120"x8"x14"

ROOF RAILS

(TYP.2)—

(E)81"x61"x121/2

ROOF CURB

(E)RTU-3

(E)81"x61"x121/2"

ROOF CURB

**RÓOF CURB** 

WAYNE STATE UNIVERSITY HAS RETAINED SIEMENS UNDER A SEPARATE CONTRACT TO PROVIDE HVAC CONTROLS PROGRAMMING SERVICES. THIS SCOPE WILL BE COORDINATED BY CONTRACTOR. PAYMENTS WILL BE MADE DIRECTLY FROM WAYNE STATE TO

- THE SCOPE OF WORK BY SIEMENS INCLUDES ALL CONTROLS PROGRAMMING SERVICES FOR ALL DDC-CONTROLLED EQUIPMENT. THIS INCLUDES:
- ROOF TOP UNITS 1, 3, 5, AND 6 INCLUDED WITHIN DDC PXCC-2 AND PXCC-3 SCOPE OF WORK ONLY EXHAUST FANS (ONLY THOSE CONTROLLED BY DDC) WILL BE RETERMINATED INTO PXCC CONTROLLERS CONDENSER UNITS (ONLY THOSE CONTROLLED BY DDC) WILL BE RETERMINATED INTO PXCC CONTROLLERS
- THE ELECTRICAL SCOPE OF WORK RELATED TO THE RTUS, EXHAUST FAN, AND CONDENSER SHALL BE THE CONTRACTORS
- RESPONSIBILITY: A. ALL DISCONNECTING AND RE-CONNECTING OF POWER AND CONTROL WIRING FOR ALL ROOF TOP EQUIPMENT

(E)71"x42"12½"

KEYCAP/

ROOF CURB -

CAPPED-

(E)186"x9½"x

ŘÉFRIGERANT

14 (E)17½"x17"x10" (E)ACCESS HATCH

ÉXHAUST-

KEXCAP/

FOR ELEVATOR 7

(E)36"x54"x15"

**ÈQUIPMENT** 

(TYP.2) —

(E)ROOF

(E)16"x16"x9" PIPE CURB

(E)17"x17"x16" PIPE CURB

(TYP.2) —

(TYP.2) —

(EYACCU-1) CHILLER

(E)14½"x14"x10" ROOF CURB

W/10"øAIR

INTAKE -

└─^ RÓOF CURB-

(E)ROOF SUMP

(E)ACU-2 FOR IDF ROOM-

(E)ELEVATOR ROOF CAP

(E)122½"x100"x29" ROOF CURB

 $\langle 1 \rangle$ (E)15x11x7"

(E)28"x18"x10" ROOF CURB

24½"x24½"x10" ROOF CURB

(E)4" VENT-

(E)EHAUST

(E)CAP

(E)28"x28"x10 $\frac{1}{2}$ " ROOF CURB

(E)CAP

(E)ACCESS

HATCH

(E)31½"x12"x10½" ROOF CURB

\_(E)40"x34"x12

ROOF CURB

(E)ROOF

FAN EF-1

(E)40½"x40"x10"

RÓOF CURB

(E)40"x34"x9"

ROOF CURB

HOOD-B

(E)36"x54"x15"

MDF ROOM

**ROOF CURB** 

(E)74½"x64½"x14" ROOF CURB

(E)59½"x59½"x10½" ROOF CURB

(E)36"x54"x14" ROOF CURB

<u> (EXINTAKE/HOODHA</u>

(E)119"x55"x15"

8 (E)16"x14" (E)3"@ ECONOMIZER GAS

(E)ROOF

ŠÚMP (E)25"x16"

ÉCONOMIZER

RÓOF CURB

DUCT —

(E)72"x41"x11½"

RÓOF, CURB

/GAS/

E)167"x54½"

SHEET METAL

-(E)2**"**ø

(EXRTU-1

<sub>/</sub>-(Е)3"ø

(E)4" VENT—

GAS

−(E)¾"ø

(E)73"x37¼"x14"

ROOF CURB

(E)71"x41"x12"

ROOF CURB

(E)CAP

└-(E)1"ø CÁPPED

ENCLOSURE


- REMOVAL AND RE-INSTALLATION OF ENCLOSURE, (2) PXCC CONTROL UNITS AND RELATED NEMA ENCLOSURES CONDENSER INTERLOCK CONTROL WIRING RECONNÈCTIONS ON PXCC-2&3 CONTROLLED UNITS
- IP DROPS TO BE PULLED BACK, SECURE AND RETERMINATE.
- RE-PROGRAMMING OF ALL NON-DDC CONTROLS AND THERMOSTATS.


#### **DEMOLITION KEY NOTES**

- REMOVE ROOF CAP AND EXISTING CURB AND PREPARE ROOF SURFACE FOR COVERING OF OPENING. SEE ARCHITECTURAL DWG'S. FOR DETAIL 15/A-500.
- 2 EVACUATE REFRIGERANT PIPING AND DISCONNECT ALL SERVICES INCLUDING GAS, ELECTRICAL, REFRIGERANT CONTROL WIRING, PIPING AND DUCT CONNECTIONS TO EXISTING ROOF TOP UNIT (RTU). REMOVE RTU AND ROOF CURB AND PREPARE ROOF SURFACE FOR NEW ROOF CURB. PREPARE DUCT ENDS FOR NEW CONNECTION AND REPLACE RTU AFTER COMPLETION OF WORK.
- DISCONNECT STORM WATER PIPING AND REMOVE EXISTING ROOF SUMPS FOR INSTALLATION OF NEW ROOF. PREPARE ENDS OF STORM WATER PIPING FOR NEW CONNECTION AND RECONNECT AND REPLACE ROOF SUMPS AFTER COMPLETION OF WORK. SEE ARCHITECTURAL DWG'S. FOR DETAIL 11/A-500.
- REMOVE ALL EXISTING CONTROL WIRING BACK TO SOURCE.
- 5 REMOVE ALL EXISTING GAS PIPING AND PIPE SUPPORTS BACK TO 6" GAS MAIN AND CAP. PREPARE GAS PIPE FOR
- NEW CONNECTION. REMOVE GAS PIPING BACK TO THIS POINT AND CAP. GAS MAIN, AND GAS TO BOILER TO REMAIN ACTIVE THROUGH
- OUT DEMOLITION PHASE. EXISTING CONCRETE RAILS TO BE REMOVED.
- REMOVE EXISTING SHEET METAL DUCT ENCLOSURE, DUCTWORK AND DUCT SUPPORTS PREPARE DUCT ENDS FOR NEW CONNECTON. REINSTALL ENCLOSURE AND DUCTWORK AFTER ROOF WORK IS COMPLETE. ENSURE ALL COMPONENTS ARE WATERTIGHT DURING AND AFTER CONSTRUCTION.
- REMOVE EXISTING ELECTRICAL PANEL AND ELECTRICAL CONNECTIONS. REINSTALL AFTER ROOF WORK IS COMPLETE.
- REMOVE EXHAUST FAN AND CURB. DISCONNECT ALL ELECTRICAL CONNECTIONS AND DUCTWORK. PREPARE ROOF SURFACE FOR NEW ROOF CURB AND PREPARE DUCT ENDS FOR NEW CONNECTION. REINSTALL FAN AND DUCTWORK AND RECONNECT ALL ELECTRICAL AFTER ROOF WORK IS COMPLETE.
- ROOF HATCH BY ARCHITECTURAL TRADES.
- REMOVE FLASHING AROUND ALL ROOF VENTS AND PREPARE PIPE ENDS FOR NEW CONNECTION.
- DISCONNECT ELECTRICAL AND CONDENSATE PIPING. EVACUATE REFRIGERANT PIPING SERVING CHILLER CONDENSING UNIT AND DISCONNECT. REMOVE ROOF RAILS AND PREPARE ROOF FOR NEW ROOF RAILS AND PIPE CURBS. REINSTALL CONDENSING UNIT AND RECONNECT ALL SERVICES AFTER NEW ROOF WORK IS COMPLETE.
- (14) REMOVE ROOF CURB AND DISCONNECT 10" FLUE DUCT. PREPARE DUCT END FOR NEW CONNECTION AND REPLACE FLUE DUCT AFTER NEW ROOF WORK IS COMPLETE.
- REMOVE ROOF CURB AND DISCONNECT EXISTING 10"Ø VENT. PREPARE DUCT END FOR NEW CONNECTION. REPLACE VENT AFTER ROOF WORK IS COMPLETE.
- (16) LEAVE EXISTING FLASHING IN TACK ON BRICK CHIMNEY AND RE-FLASH AROUND EXISTING CHIMNEY AFTER NEW ROOF WORK IS COMPLETE
- REMOVE ROOF CURB AND DISCONNECT EXISTING CONDENSING UNIT AND ELECTRICAL. EVACUATE ALL REFRIGERANT PIPING AND DISCONNECT. PREPARE PIPING FOR NEW CONNECTION AND PREPARE ROOF FOR NEW ROOF CURB. REPLACE CONDENSING UNIT AFTER COMPLETION OF WORK.
- (18) REMOVE ROOF CURB AND DISCONNECT AIR INTAKE AND DUCTWORK. PREPARE DUCT ENDS FOR NEW CONNECTION AND PREPARE ROOF FOR NEW ROOF CURB. REPLACE AIR INTAKE AND RECONNECT DUCTWORK AFTER COMPLETION OF
- REMOVE 34" HOSE BIBB AND PIPING BACK TO WHERE
- SURFACE FOR NEW ROOF CURB.
- REMOVE ELEVATOR ROOF CURB AND CAP. PREPARE ROOF SURFACE FOR FOR NEW ROOF

(E)ROOF SUMP

(E)¾" CW HOSE BIBB-

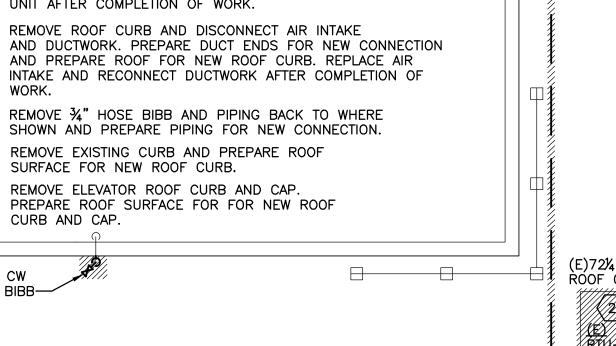

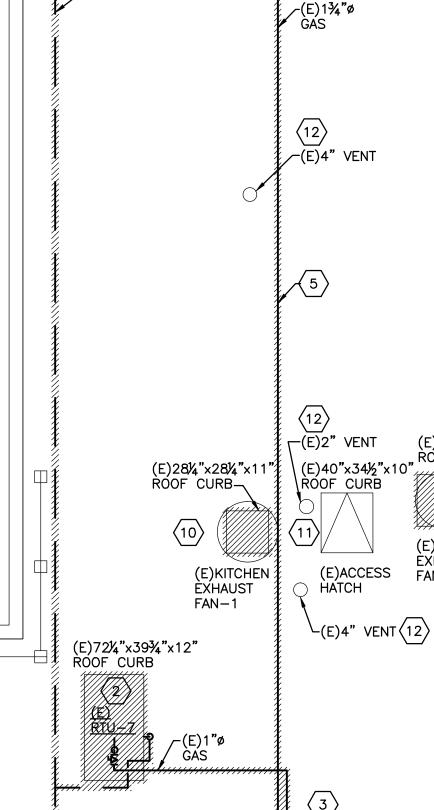

┌(E)¾"ø CONTROL

(E)81"x60¾"x13"

ROOF CURB

WIRING AND

CONDUIT

**GENERAL NOTES:** 

ACCEPTABLE MANNER.

AUTHORITIES HAVING JURISDICTION.

DURING THE DEMOLITION WORK.

GAS(TYP.)

2. THE OWNER RESERVES THE RIGHT TO SALVAGE ON ALL

OWNER SHALL THEN BECOME THE CONTRACTOR'S

MATERIALS/ITEMS REMOVED. ANY ITEMS REJECTED BY THE

RESPONSIBILITY TO DISPOSE OF IN AN ENVIRONMENTALLY

3. THE CONTRACTOR SHALL NOTIFY THE ARCHITECT/ENGINEER OF

(E)70½"x40¾"x11"

-(E)¾"ø CONTROL

WIRING AND

CONDUIT

ROOF CURB

ANY PROBLEMS THAT MIGHT OCCUR PER SIGNED CONTRACT

,–(E)1¼"ø`

(E)ROOF SUMP

ĠÁS

(E)79¾"×60¾"×11½"

(E)34¼"x34"x10"

(E)KITCHEN

∕-(E)1"ø GAS

(E)71"x40¼"x13½"


EXHAUST


FAN-2


(E)ROOF

(E)70¼"x40"x13"

ROOF CURB

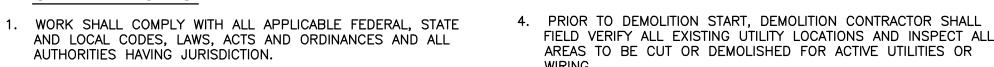

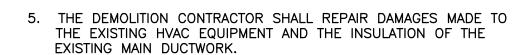

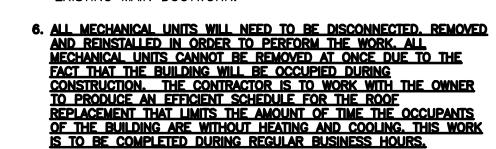

(E)70¼"×40¾"×11½"↓

ROOF CURB



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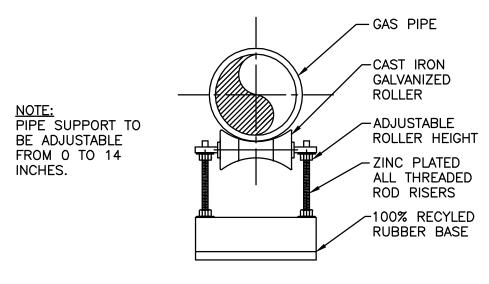
Sheet Title:

**MECHANICAL ROOF PLAN -DEMOLITION** 

Sheet Number:



M-120



GAS-\

2½"ø

(E) REFRIGERANT

(E)10"ø (E)ACCESS EXHAUST—HATCH

(E)ACU-2 FOR IDF ROOM

(E)ACU-3 FOR ELEVATOR

(E)36" HIGH BRICK CHIMNEY

GAS

GAS

(E)ROOF SUMP

13

(E)ACCU-1 CHILLER

(E)ROOF SUMP

ELEVATOR ROOF CAP


<u>(E)RTU-6</u>

¾"ø

\\_3⁄4"ø

GAS

(E)RTU-3

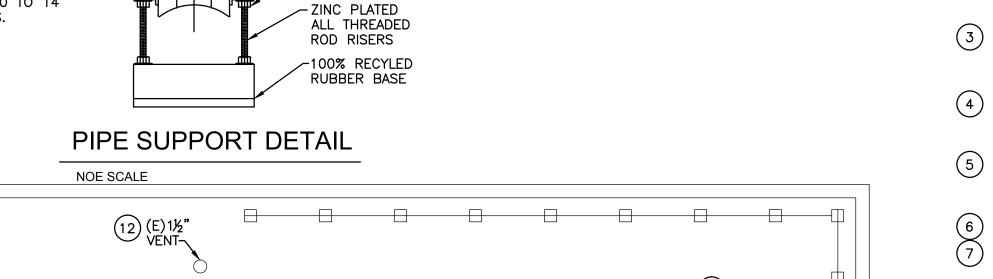

(18)

(E)INTAKE HOOD-A

(E)ROOF SUMP

7 (E)16"x14" ECONOMIZER

DUCT —

(7) (E)25"x16"

(E)ACCESS HATCH

3

(E)ROOF SUMP

(E)4" VENT-

(E)EHAUST

FAN EF-1

20 (E)3" VENTS

<u>(E)INTAKE</u> <u>HOOD-B</u>

(E)ACU-1 MDF ROOM

ÈCONOMIZER

GAS

GAS

GAS

GAS

∕-2"ø

GAS

(E)4" VENT—

GAS

#### **NEW WORK KEY NOTES**

- NEW ROOF CURB AND CAP.
- NEW ROOF CURB. REPLACE EXISTING RTU AND EXTEND ALL SERVICES TO TOP OF ROOF CURB INCLUDING GAS, REFRIGERANT, ELECTRICAL CONDUIT AND PIPING. PUMP NEW REFIRIGERANT BACK INTO SYSTEM.
- (3) EXTEND STORM WATER PIPING AND RECONNECT ROOF SUMPS TO EXTENDED PIPING AT NEW ROOF ELEVATION. RE-INSTALL ALL EXISTING ROOF SUMP STRAINERS.
- (4) NEW GAS PIPING AND PIPE SUPPORTS (SEE PIPE SUPPORT DETAIL). RECONNECT TO ALL ROOF TOP UNITS WITH NEW ISOLATION VALVE.
- REMOVE TEMPORARY PIPE CAP AND PROVIDE NEW 2½" REDUCER & 2½" GAS ISOLATION VALVE. PROVIDE LIVE TAP TO INSTALL. GAS MAIN TO REMAIN ACTIVE DURING CONSTRUCTION.
- NEW PATE PIPE CURB.
- NEW ROOF CURB. RECONNECT EXISTING DUCTWORK AND INSULATE BEFORE SHEET METAL ENCLOSURE IS REINSTALLED. EXTEND DUCTWORK AS REQUIRED TO TOP OF NEW CURB.
- REINSTALL EXISTING SHEET METAL DUCT ENCLOSURE AND DUCTWORK WITH NON-PENETRATING SUPPORTS.
- 9 RECONNECT ELECTRICAL CONDUITS AND PANEL. EXTEND ALL CONDUIT AS REQUIRED TO MEET NEW ROOF ELEVATION.
- NEW ROOF CURB. RECONNECT ALL ELECTRICAL CONNECTIONS AND EXISTING DUCTWORK AND EXTEND TO TOP OF NEW ROOF CURB, REINSTALL EXISTING EXHAUST FAN.
- ROOF HATCH BY ARCHITECTURAL TRADES.
- EXTEND EXISTING ROOF VENT A MINIMUM OF 12" ABOVE NEW ROOF ELEVATION AND REFLASH.
- NEW ROOF RAILS. RECONNECT ALL ELECTRICAL, CONDENSATE AND REFRIGERANT PIPING. EXTEND ALL SERVICES AS REQUIRED TO NEW ROOF ELEVATION. REINSTALL EXISTING CHILLER CONDENSING UNIT. PUMP NEW REFRIGERANT BACK INTO SYSTEM.
- NEW ROOF CURB. EXTEND EXISTING 10" FLUE DUCT TO TOP OF NEW CURB AND RECONNECT TO EXISTING FLUE. MAINTAIN FLUE DUCT OPENING A MINIMUM OF 60 INCHES ABOVE NEW ROOF.
- 15) NEW ROOF CURB. EXTEND EXISTING 10" AIR INTAKE TO TOP OF NEW CURB AND RECONNECT TO EXISTING AIR INTAKE. MAINTAIN INTAKE OPENING A MINIMUM OF 36 INCHES ABOVE NEW ROOF.
- REFLASH AROUND EXISTING CHIMNEY AT NEW ROOF ELEVATION.
- NEW ROOF CURB. REINSTALL EXISTING CONDENSING UNIT AND EXTEND ALL SERVICES TO TOP OF ROOF CURB INCLUDING, REFRIGERANT PIPING AND ELECTRICAL. PUMP NEW REFRIGERANT BACK INTO SYSTEM.
- NEW ROOF CURB. REINSTALL EXISTING AIR INTAKE AND EXTEND EXISTING DUCTWORK TO TOP OF NEW
- EXTEND EXISTING 34"DOMESTIC COLD WATER ALONG ROOF 10'-0" FROM ROOF EDGE. RE-CONNECT ¾" HOSE BIBB AND INSTALL ¾" VACUUM BREAKER ON LINE. PROVIDE ROOF SUPPORTS AS REQUIRED. MOUNT HOSE BIBB

(E)ROOF SUMP

(E)¾" CW -


19¾" CW—

⊕¾"VACUUM BREAKER

ROOF CURB. A MINIMUM OF 12" ABOVE NEW ROOF ELEVATION. NEW ROOF CURB. REPLACE EXSTING VENT PIPES AND EXTEND EXISTING VENT PIPING TO TOP OF NEW ROOF CURB.

- **GENERAL NOTES:**
- 1. LOCATION OF ALL HVAC EQUIPMENT FOR REFERENCE ONLY. ACTUAL LOCATION OF EQUIPMENT TO BE CONFIRMED BY GENERAL CONTRACTOR AND MECHANICAL CONTRACTOR.
- 2. PROVIDE EXTERIOR INSULATION TO ALL DUCTWORK (GLASS FIBER BOARD 2"-6 LBS/CU FT. NOMINAL DENSITY).
- 3. COORDINATE WITH OTHER TRADES FOR CLEARANCES.
- 4. GENERAL CONTRACTOR TO PROVIDE LABOR AND MATERIAL FOR REQUIRED ROOF CURBS.
- 5. UPON COMPLETION OF THE MECHANICAL TRADES WORK, ALL SYSTEMS SHALL BE TESTED, BALANCED AND ADJUSTED BY CONTRACTOR. ALL SYSTEMS SHALL BE LEFT IN WORKING ORDER.
- 6. ALL DUCTWORK SHALL BE SHEET METAL AND ALL PIPING AND TUBING REQUIRED FOR EXTENSION TO NEW ROOF SURFACE SHALL BE LIKE IN KIND TO EXISTING.
- 7. CONTRACTOR SHALL BE RESPONSIBLE FOR THE REMOVAL OF ALL DEBRIS LEFT BY THE MECHANICAL TRADES.

REFER TO SHEET M-120 FOR "CONTROLS

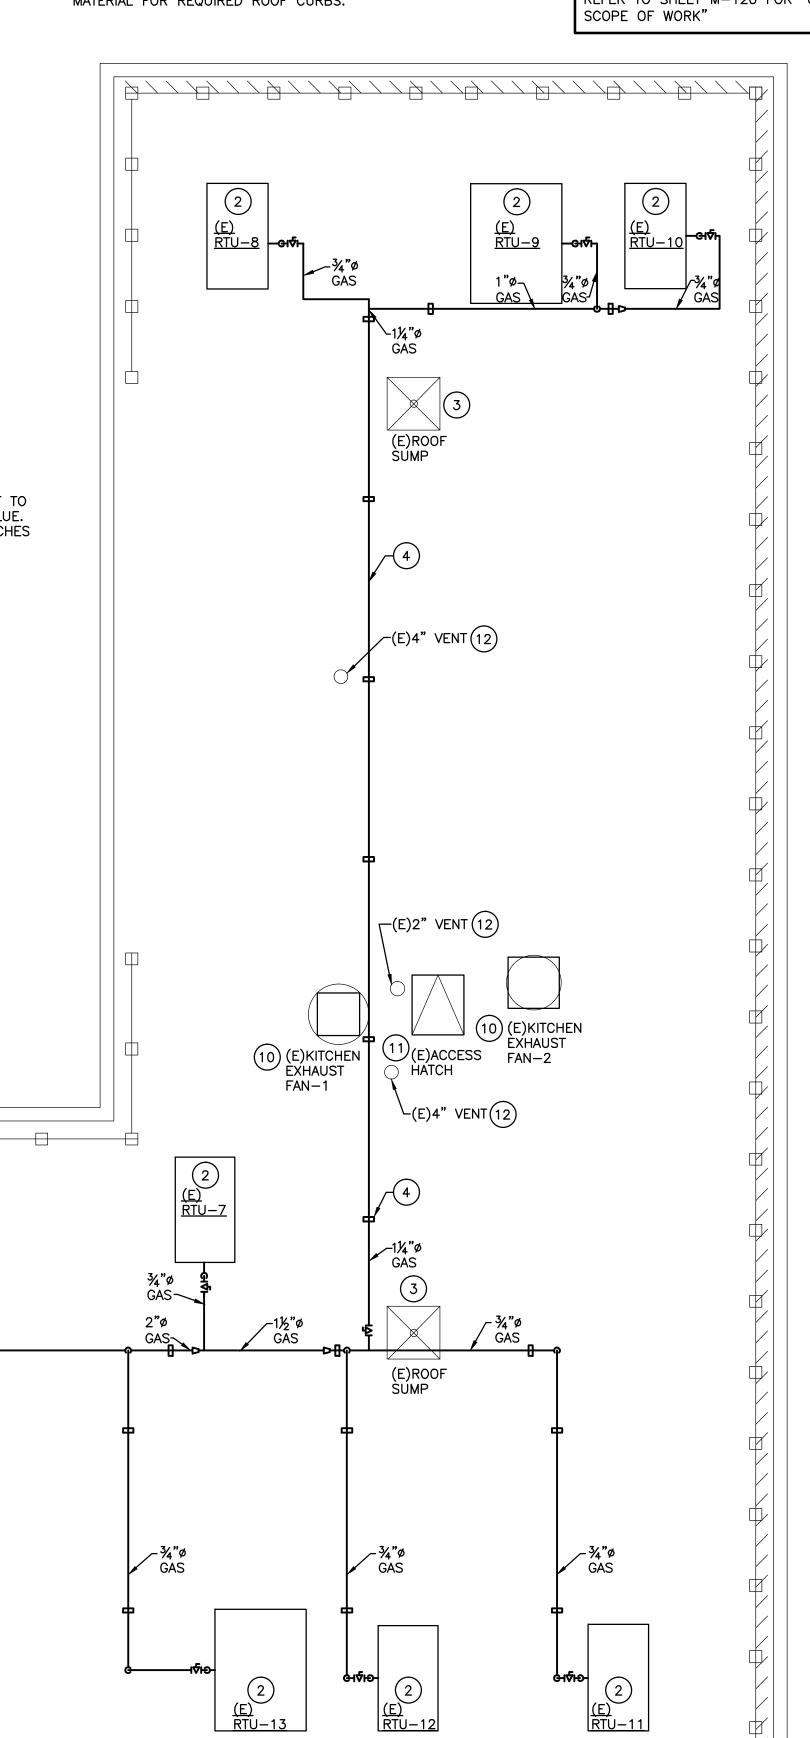



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# WAYNE STATE

WSU - FACILITIES PLANNING & **MANAGEMENT DETROIT MICHIGAN** 

Project Title:

ROOF REPLACEMENT SCHOOL OF SOCIAL **WORK BUILDING** 

Date:	Issued for:
03-22-18	OWNER REVIEW
03-23-2018	OWNER REVIEW
05-01-2018	BIDS
07-24-2018	BIDS

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Project Number:

217031.00

Sheet Title:

**MECHANICAL ROOF PLAN -NEW WORK** 

Sheet Number:



### ELECTRICAL SHEET INDEX

SHEET DESCRIPTION

E-000 SYMBOLS AND LEGENDS

E-001 ELECTRICAL ROOF DEMOLTION PLAN

E-101 ELECTRICAL ROOF NEW WORK



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### ELECTRICAL ABBREVIATION LIST

ELECTRICAL SYMBOL LIST

PHOTOELECTRIC CONTROLLER

HARD WIRE POWER CONNECTION

DUPLEX RECEPTACLE

**DESCRIPTION** 

<u>SYMBOL</u>

ABBREVATION	DESCRIPTION	ABBREVATION	DESCRIPTION	ABBREVATION	DESCRIPTION
A	AMPHERE	GFI	GROUND FAULT INTERRUPTER	NC	NORMALLY CLOSED
AFF	ABOVE FINISH FLOOR	GRD	GROUND	NF	NON-FUSIBLE
AFG	ABOVE FINISH GRADE	GRC	GALVANIZED RIGID CONDUIT	NIC	NOT IN CONTRACT
AHU	AIR HANDLING UNIT	HOA	HAND-OFF-AUTO	NL	NIGHT LIGHT
AIC	AMPS INTERRUPTING CAPACITY	HP	HORSEPOWER	NO	NORMALLY OPEN
		HZ	HERTZ	NTS	NOT TO SCALE
BKR	BREAKER	112	HEINIZ		
BPS	BOLTED PRESSURE SWITCH	IG	ISOLATED GROUND	RECEPT.	RECEPTACLE
				RP	RECEPTACLE PANEL
CB	CIRCUIT BREAKER	JB	JUNCTION BOX	RTU	ROOF TOP UNIT
CIR/CKT	CIRCUIT				
CLG	CEILING	KW	KILOWATT	SD	SMOKE DETECTOR
CP	CIRCULATION PUMP	KWH	KILOWATT - HOURS	SPEC	SPECIFICATION
CUH	CABINET UNIT HEATER	KVA	KILO VOLT-AMPERES		
				TELCOM	TELECOMMUNICATIONS
DED	DEDICATED	LP	LIGHTING PANEL	TYP	TYPICAL
DISC	DISCONNECT	L0	LOCK-ON		
DP	DISTRIBUTION PANEL			UH	UNIT HEATER
DWG	DRAWING	MCA	MINIMUM CIRCUIT AMPACITY	U.O.N.	UNLESS OTHERWISE NOTED
		MCB	MAIN CIRCUIT BREAKER		
EBU	EMERGENCY BATTERY UNIT	MCC	MOTOR CONTROL CENTER	WP	WEATHERPROOF
EF	EXHAUST FAN	MDP	MAIN DISTRIBUTION PANEL	WG	WIRE GUARD
EM	EMERGENCY	MLO	MAIN LUGS ONLY		
EM/NL	EMERGENCY/NIGHT LIGHT	MSB	MAIN SWITCHBOARD	T#	TRANSFORMER
EUH	ELECTRIC UNIT HEATER	MTD	MOUNTED	<del>"</del>	
EWC	ELECTRIC WATER COOLER	MUA	MAKE-UP AIR UNIT	(E)	EXISTING
EWH	ELECTRIC WATER HEATER				
				(R)	RELOCATED
FLA	FULL LOAD AMPS			(N)	
F	FUSE			(N)	NEW


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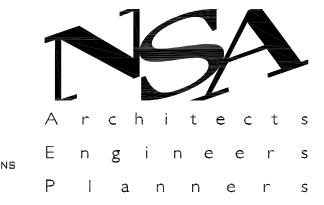
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ELECTRICAL SYMBOLS LIST

Sheet Number:

E-000



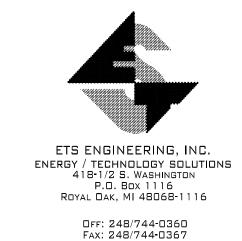

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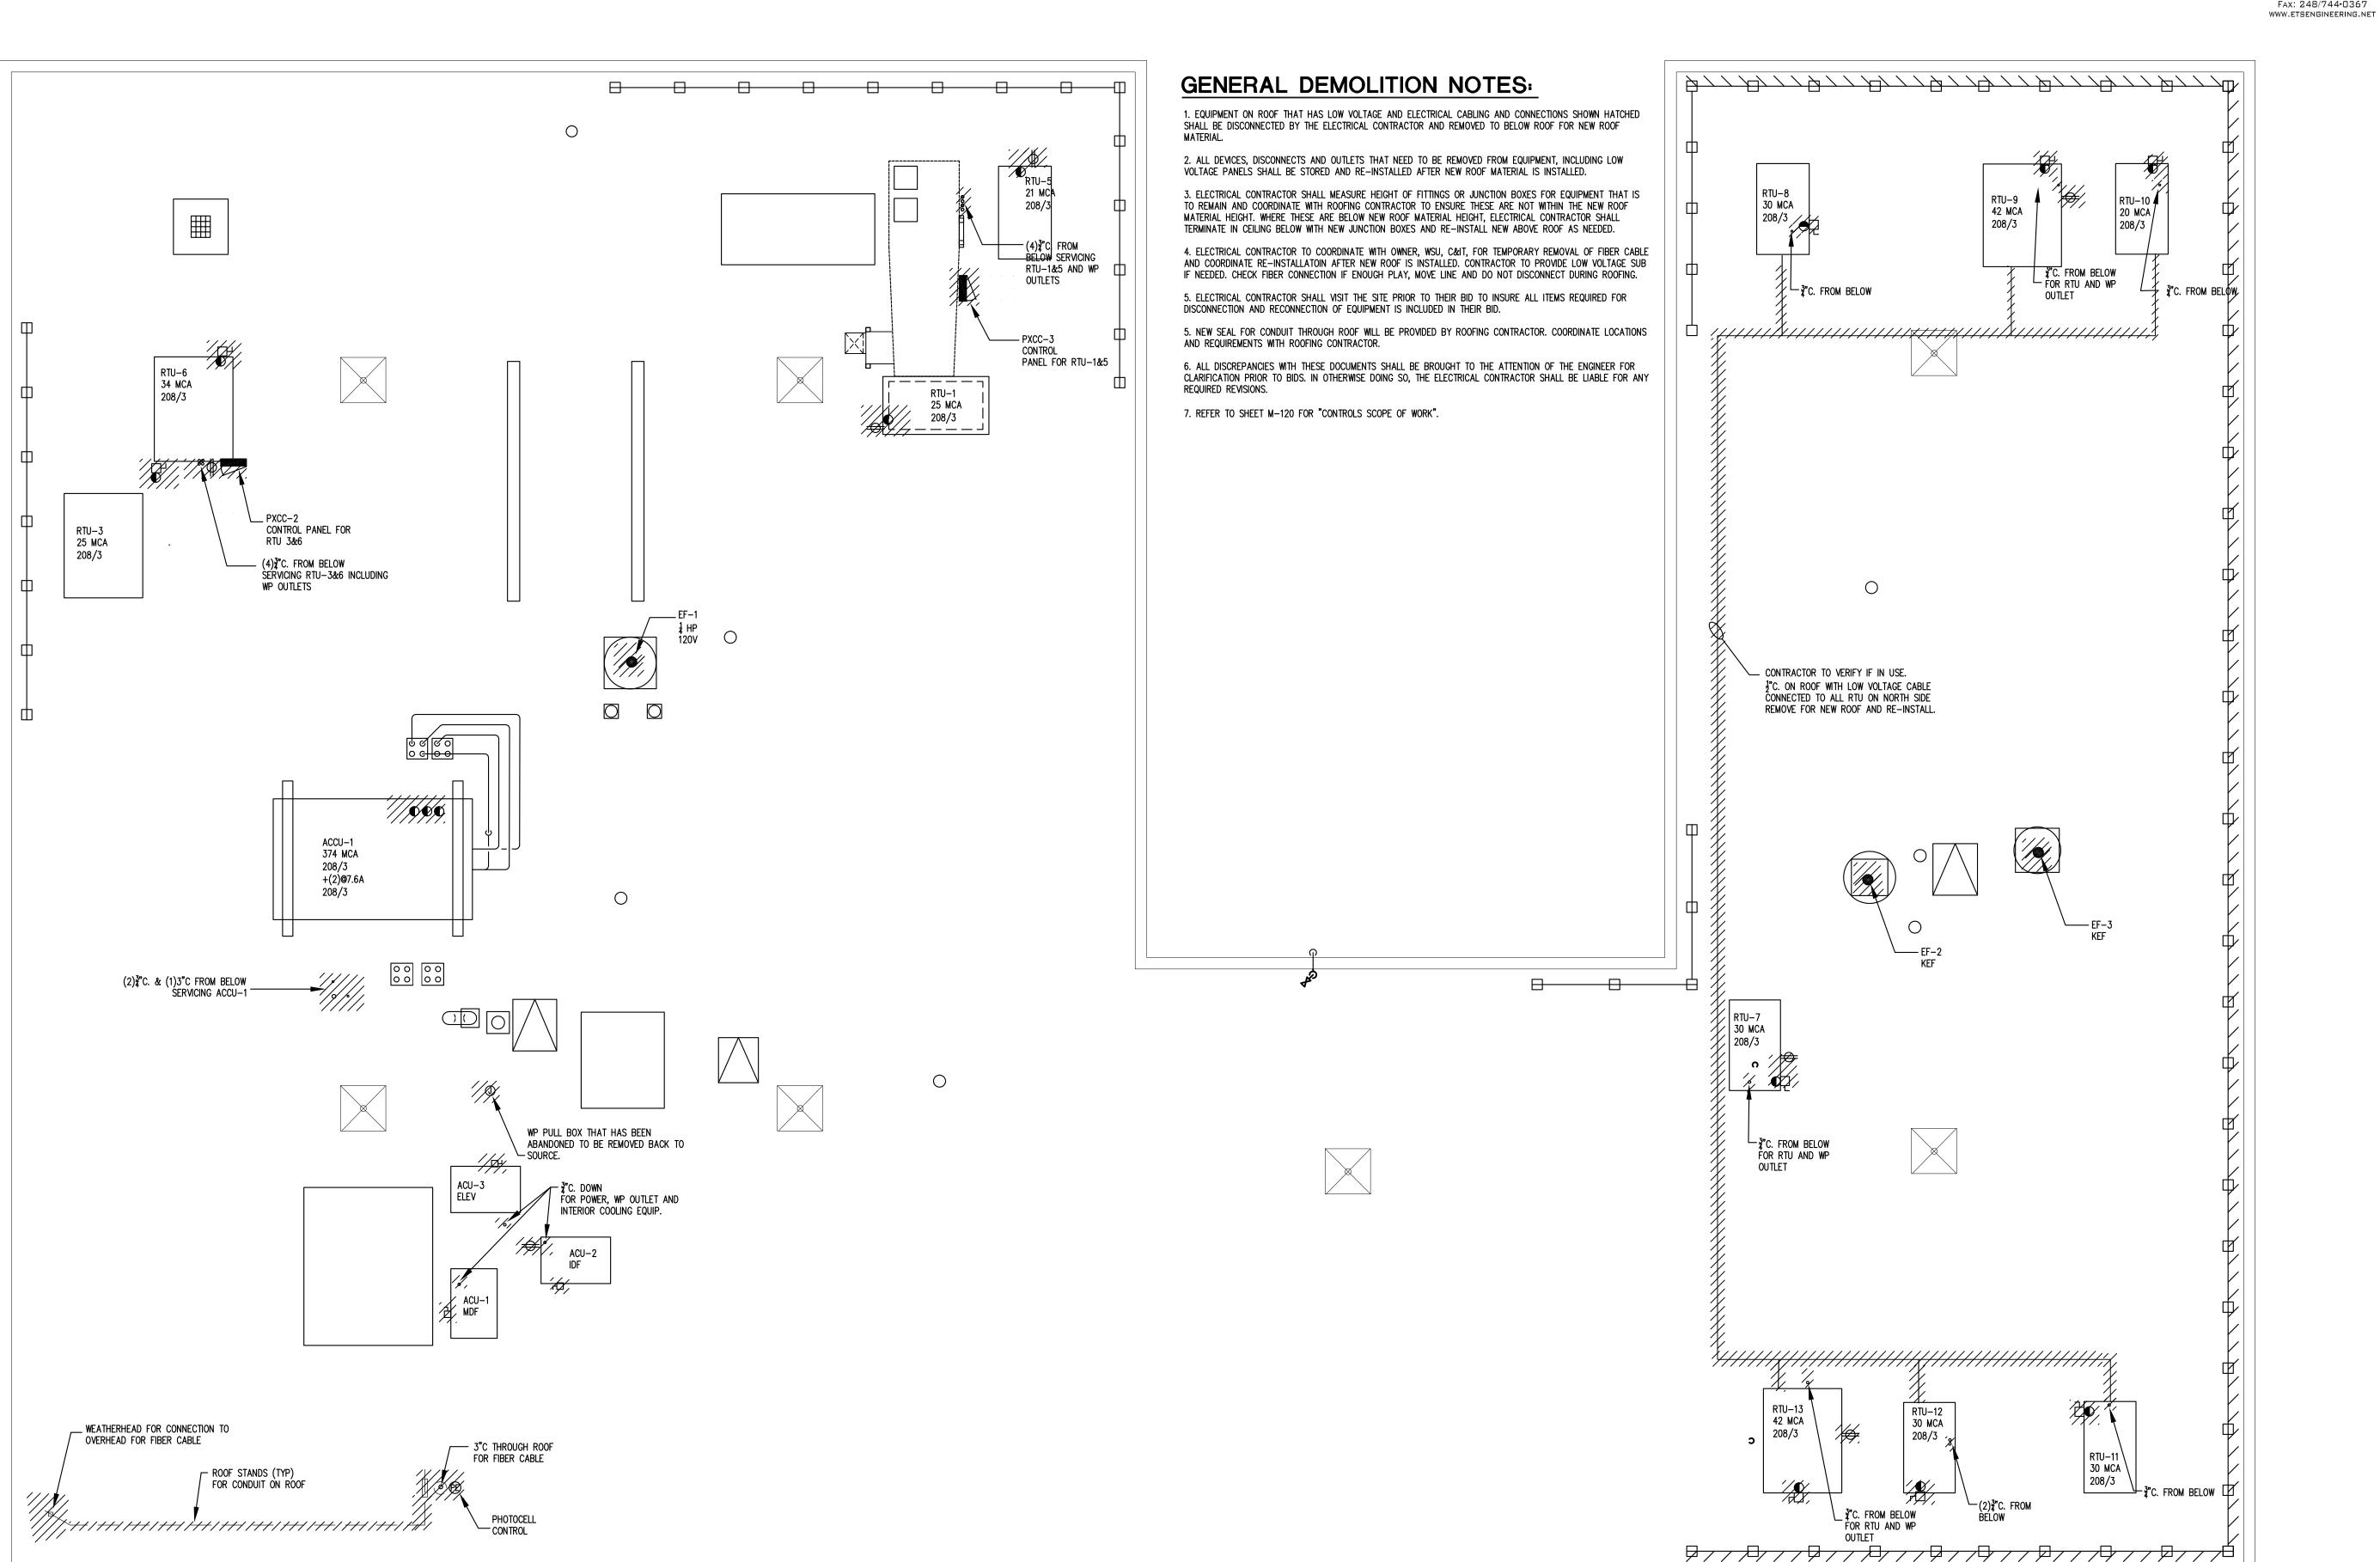
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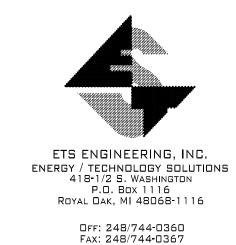
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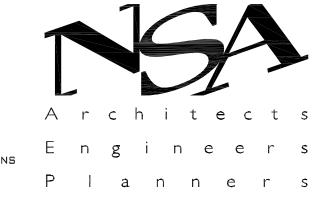
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**ROOF PLAN** 









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Sheet Title: **ELECTRICAL NEW ROOF** PLAN

Sheet Number:

