

# SCHOOL OF SOCIAL WORK - PHASE 2


5447 WOODWARD DETROIT, MI 48202

## ASBESTOS ABATEMENT SERVICES

WSU PROJECT # 063-301464

Issued: June 20, 2 0 1 9

Issued for Reference Only

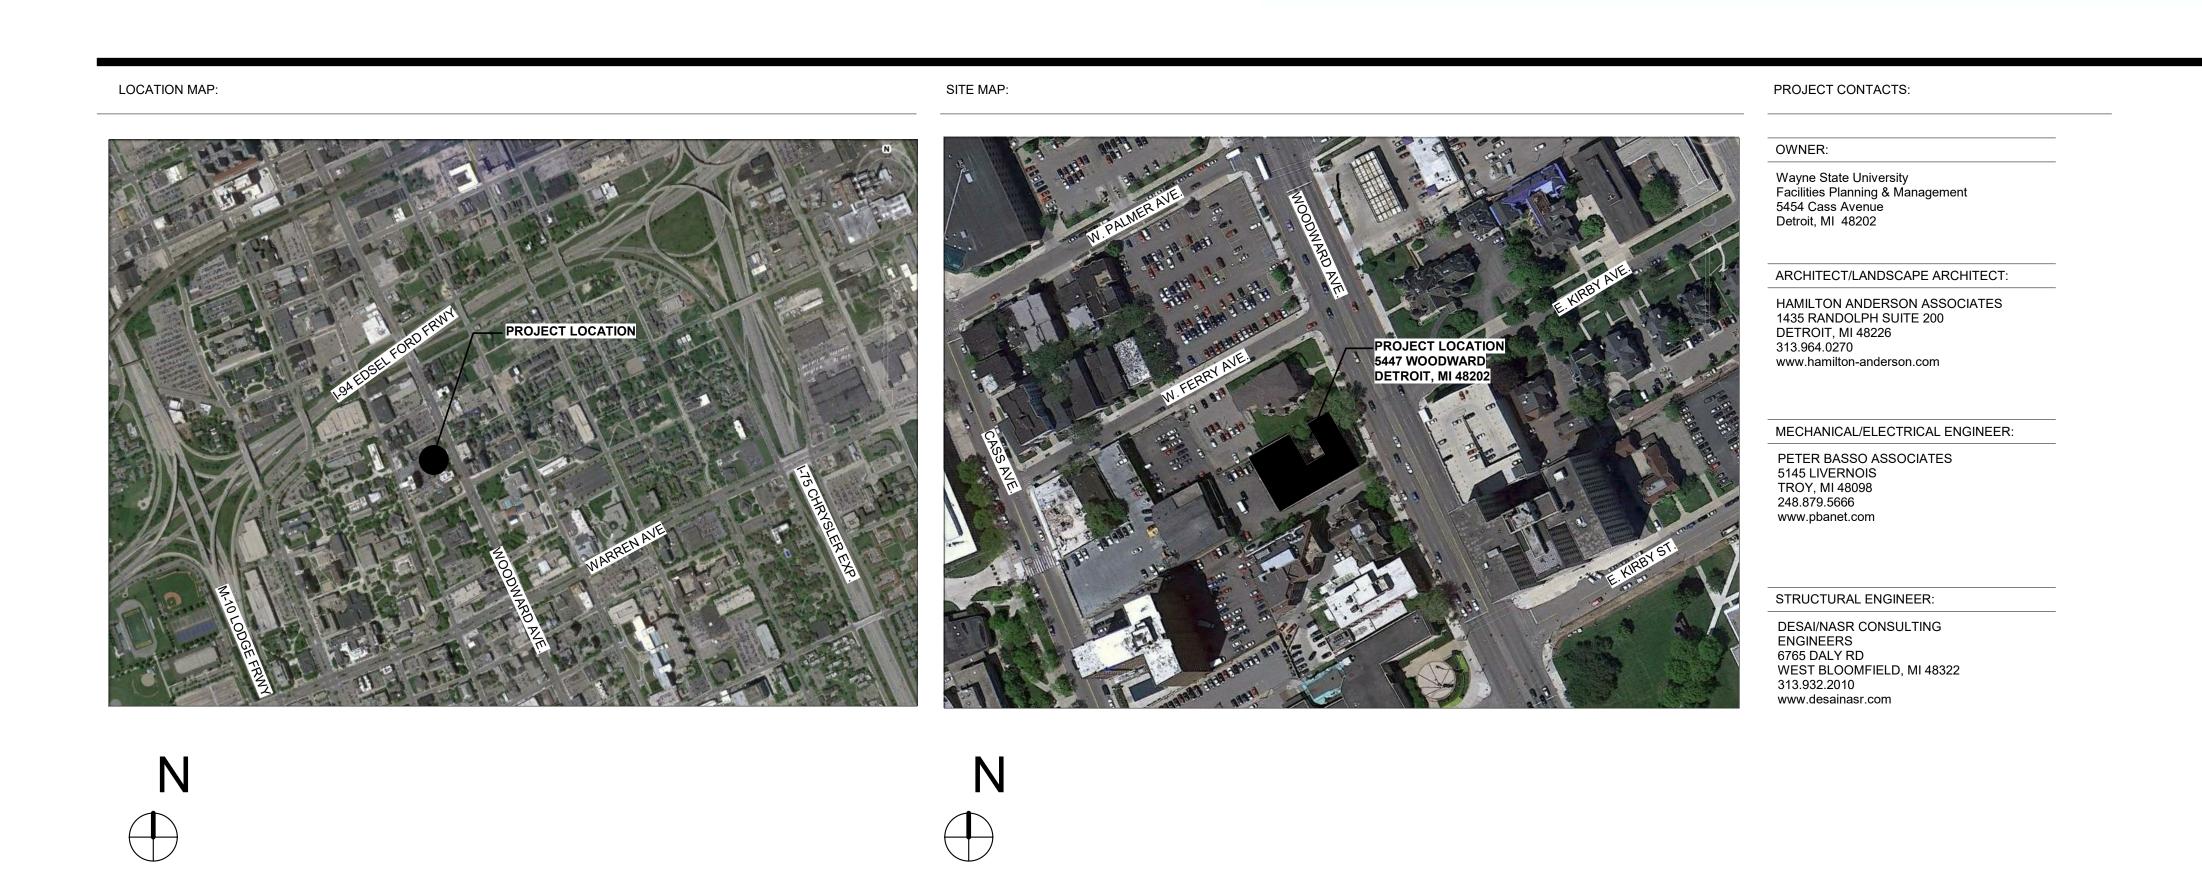

Issued for Reference Only

**CEILINGS**:

WHERE CEILING IS INDICATED TO REMAIN: REMOVE ALL CEILING MOUNTED EQUIPMENT. REMOVE DUST, DIRT AND DEBRIS. REMOVE ALL LOOSE AND PEELING PAINT.

REMOVE ALL CEILINGS, SOFFITS, AND SUPPORT SYSTEMS UNLESS OTHERWISE INDICATED: REMOVE ALL CEILING MOUNTED EQUIPMENT, RAILS, LIGHTS, GRILLES, PANELS, TILES, FRAMING AND SUSPENSION SYSTEMS. REMOVE ALL ORIGINAL PLASTER AND LATH CEILINGS TO EXPOSE CONCRETE STRUCTURE.

PLASTER CEILINGS IN STAIRWELLS AND LANDINGS TO REMAIN. U.N.O. REMOVE DUST, DIRT AND DEBRIS. REMOVE ALL LOOSE AND PEELING PAINT FROM PLASTER OR GYP BOARD.

REMOVE CEILING, BLOCKING AND WINDOW TREATMENT REQUIRED FOR EXTERIOR WINDOW REPLACEMENT. WINDOW TREATMENT TO BE REMOVED AND NUMBERED FOR REINSTALLATION.

WHERE COLUMNS AND EXISTING PLASTER, GYP BOARD, (W.1) CMU OR CONCRETE WALLS ARE TO REMAIN: REMOVE ALL LOOSE AND PEELING PAINT.

 $\left<\mathrm{W.2}\right>$  FEATURE WALL TO REMAIN.

REMOVE EXISTING TILE, GROUT, AND PLASTER FROM WALLS AND COLUMNS

REMOVE EXISTING WALL PANELS AND FASTENERS.

EXISTING BRICK WALL TO REMAIN. REMOVE ANY ITEMS AFFIXED TO WALL

FLOORS:

EXISTING VINYL/RESILIENT OR LINOLEUM TILE OR TERRAZZO ⟨ F.1 ⟩ INDICATED TO REMAIN: REMOVE ALL DEBRIS, DUST AND DIRT.

REMOVE ALL EXISTING CERAMIC OR CLAY TILE FLOORS AND  $\langle$  F.2  $\rangle$  BASE DOWN TO STRUCTURAL SLAB.

REMOVE EXISTING WALL BASE, AND REMOVE FLOOR FINISH  $^{\prime}$  DOWN TO STRUCTURAL SLAB.

REMOVE ALL CARPET, WALL BASE AND ADHESIVE DOWN TO STRUCTURAL SLAB.

WHERE EXISTING PAINTED AND FRAMED DOORS ARE TO REMAIN: REMOVE ALL LOOSE AND PEELING PAINT. REMOVE

DOOR SCHEDULE.

⟨ 0.1 ⟩ HARDWARE FOR REPLACEMENT WHERE INDICATED IN THE

REMOVE DOOR, HARDWARE AND FRAME IN ITS ENTIRETY. PREMOVE SIDELIGHTS & TRANSOMS WHERE APPLICABLE.

 $\langle 0.3 \rangle$  NOT USED

REMOVE INDICATED EXTERIOR WALL FOR INSTALLATION OF NEW LINTEL & FRAME. SEE STOREFRONT SCHEDULE ON SHEET A3.1.1 AND DETAILS ON SHEET A4.2.1.

EXISTING STAINED DOORS ARE TO BE REMOVED & NUMBERED O.5 FOR REINSTALLATION OR RELOCATION. REMOVE HARDWARE FOR REPLACEMENT WHERE INDICATED.

REMOVE INDICATED PORTION OF THE PARTITION FOR INSTALLATION OF NEW LINTEL AND FRAME; SEE DOOR ⟨ O.6 ⟩ SCHEDULE SHEET A7.1.1 FOR DOOR SIZES AND SHEET A4.1.1 FOR NEW LINTEL.

 $\langle$  M.1  $\rangle$  ALL CABINETRY AND MILLWORK IS TO BE REMOVED IN ITS ENTIRETY.

 $\langle$  M.2  $\rangle$  REMOVE PLUMBING, KITCHEN EQUIPMENT, CABINETS AND COUNTER TOPS COMPLETE

ALL SINKS, DRINKING FOUNTAINS, TOILETS, LAVATORIES, URINALS, TUB/SHOWERS AND WALL-MOUNTED TOILET ⟨ M.3 ⟩ ROOM ACCESSORIES ARE TO BE REMOVED UNLESS SPECIFICALLY NOTED TO BE SALVAGED. SEE PLUMBING DRAWINGS FOR MORE INFORMATION.

⟨M.4⟩ REMOVE DUMBWAITER AND SHAFT

⟨ M.5 ⟩ REMOVE MECHANICAL SHAFT; FILL HOLES IN CONCRETE SLAB ABOVE &/OR BELOW; SEE SHEET A4.1.1

(M.6) REMOVE LOWER WOOD HANDRAILS. TOP RAIL TO REMAIN

EXISTING JANITOR'S CLOSET TO REMAIN INCLUDING M.7 FINISHES AND PLUMBING FIXTURES

⟨ M.8 ⟩ REMOVE FIRE EXTINGUISHER EQUIPMENT

REMOVE WINDOW SILLS AS REQUIRED FOR WINDOW M.9 REPLACEMENT

NEW FLOOR PENETRATION. COORDINATE WITH (M.10) MECHANICAL. PENETRATIONS NOT TO INTEFERE WITH CONCRETE WEB JOISTS- REFER TO STRUCTURAL DETAILS (SHEET A4.1.1).

EXISTING STAIR SIGANGE TO BE REMOVED AND NUMBERED FOR REINSTALLATION.

OWNER IS RESPONSIBLE FOR HAZARDOUS MATERIAL REMEDIATION. GC TO COORDINATE HAZARDOUS MATERIAL REMEDIATION. REFER TO HAZARDOUS MATERIAL REPORT FROM OWNER.

#### **DEMOLITION GENERAL NOTES**

1. CONTRACTOR SHALL PROVIDE DEMOLITION AS REQUIRED FOR NEW CONSTRUCTION. REFER TO CONTRACT DOCUMENTS FOR EXTENT OF NEW WORK.

2. CONTRACTOR SHALL VISIT SITE TO VERIFY ACTUAL EXTENT OF DEMOLITION PRIOR TO BID. DO NOT RELY SOLELY ON THE DRAWINGS FOR DEMOLITION SCOPE. ALL DEMOLITION REQUIRED TO CARRY OUT THE WORK OF THE CONTRACT SHALL BE PART OF THE CONTRACT. NO ADDITION TO THE CONTRACT AMOUNT WILL BE ALLOWED DUE TO FAILURE TO FIELD VERIFY DEMOLITION SCOPE OR FAILURE TO EXAMINE ALL CONTRACT DOCUMENTS.

3. VERIFY AND INVESTIGATE ALL CONDITIONS IN THE FIELD PRIOR TO STARTING DEMOLITION, NOTIFY ARCHITECT OF DISCREPANCIES. LOCATE AND IDENTIFY SERVICES TO REMAIN IN OPERATION, INCLUDING ALL UTILITY LINES PENETRATING FLOOR, UNDOCUMENTED CONDITIONS, UTILITY RISERS, ETC.

4. PRIOR TO CUTTING EXISTING CONSTRUCTION, DETERMINE THE PRESENCE OF AND PROTECT ACTIVE TELECOMMUNICATION, DATA & ELECTRICAL LINES AND PIPING WHICH MAY BE DAMAGED BY SUCH CUTTING.

5. COORDINATE DEMOLITION WITH OWNER'S REQUIREMENTS AND OTHER CONTRACTORS RETAINED BY THE OWNER.

6. CONTROL NOISE, VIBRATION, AND ANY OTHER DISTURBING FACTORS. COORDINATE WORK HOURS WITH OWNER PRIOR TO PROCEEDING WITH THE WORK

7. CONTRACTOR TO FOLLOW OWNER'S REQUIREMENTS FOR ENSURING SECURITY AND SAFETY OF THE BUILDING THROUGH DEMOLITION & CONSTRUCTION.

8. SCHEDULE ALL DEMOLITION AND CONSTRUCTION WORK WITH DESIGNATED OWNER'S REPRESENTATIVE TO MINIMIZE DISRUPTION OF BUILDING ACTIVITIES.

9. FOLLOW REQUIREMENTS IN SMACNA IAQ GUIDELINES FOR OCCUPIED BUILDING UNDER CONSTRUCTION 1995 CHAPTERS 2 & 3 AS WELL AS ANY OTHER APPLICABLE ENVIRONMENTAL REQUIREMENTS.

10. CONTRACTOR IS TO PROVIDE COMPLETE DUST PROOF ENCLOSURE IN ALL AREAS WHERE DEMOLITION IS TO OCCUR. COMPLY WITH ALL OSHA, NFPA AND OTHER APPLICABLE RULES AND REGULATIONS REGARDING DUST AND DEBRIS REMOVAL.

11. UTMOST CARE MUST BE TAKEN DURING DEMOLITION TO ENSURE THAT EXISTING CONSTRUCTION TO REMAIN IS NOT DAMAGED. REPAIR OR REPLACE EXISTING CONSTRUCTION DAMAGED BY DEMOLITION ACTIVITIES.

PRIOR TO THE START OF DEMOLITION. TARGET 50% RECYCLING OF CONSTRUCTION WASTE.

12. PROVIDE CONSTRUCTION WASTE MANAGEMENT PLAN

13. REMOVE AND REINSTALL ITEMS TO BE SALVAGED WHERE INDICATED AND WHERE ADVISED BY OWNER.

14. INVENTORY AND PHOTOGRAPH SALVAGED ITEMS: LIST SHALL INCLUDE DESCRIPTION OF ITEM, DIMENSIONS (OVERALL WIDTH, HEIGHT, DEPTH), COLOR, APPROX. WEIGHT AND PHOTO.

15. CONTRACTOR SHALL PROTECT ALL STRUCTURAL ELEMENTS FROM DAMAGE DURING CONSTRUCTION.

16. PROTECT EXISTING EXTERIOR DOORS, WINDOWS, GLAZING, AND FRAMES.

17. PROTECT EXISTING INTERIOR DOORS, WINDOWS,

18. REFER TO SPECIFICATIONS FOR ADDITIONAL

GLAZING, AND FRAMES, THAT ARE TO REMAIN (TYP.)

DEMOLITION REQUIREMENTS. 19. ALL SURFACES THAT ARE TO REMAIN ARE TO BE CLEANED W/ WATER & DETERGENT PRIOR TO INSTALLATION

OF NEW FINISHES 20. SEE MECHANICAL, ELECTRICAL AND PLUMBING

DRAWINGS FOR ADDITIONAL DEMOLITION INFORMATION. 21. WHEN REMOVING MECHANICAL, ELECTRICAL AND

PLUMBING ITEMS, REMOVE ALL ASSOCIATED FASTENERS,

22. DO NOT PROCEED WITH NEW FLOOR OPENINGS OR WALL OPENINGS UNTIL NEW SUPPORT STRUCTURE IS IN PLACE, SEE STRUCTURAL DETAILS (SHEET A4.1.1).

**DEMOLITION LEGEND** 

REMOVE WALL COMPLETE EXISTING STUD & GYP/PLASTER CONSTRUCTION TO REMAIN, U.N.O.

CABLE, RODS, ETC.

REMOVE DOOR, FRAME, AND HARDWARE COMPLETE EXISTING DOOR AND FRAME TO

EXISTING TERRAZZO STAIR / LANDING

AREA OF WORK (BASE PROJECT)

Seal: Signature:

HamiltonAnderson

Hamilton Anderson Associates, Inc

p 313 964 0270 f 313 964 0170

www.hamilton-anderson.com

1435 Randolph Suite 200

Detroit, Michigan 48226

MEP Engineer

Structural Engineer

FP&M

Key Plan:

5454 Cass Avenue

Detroit, Michigan

architecture landscape architecture urban design

Peter Basso Associates

Desai/Nasr Consulting Engineer

West Bloomfield, MI 48322

5145 Livernois

Troy, MI 48098

248.879.5666

6765 Daly Rd

248.932.2010

WAYNE STATE

**JNIVERSITY** 

**WAYNE STATE UNIVERSITY** 

ASBESTOS ABATEMENT SERVICES

WSU PROJECT # 063-301464

Issued: June 20, 2 0 1 9

Issued for Reference Only

SCHOOL OF SOCIAL

5447 Woodward, Detroit, MI

**DEMOLITION PLAN** 

WSU Project No: 063-301464

Approved By: RH

WORK - PHASE 2

**LOWER LEVEL** 

Project Number: 2013088.22

Drawn By: HM/JAM

Scale: 1/8" = 1'-0"

Drawing No:

PLASTER CEILINGS IN STAIRWELLS AND LANDINGS TO REMAIN. U.N.O. REMOVE DUST, DIRT AND DEBRIS. REMOVE ALL LOOSE AND PEELING PAINT FROM PLASTER OR GYP BOARD.

REMOVE CEILING, BLOCKING AND WINDOW TREATMENT REQUIRED FOR EXTERIOR WINDOW REPLACEMENT. WINDOW TREATMENT TO BE REMOVED AND NUMBERED FOR REINSTALLATION.

WHERE COLUMNS AND EXISTING PLASTER, GYP BOARD,  $\langle$  W.1 angle CMU OR CONCRETE WALLS ARE TO REMAIN: REMOVE ALL LOOSE AND PEELING PAINT.

FEATURE WALL TO REMAIN.

REMOVE EXISTING TILE, GROUT, AND PLASTER FROM WALLS AND COLUMNS

REMOVE EXISTING WALL PANELS AND FASTENERS.

EXISTING BRICK WALL TO REMAIN. REMOVE ANY ITEMS AFFIXED TO WALL

REMOVE ALL CARPET, WALL BASE AND ADHESIVE DOWN TO / STRUCTURAL SLAB.

OPENINGS: WHERE EXISTING PAINTED AND FRAMED DOORS ARE TO

REMAIN: REMOVE ALL LOOSE AND PEELING PAINT. REMOVE ⟨ O.1 ⟩ HARDWARE FOR REPLACEMENT WHERE INDICATED IN THE DOOR SCHEDULE.

REMOVE DOOR, HARDWARE AND FRAME IN ITS ENTIRETY. O.2 REMOVE SIDELIGHTS & TRANSOMS WHERE APPLICABLE.

 $\langle 0.3 \rangle$  NOT USED

 $\left< _{ {\rm O.4}} \right>$  REMOVE INDICATED EXTERIOR WALL FOR INSTALLATION OF NEW LINTEL & FRAME. SEE STOREFRONT SCHEDULE ON SHEET A3.1.1 AND DETAILS ON SHEET A4.2.1.

EXISTING STAINED DOORS ARE TO BE REMOVED & NUMBERED O.5 FOR REINSTALLATION OR RELOCATION. REMOVE HARDWARE FOR REPLACEMENT WHERE INDICATED.

REMOVE INDICATED PORTION OF THE PARTITION FOR INSTALLATION OF NEW LINTEL AND FRAME; SEE DOOR ⟨ O.6 ⟩ SCHEDULE SHEET A7.1.1 FOR DOOR SIZES AND SHEET A4.1.1 oxdot for New Lintel.

⟨ M.1 ⟩ ALL CABINETRY AND MILLWORK IS TO BE REMOVED IN ITS

REMOVE PLUMBING, KITCHEN EQUIPMENT, CABINETS AND

ALL SINKS, DRINKING FOUNTAINS, TOILETS, LAVATORIES, URINALS, TUB/SHOWERS AND WALL-MOUNTED TOILET SPECIFICALLY NOTED TO BE SALVAGED. SEE PLUMBING

⟨ M.4 ⟩ REMOVE DUMBWAITER AND SHAFT

⟨ M.5 ⟩ REMOVE MECHANICAL SHAFT; FILL HOLES IN CONCRETE \_/ SLAB ABOVE &/OR BELOW; SEE SHEET A4.1.1

 $\langle$  M.6  $\rangle$  REMOVE LOWER WOOD HANDRAILS. TOP RAIL TO REMAIN

EXISTING JANITOR'S CLOSET TO REMAIN INCLUDING FINISHES AND PLUMBING FIXTURES

 $\langle$  M.8  $\rangle$  REMOVE FIRE EXTINGUISHER EQUIPMENT

REMOVE WINDOW SILLS AS REQUIRED FOR WINDOW M.9 REPLACEMENT

NEW FLOOR PENETRATION. COORDINATE WITH (M.10) MECHANICAL. PENETRATIONS NOT TO INTEFERE WITH CONCRETE WEB JOISTS- REFER TO STRUCTURAL DETAILS (SHEET A4.1.1).

EXISTING STAIR SIGANGE TO BE REMOVED AND NUMBERED FOR REINSTALLATION.

OWNER IS RESPONSIBLE FOR HAZARDOUS MATERIAL REMEDIATION. GC TO COORDINATE HAZARDOUS MATERIAL REMEDIATION. REFER TO HAZARDOUS MATERIAL REPORT FROM OWNER.

#### **DEMOLITION GENERAL NOTES**

1. CONTRACTOR SHALL PROVIDE DEMOLITION AS REQUIRED FOR NEW CONSTRUCTION. REFER TO CONTRACT DOCUMENTS FOR EXTENT OF NEW WORK.

2. CONTRACTOR SHALL VISIT SITE TO VERIFY ACTUAL EXTENT OF DEMOLITION PRIOR TO BID. DO NOT RELY SOLELY ON THE DRAWINGS FOR DEMOLITION SCOPE. ALL DEMOLITION REQUIRED TO CARRY OUT THE WORK OF THE CONTRACT SHALL BE PART OF THE CONTRACT. NO ADDITION TO THE CONTRACT AMOUNT WILL BE ALLOWED DUE TO FAILURE TO FIELD VERIFY DEMOLITION SCOPE OR FAILURE TO EXAMINE ALL CONTRACT DOCUMENTS.

3. VERIFY AND INVESTIGATE ALL CONDITIONS IN THE FIELD PRIOR TO STARTING DEMOLITION, NOTIFY ARCHITECT OF DISCREPANCIES. LOCATE AND IDENTIFY SERVICES TO REMAIN IN OPERATION, INCLUDING ALL UTILITY LINES PENETRATING FLOOR, UNDOCUMENTED CONDITIONS, UTILITY RISERS, ETC.

4. PRIOR TO CUTTING EXISTING CONSTRUCTION, DETERMINE THE PRESENCE OF AND PROTECT ACTIVE TELECOMMUNICATION, DATA & ELECTRICAL LINES AND PIPING WHICH MAY BE DAMAGED BY SUCH CUTTING.

5. COORDINATE DEMOLITION WITH OWNER'S REQUIREMENTS AND OTHER CONTRACTORS RETAINED BY THE OWNER.

6. CONTROL NOISE, VIBRATION, AND ANY OTHER DISTURBING

FACTORS. COORDINATE WORK HOURS WITH OWNER PRIOR TO PROCEEDING WITH THE WORK

7. CONTRACTOR TO FOLLOW OWNER'S REQUIREMENTS FOR ENSURING SECURITY AND SAFETY OF THE BUILDING THROUGH DEMOLITION & CONSTRUCTION.

8. SCHEDULE ALL DEMOLITION AND CONSTRUCTION WORK WITH DESIGNATED OWNER'S REPRESENTATIVE TO MINIMIZE DISRUPTION OF BUILDING ACTIVITIES.

9. FOLLOW REQUIREMENTS IN SMACNA IAQ GUIDELINES FOR OCCUPIED BUILDING UNDER CONSTRUCTION 1995 CHAPTERS 2 & 3 AS WELL AS ANY OTHER APPLICABLE ENVIRONMENTAL REQUIREMENTS.

10. CONTRACTOR IS TO PROVIDE COMPLETE DUST PROOF ENCLOSURE IN ALL AREAS WHERE DEMOLITION IS TO OCCUR. COMPLY WITH ALL OSHA, NFPA AND OTHER APPLICABLE RULES AND REGULATIONS REGARDING DUST AND DEBRIS REMOVAL.

11. UTMOST CARE MUST BE TAKEN DURING DEMOLITION TO ENSURE THAT EXISTING CONSTRUCTION TO REMAIN IS NOT DAMAGED. REPAIR OR REPLACE EXISTING CONSTRUCTION DAMAGED BY DEMOLITION ACTIVITIES.

12. PROVIDE CONSTRUCTION WASTE MANAGEMENT PLAN PRIOR TO THE START OF DEMOLITION. TARGET 50% RECYCLING OF CONSTRUCTION WASTE.

13. REMOVE AND REINSTALL ITEMS TO BE SALVAGED WHERE INDICATED AND WHERE ADVISED BY OWNER.

14. INVENTORY AND PHOTOGRAPH SALVAGED ITEMS: LIST SHALL INCLUDE DESCRIPTION OF ITEM, DIMENSIONS (OVERALL WIDTH, HEIGHT, DEPTH), COLOR, APPROX. WEIGHT

15. CONTRACTOR SHALL PROTECT ALL STRUCTURAL ELEMENTS FROM DAMAGE DURING CONSTRUCTION.

16. PROTECT EXISTING EXTERIOR DOORS, WINDOWS, GLAZING, AND FRAMES.

17. PROTECT EXISTING INTERIOR DOORS, WINDOWS,

GLAZING, AND FRAMES, THAT ARE TO REMAIN (TYP.)

18. REFER TO SPECIFICATIONS FOR ADDITIONAL DEMOLITION REQUIREMENTS.

19. ALL SURFACES THAT ARE TO REMAIN ARE TO BE CLEANED W/ WATER & DETERGENT PRIOR TO INSTALLATION OF NEW FINISHES

20. SEE MECHANICAL, ELECTRICAL AND PLUMBING

DRAWINGS FOR ADDITIONAL DEMOLITION INFORMATION. 21. WHEN REMOVING MECHANICAL, ELECTRICAL AND PLUMBING ITEMS, REMOVE ALL ASSOCIATED FASTENERS,

CABLE, RODS, ETC. 22. DO NOT PROCEED WITH NEW FLOOR OPENINGS OR WALL OPENINGS UNTIL NEW SUPPORT STRUCTURE IS IN PLACE,

### **DEMOLITION LEGEND**

SEE STRUCTURAL DETAILS (SHEET A4.1.1).

REMOVE WALL COMPLETE EXISTING STUD & GYP/PLASTER

CONSTRUCTION TO REMAIN, U.N.O. REMOVE DOOR, FRAME, AND HARDWARE COMPLETE

EXISTING DOOR AND FRAME TO EXISTING TERRAZZO STAIR / LANDING

AREA OF WORK (BASE PROJECT)

### HamiltonAnderson

architecture landscape architecture urban design

Hamilton Anderson Associates, Inc 1435 Randolph Suite 200 Detroit, Michigan 48226 p 313 964 0270 f 313 964 0170 www.hamilton-anderson.com

Peter Basso Associates 5145 Livernois Troy, MI 48098 248.879.5666

248.932.2010


Desai/Nasr Consulting Engineer 6765 Daly Rd West Bloomfield, MI 48322

# WAYNE STATE JNIVERSITY

### **WAYNE STATE UNIVERSITY** FP&M

5454 Cass Avenue Detroit, Michigan

Key Plan:

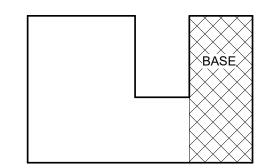

## **ASBESTOS ABATEMENT SERVICES**

WSU PROJECT # 063-301464 Issued: June 20, 2 0 1 9

**Issued for Reference Only** 

SCHOOL OF SOCIAL WORK - PHASE 2 5447 Woodward, Detroit, MI

### **FIRST LEVEL DEMOLITION PLAN**

Project Number: 2013088.22 WSU Project No: 063-301464

Approved By: RH Drawn By: HM/JAM

Scale: 1/8" = 1'-0"

Seal:

Drawing No:

WHERE CEILING IS INDICATED TO REMAIN: REMOVE ALL DEBRIS. REMOVE ALL LOOSE AND PEELING PAINT.

REMOVE ALL CEILINGS, SOFFITS, AND SUPPORT SYSTEMS UNLESS OTHERWISE INDICATED: REMOVE ALL CEILING MOUNTED EQUIPMENT, RAILS, LIGHTS, GRILLES, PANELS, TILES, FRAMING AND SUSPENSION SYSTEMS. REMOVE ALL ORIGINAL PLASTER AND LATH CEILINGS TO EXPOSE CONCRETE STRUCTURE.

PLASTER CEILINGS IN STAIRWELLS AND LANDINGS TO REMAIN. U.N.O. REMOVE DUST, DIRT AND DEBRIS. REMOVE ALL LOOSE AND PEELING PAINT FROM PLASTER OR GYP BOARD.

REMOVE CEILING, BLOCKING AND WINDOW TREATMENT REQUIRED FOR EXTERIOR WINDOW REPLACEMENT. WINDOW TREATMENT TO BE REMOVED AND NUMBERED FOR REINSTALLATION.

WHERE COLUMNS AND EXISTING PLASTER, GYP BOARD, ⟨W.1⟩ CMU OR CONCRETE WALLS ARE TO REMAIN: REMOVE ALL LOOSE AND PEELING PAINT.

FEATURE WALL TO REMAIN.

REMOVE EXISTING TILE, GROUT, AND PLASTER FROM WALLS AND COLUMNS

REMOVE EXISTING WALL PANELS AND FASTENERS.

EXISTING BRICK WALL TO REMAIN. REMOVE ANY ITEMS AFFIXED TO WALL

EXISTING VINYL/RESILIENT OR LINOLEUM TILE OR TERRAZZO ⟨ F.1 ⟩ INDICATED TO REMAIN: REMOVE ALL DEBRIS, DUST AND DIRT.

REMOVE ALL EXISTING CERAMIC OR CLAY TILE FLOORS AND  $\langle$  F.2  $\rangle$  BASE DOWN TO STRUCTURAL SLAB.

REMOVE EXISTING WALL BASE, AND REMOVE FLOOR FINISH DOWN TO STRUCTURAL SLAB.

REMOVE ALL CARPET, WALL BASE AND ADHESIVE DOWN TO F.4 STRUCTURAL SLAB. **OPENINGS**:

WHERE EXISTING PAINTED AND FRAMED DOORS ARE TO REMAIN: REMOVE ALL LOOSE AND PEELING PAINT. REMOVE HARDWARE FOR REPLACEMENT WHERE INDICATED IN THE DOOR SCHEDULE.

REMOVE DOOR, HARDWARE AND FRAME IN ITS ENTIRETY. O.2 REMOVE SIDELIGHTS & TRANSOMS WHERE APPLICABLE.

 $\langle 0.3 \rangle$  NOT USED

 $\left\langle _{\mathrm{O.4}}\right\rangle$  REMOVE INDICATED EXTERIOR WALL FOR INSTALLATION OF NEW LINTEL & FRAME. SEE STOREFRONT SCHEDULE ON SHEET A3.1.1 AND DETAILS ON SHEET A4.2.1.

EXISTING STAINED DOORS ARE TO BE REMOVED & NUMBERED  $\langle 0.5 \rangle$  FOR REINSTALLATION OR RELOCATION. REMOVE HARDWARE FOR REPLACEMENT WHERE INDICATED.

REMOVE INDICATED PORTION OF THE PARTITION FOR INSTALLATION OF NEW LINTEL AND FRAME; SEE DOOR O.6 SCHEDULE SHEET A7.1.1 FOR DOOR SIZES AND SHEET A4.1.1 FOR NEW LINTEL.

 $\langle$  M.1 angle ALL CABINETRY AND MILLWORK IS TO BE REMOVED IN ITS

REMOVE PLUMBING, KITCHEN EQUIPMENT, CABINETS AND COUNTER TOPS COMPLETE

ALL SINKS, DRINKING FOUNTAINS, TOILETS, LAVATORIES, URINALS, TUB/SHOWERS AND WALL-MOUNTED TOILET ⟨ M.3 ⟩ ROOM ACCESSORIES ARE TO BE REMOVED UNLESS SPECIFICALLY NOTED TO BE SALVAGED. SEE PLUMBING DRAWINGS FOR MORE INFORMATION.

⟨ M.4 ⟩ REMOVE DUMBWAITER AND SHAFT

⟨ M.5 ⟩ REMOVE MECHANICAL SHAFT; FILL HOLES IN CONCRETE ✓ SLAB ABOVE &/OR BELOW; SEE SHEET A4.1.1

 $\langle$  M.6  $\rangle$  REMOVE LOWER WOOD HANDRAILS. TOP RAIL TO REMAIN

EXISTING JANITOR'S CLOSET TO REMAIN INCLUDING FINISHES AND PLUMBING FIXTURES

 $\langle$  M.8  $\rangle$  REMOVE FIRE EXTINGUISHER EQUIPMENT

REMOVE WINDOW SILLS AS REQUIRED FOR WINDOW ⟨M.9⟩ REPLACEMENT

(M.10) MECHANICAL. PENETRATIONS NOT TO INTEFERE WITH CONCRETE WEB JOISTS- REFER TO STRUCTURAL DETAILS (SHEET A4.1.1).

NEW FLOOR PENETRATION. COORDINATE WITH

EXISTING STAIR SIGANGE TO BE REMOVED AND NUMBERED FOR REINSTALLATION.

NOTE:

OWNER IS RESPONSIBLE FOR HAZARDOUS MATERIAL REMEDIATION. GC TO COORDINATE HAZARDOUS MATERIAL REMEDIATION. REFER TO HAZARDOUS MATERIAL REPORT FROM OWNER.

1. CONTRACTOR SHALL PROVIDE DEMOLITION AS REQUIRED FOR NEW CONSTRUCTION. REFER TO CONTRACT DOCUMENTS FOR EXTENT OF NEW WORK.

2. CONTRACTOR SHALL VISIT SITE TO VERIFY ACTUAL EXTENT OF DEMOLITION PRIOR TO BID. DO NOT RELY SOLELY ON THE DRAWINGS FOR DEMOLITION SCOPE. AL DEMOLITION REQUIRED TO CARRY OUT THE WORK OF THE CONTRACT SHALL BE PART OF THE CONTRACT. NO ADDITION TO THE CONTRACT AMOUNT WILL BE ALLOWED DUE TO FAILURE TO FIELD VERIFY DEMOLITION SCOPE OR FAILURE TO EXAMINE ALL CONTRACT DOCUMENTS.

3. VERIFY AND INVESTIGATE ALL CONDITIONS IN THE FIELD PRIOR TO STARTING DEMOLITION, NOTIFY ARCHITECT OF DISCREPANCIES. LOCATE AND IDENTIFY SERVICES TO REMAIN IN OPERATION, INCLUDING ALL UTILITY LINES PENETRATING FLOOR, UNDOCUMENTED CONDITIONS,

4. PRIOR TO CUTTING EXISTING CONSTRUCTION, DETERMINE THE PRESENCE OF AND PROTECT ACTIVE TELECOMMUNICATION, DATA & ELECTRICAL LINES AND PIPING WHICH MAY BE DAMAGED BY SUCH CUTTING.

5. COORDINATE DEMOLITION WITH OWNER'S REQUIREMENTS

6. CONTROL NOISE, VIBRATION, AND ANY OTHER DISTURBING FACTORS. COORDINATE WORK HOURS WITH OWNER PRIOR TO PROCEEDING WITH THE WORK

7. CONTRACTOR TO FOLLOW OWNER'S REQUIREMENTS FOR ENSURING SECURITY AND SAFETY OF THE BUILDING THROUGH DEMOLITION & CONSTRUCTION.

WITH DESIGNATED OWNER'S REPRESENTATIVE TO MINIMIZE DISRUPTION OF BUILDING ACTIVITIES.

OCCUPIED BUILDING UNDER CONSTRUCTION 1995 CHAPTERS 2 & 3 AS WELL AS ANY OTHER APPLICABLE ENVIRONMENTAL REQUIREMENTS.

ENCLOSURE IN ALL AREAS WHERE DEMOLITION IS TO OCCUR. COMPLY WITH ALL OSHA, NFPA AND OTHER AND DEBRIS REMOVAL.

ENSURE THAT EXISTING CONSTRUCTION TO REMAIN IS NOT DAMAGED. REPAIR OR REPLACE EXISTING CONSTRUCTION DAMAGED BY DEMOLITION ACTIVITIES.

RECYCLING OF CONSTRUCTION WASTE.

15. CONTRACTOR SHALL PROTECT ALL STRUCTURAL ELEMENTS FROM DAMAGE DURING CONSTRUCTION.

16. PROTECT EXISTING EXTERIOR DOORS, WINDOWS,

17. PROTECT EXISTING INTERIOR DOORS, WINDOWS, GLAZING, AND FRAMES, THAT ARE TO REMAIN (TYP.)

OF NEW FINISHES

DRAWINGS FOR ADDITIONAL DEMOLITION INFORMATION. 21. WHEN REMOVING MECHANICAL, ELECTRICAL AND

PLUMBING ITEMS, REMOVE ALL ASSOCIATED FASTENERS,

22. DO NOT PROCEED WITH NEW FLOOR OPENINGS OR WALL

SEE STRUCTURAL DETAILS (SHEET A4.1.1).

EXISTING STUD & GYP/PLASTER CONSTRUCTION TO REMAIN, U.N.O. REMOVE DOOR, FRAME, AND

EXISTING DOOR AND FRAME TO

EXISTING TERRAZZO STAIR / LANDING



Drawn By: HM/JAM

Scale: 1/8" = 1'-0"

Seal:

HamiltonAnderson

Hamilton Anderson Associates, Inc

p 313 964 0270 f 313 964 0170

www.hamilton-anderson.com

1435 Randolph Suite 200

Detroit, Michigan 48226

MEP Engineer

FP&M

Key Plan:

5454 Cass Avenue

Detroit, Michigan

Structural Engineer

architecture landscape architecture urban design

Peter Basso Associates

Desai/Nasr Consulting Engineer

West Bloomfield, MI 48322

5145 Livernois

Troy, MI 48098

248.879.5666

6765 Daly Rd

248.932.2010

WAYNE STATE

JNIVERSITY

**WAYNE STATE UNIVERSITY** 

**ASBESTOS ABATEMENT SERVICES** 

WSU PROJECT # 063-301464

Issued: June 20, 2 0 1 9

Issued for Reference Only

SCHOOL OF SOCIAL

5447 Woodward, Detroit, MI

**DEMOLITION PLAN** 

Project Number: 2013088.22 WSU Project No: 063-301464

Approved By: RH

WORK - PHASE 2

**SECOND LEVEL** 

Signature:



**DEMOLITION GENERAL NOTES** 

UTILITY RISERS, ETC.

AND OTHER CONTRACTORS RETAINED BY THE OWNER.

8. SCHEDULE ALL DEMOLITION AND CONSTRUCTION WORK

9. FOLLOW REQUIREMENTS IN SMACNA IAQ GUIDELINES FOR

10. CONTRACTOR IS TO PROVIDE COMPLETE DUST PROOF APPLICABLE RULES AND REGULATIONS REGARDING DUST

11. UTMOST CARE MUST BE TAKEN DURING DEMOLITION TO

12. PROVIDE CONSTRUCTION WASTE MANAGEMENT PLAN PRIOR TO THE START OF DEMOLITION. TARGET 50%

13. REMOVE AND REINSTALL ITEMS TO BE SALVAGED WHERE INDICATED AND WHERE ADVISED BY OWNER.

14. INVENTORY AND PHOTOGRAPH SALVAGED ITEMS: LIST SHALL INCLUDE DESCRIPTION OF ITEM, DIMENSIONS (OVERALL WIDTH, HEIGHT, DEPTH), COLOR, APPROX. WEIGHT

GLAZING, AND FRAMES.

18. REFER TO SPECIFICATIONS FOR ADDITIONAL

DEMOLITION REQUIREMENTS.

19. ALL SURFACES THAT ARE TO REMAIN ARE TO BE CLEANED W/ WATER & DETERGENT PRIOR TO INSTALLATION

20. SEE MECHANICAL, ELECTRICAL AND PLUMBING

CABLE, RODS, ETC. OPENINGS UNTIL NEW SUPPORT STRUCTURE IS IN PLACE,

### **DEMOLITION LEGEND**

= = = = =

HARDWARE COMPLETE

REMOVE WALL COMPLETE

AREA OF WORK (BASE PROJECT)

Drawing No: