MATTHAEI ACADEMIC RESOURCE CENTER RENOVATION

5101 John C Lodge Fwy, Detroit, MI 48202

ARCHITECT

STUCKY VITALE ARCHITECTS 27172 WOODWARD AVENUE **ROYAL OAK, MICHIGAN 48067** (248) 546-6700

MECH/PLUMB/ELEC ENGINEER

MA ENGINEERING 180 HIGH OAK RD BLOOMFIELD HILLS, MI 48304 (248) 258-1610

PROJECT INFORMATION

WSU PROJECT NUMBER: 080-349977

RENOVATION OF EXISTING ACADEMIC RESOURCE CENTER IN MATTHAEI

BUILDING INTO STUDENT ATHLETE LOUNGE.

APPLICABLE CODES
2015 MICHIGAN REHABILITATION CODE FOR EXISTING BUILDINGS (MRC) 2015 MICHIGAN MECHANICAL CODE (MMC)

2015 MICHIGAN ENERGY CODE (MEC) 2013 ANSI/ASHRA/IES 90.1

2011 NATIONAL ELECTRICAL CODE (NEC) 2009 ICC A117.1

2015 NFPA 101 LIFE SAFETY CODE

BARRIER FREE REQUIREMENTS: 2010 ADA STANDARDS FOR ACCESSIBLE DESIGN (DOJ)

MBC-2009, CHAPTER 11 ICC / ANSI 117.1 - 2006, EXCEPT SECTION 611 & 707

CHAPTER 3 - USE AND OCCUPANCY CLASSIFICATION

2012 ADDITION - BUSINESS: B

SHEET DESIGNATION

DRAWINGS ARE NUMBERED ACCORDING TO THE FOLLOWING CONVENTIONS: DRAWING SEQUENCE NUMBER DISCIPLINE

DESIGNATOR G GENERAL

M MECHANICAL

E ELECTRICAL

LS LIFE SAFETY AD ARCHITECTURAL DEMOLITION A ARCHITECTURAL P PLUMBING

DRAWING TYPE DESIGNATOR GENERAL, LEGENDS REFLECTED CEILING PLANS EXTERIOR ELEVATIONS SECTIONS VERTICAL CIRCULATION (PLANS &

SECTIONS) 6 ENLARGED PLANS AND INTERIOR **ELEVATIONS** INTERIOR AND MILLWORK DETAILS FREE SECTION DOOR AND WINDOW SCHEDULES AND

	SHEET INDEX - GENERA	L	
DWG#	DRAWING NAME	ISSUED FOR	DATE
G001	COVER SHEET, GENERAL INFORMATION, DRAWING INDEX	BID / PERMIT	07.07.22
G002	STANDARD MOUNTING HEIGHTS, PARTITION TYPES AND DETAILS	BID / PERMIT	07.07.22

	SHEET INDEX - LIFE SAFETY	/	
DWG#	DRAWING NAME	ISSUED FOR	DATE
LS110	CODE INFORMATION AND FLOOR LIFE SAFETY PLAN - EGRESS PLANS	BID / PERMIT	07.07.22
DRAWIN	IGS: 1		
			'

	SHEET INDEX - ARCHITECTU	RAL	
DWG#	DRAWING NAME	ISSUED FOR	DATE
AD100	ARCHITECTURAL DEMOLITION PLANS	BID / PERMIT	07.07.22
A110	FIRST LEVEL NEW CONSTRUCITON AND RCP	BID / PERMIT	07.07.22
A610	INTERIOR ELEVATIONS AND ENLARGED PLANS FIRST LEVEL	BID / PERMIT	07.07.22
DRAWIN	GS: 3		

SHEET INDEX - MECHANICAL						
DRAWING NAME	ISSUED FOR	DATE				
MECHANICAL SYMBOLS LIST, INDEX,	BID / PERMIT	07.07.22				
DEMOLITION & NEW WORK	BID / PERMIT	07.07.22				
SS: 2						
	DRAWING NAME MECHANICAL SYMBOLS LIST, INDEX, DEMOLITION & NEW WORK	DRAWING NAME MECHANICAL SYMBOLS LIST, INDEX, DEMOLITION & NEW WORK BID / PERMIT BID / PERMIT				

	SHEET INDEX - ELECTRICAL						
DWG#	DRAWING NAME	ISSUED FOR	DATE				
E001	ELECTRICAL LEGEND, SHEET INDEX AND SPECIFICATION	BID / PERMIT	07.07.22				
ED001	DEMOLITION PLANS	BID / PERMIT	07.07.22				
E100	ELECTRICAL PLANS	BID / PERMIT	07.07.22				
DRAWING	GS: 3						

DWG#	DRAWING NAME	ISSUED FOR	DATE
F100	FIRST LEVEL NEW WORK FIRE PROTECTION PLAN	BID / PERMIT	07.07.22

THESE CONSTRUCTION DRAWINGS WERE PREPARED FOR COMPLIANCE WITH THE MICHIGAN CONSTRUCTION CODES IN EFFECT AT THE TIME OF PERMIT SUBMITTAL. ALL ENGINEERS, CONTRACTORS AND SUPPLIERS INVOLVED WITH THIS PROJECT SHALL COMPLY WITH THE SAME CODES, ISSUED AND APPROVED CODE MODIFICATIONS AND/OR CITY CODE AUTHORITY CONSTRUCTION BOARDS OF APPEALS RULINGS AND WHENEVER REQUIRED SHALL PROVIDE SHOP DRAWINGS AND SUBMITTALS CLEARLY DESCRIBING COMPLIANCE TO THE REGISTERED DESIGN PROFESSIONAL IN RESPONSIBLE CHARGE FOR REVIEW AND APPROVAL.

MATERIAL LEGEND HATCH PATTERNS

EARTH SAND **GRAVEL FILL** CONCRETE MASONRY

GROUT

MORTAR

STAINLESS STEEL

STEEL

RIGID INSULATION GYPSUM BOARD CEMENT BOARD

TYPICAL DETAIL SYMBOLS

SPRAY ON FIREPROOFING

STEEL MEMBER

HARDWOOD

CONTINUOUS BLOCKING


BATT INSULATION SEALANT WITH BACKER ROD

PARTITION PLAN DESIGNATIONS

1 HOUR FIRE SEPARATION 2 HOUR FIRE SEPARATION 3 HOUR FIRE SEPARATION METAL STUD PARTITION **CMU PARTITION CONCRETE WALL**

SYMBOL LEGEND

ENLARGED CALLOUT TAG INTERIOR ELEVATION TAG **EXTERIOR ELEVATION TAG**

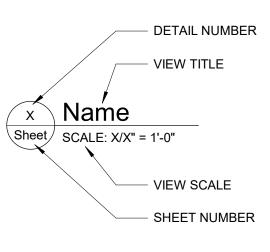


ROOM NAME ROOM NAME 101


LEVEL REFERENCE


ROOM TAG

DATUM WORKPOINT

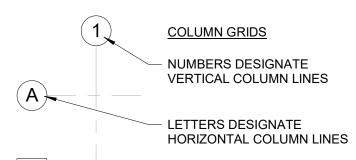

- SQUARE DESIGNATE EXISTING **COLUMN GRID**

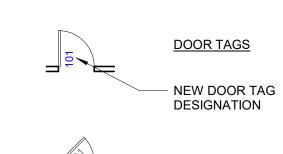

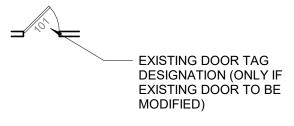



EQUIPMENT TAG

ABBREVIATION LEGEND

AND

CENTERLINE

ROYAL OAK, MI 48067-0925 ACCESSIBILITY P. 248.546.6700 ACOUS. ACOUSTICAL **ACOUSTICAL CEILING TILE** F. 248.546.8454 AREA DRAIN **ADJUSTABLE** WWW.STUCKYVITALE.COM **ALUMINUM ASPHALT** STATEMENT OF INTELLECTUAL PROPERTY: BOARD BLDG. BUILDING THE IDEAS, CONCEPTS, DRAWINGS AND THOUGHTS CONVEYED HEREIN ARE **BLOCKING** THE INTELLECTUAL PROPERTY OF STUCKY VITALE ARCHITECTS. THIS SET OF BRICK DRAWINGS, IN WHOLE OR IN PART, MAY NOT BE REPRODUCED, WITHOUT CABINET THE WRITTEN CONSENT OF STUCKY VITALE ARCHITECTS. THIS INFORMATION CEM. CEMENT IS PROTECTED UNDER U.S. COPYRIGHT LAW, ALL RIGHTS RESERVED CER. CERAMIC COLD FORMED METAL FRAMING CFMF Consultants **CONTROL JOINT**

CEILING CAULKING COL. COLUMN CONC. CONCRETE CONT. CONTINUOUS CORR. CORRIDOR CPT CARPET DRINKING FOUNTAIN DETAIL DIAMETER DIMENSION DOWN DOOR OPENING

DET. DIM. DOOR **DRAWER** DOWN SPOUT DRY STAND PIPE **EXPANSION JOINT ELEVATION** ELEC. **ELECTRICAL ELEVATOR** ELEV. E.O.S./EOS EDGE OF SLAB

E.O.D./EOD EDGE OF DECK **ELECTRICAL PANEL** EPX EPOXY EQ. **EQUAL EQPM** EQUIPMEN^{*} EXIST./EX **EXISTING EXTERIOR** EXT. FIRE ALARM FLOOR DRAIN **FOUNDATION** FIRE EXTINGUISHER

FIRE EXTINGUISHER CABINET FIRE HOSE CABINET FINISH **FLOOR FIREPROOF** FIBERGLASS REINFORCED PANEL FOOT OR FEET FTG. FOOTING FUR **FURRING**

GAUGE GALV. GFRC. GALVANIZED GLASS FIBER REINFORCED CONCRETE GLASS GYP. GYPSUM **HOSE BIBB** H.B. **HOLLOW CORE HDWE** HARDWARE

MFR.

MIN. MISC.

M.O.

NIC NTS

O/C

OFC

OPP

PNT

RCP

RQD

SIM

SPEC

SQ

S.S.

STD

STL

STOR

SUSP

SYM

TRD

T.O.C.

T&G

THK

T.O.P.

T.O.W.

U.N.O.

VCT

VERT.

VEST

WB W.C.

WD

W/O

WSCT.

SS

SCHED

PLYWD

HOLLOW METAL

JANITOR'S CLOSET

LUXURY VINYL TILE

HORIZONTAL

INSULATION

MAXIMUM

MINIMUM

MECHANICAL

ON CENTER

OFFICE

OPPOSITE

PLYWOOD **ROOF DRAIN**

REQUIRED

SOLID CORE

SPECIFICATIONS

STAINLESS STEEL SOLID SURFACE

SCHEDULE

SIMILAR

SQUARE

STANDARD

STORAGE

SUSPENDED

SYMMETRICAL

TOP OF CURB

TELEVISION

TOP OF WALL

VERTICAL

VESTIBULE VINYL FLOORING

WALL BASE

WOOD

WITHOUT

WAINSCOT WEIGHT

WATER CLOSET WALLCOVERING

TOS/ T.O.S. TOP OF STEEL

TOP OF PARAPET **TOILET ACCESSORY**

TONGUE AND GROOVE

UNLESS NOTED OTHERWISE

VINYL COMPOSITION TILE

STEEL

MANUFACTURER

MISCELLANEOUS

MASONRY OPENING

NOT IN CONTRACT NOT TO SCALE

PLASTIC LAMINATE


REFLECTED CEILING PLAN

HORIZ. INSUL LVT MAX MECH MTL

PARTITION TAG

KEYNOTE TAG

5101 John C Lodge Fwy, Detroit, MI 48202 Key Plan:

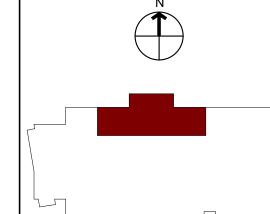

MATTHAEI ACADEMIC

RESOURCE CENTER

RENOVATION

STUCKY VITALE ARCHITECTS

27172 WOODWARD AVENUE

Seal:

Project:

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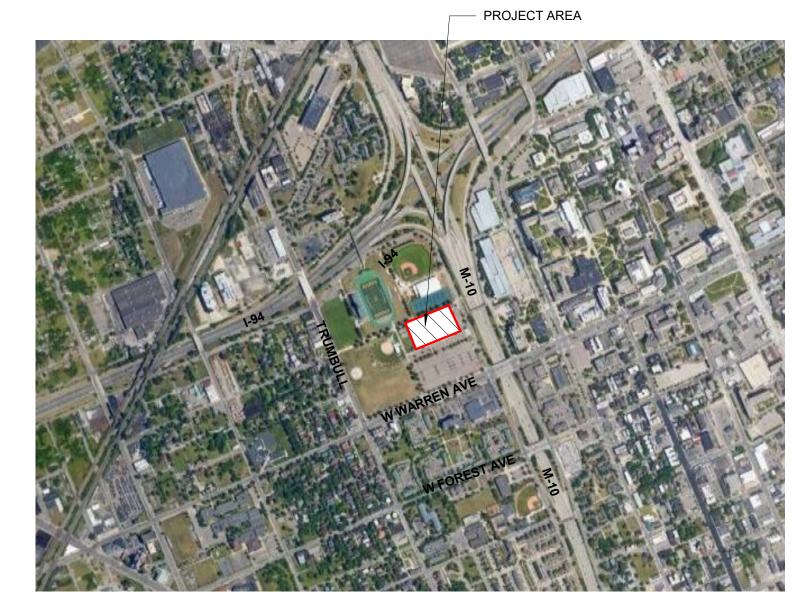
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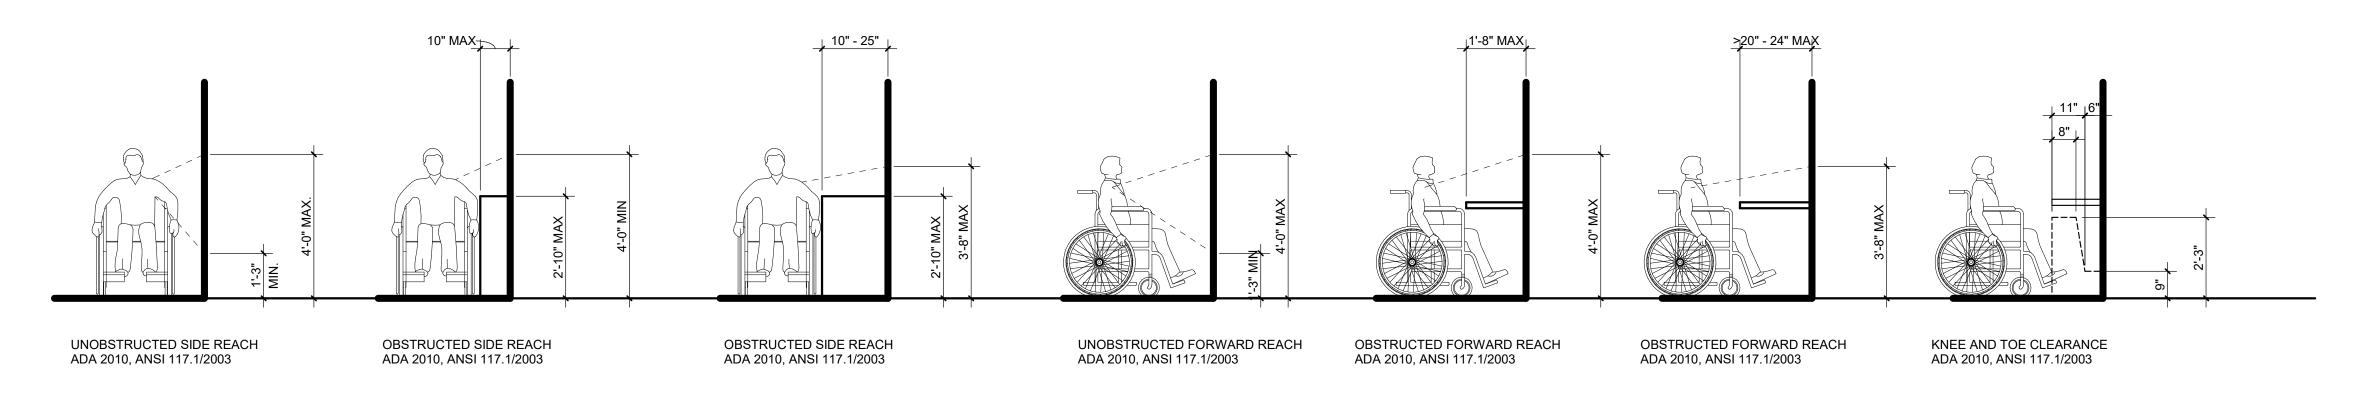
SVA Checked by: JAV, MJB, AJD


Sheet Title: COVER SHEET, GENERAL INFORMATION, DRAWING

Project No. 2022.038

Sheet No.





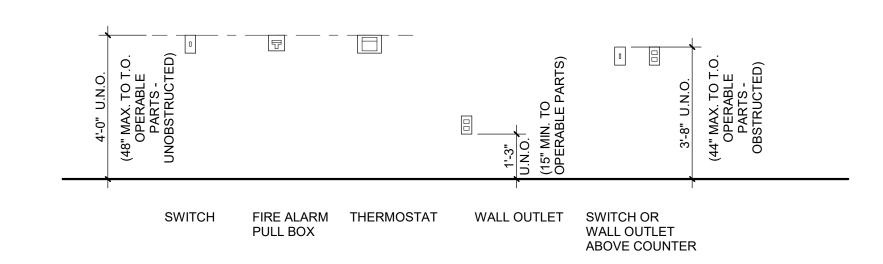


	INTERIOR PARTITION SCHEDULE												
		WIDTH				STUE)	UL DESIGN		STC*			
TYPE	DESCRIPTION	NOMINAL	ACTUAL	DET'L	DEPTH	THICK	SPACING	1 HR	2 HR	OTH'R	W/O	W/	REMARKS
A2	1 GYP, 1 SIDE ON 1 1/2" Z-FURRING	0' - 2 1/4"	2 1/8"	X/XXX	1 1/2"	18 MIL	16" O/C				29		
B2	1 GYP, 1 SIDE ON 3 5/8" METAL STUDS	0' - 4 1/4"	4 1/4"	X/XXX	3 5/8"	30 MIL	16" O/C				29	34	

PARTITION LEGEND THE PARTITION TAG - DESIGNATES THE PARTITION GROUP. IT INDICATES THE DETAIL DRAWING THAT WILL SHOW THE PARTITION CONSTRUCTION, INCLUDING THE BASE CONDITION. DESIGNATES THE SIZE OF THE MATERIAL- VARIOUS STUD SIZES OR MASONRY UNIT SIZES. - DESIGNATES THE TOP OF PARTITION CONDITION. X = UNDERSIDE OF CEILING Y = GYP. ABOVE CEILING, STUD TO DECK Z = TO DECK DESIGNATES THAT THE PARTITION HAS SOUND ATTENUATING INSULATION. - DESIGNATES THE FIRE RESISTANCE RATING OF THE PARTITION IN HOURS (NON-RATED PARTITIONS WILL HAVE NO NUMERICAL PREFIX)


PARTITION GROUPS (REMOVE TYPE FROM NOTE WHEN NOTE USED)

B = ONE LAYER OF GYPSUM BOARD ON ONE SIDE OF METAL STUDS.

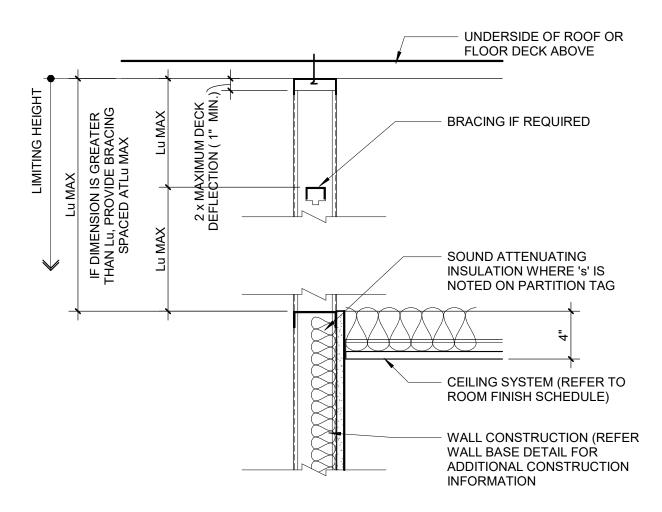

Partition Type B Wall Head Detail (.Y)

1 1/2" = 1'-0"

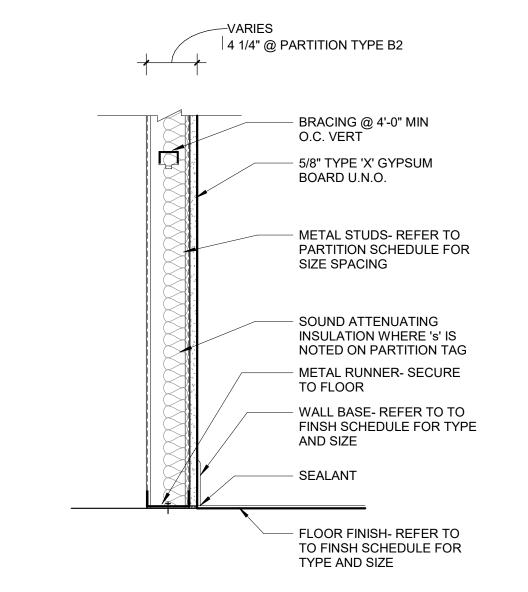

Partition Type B Wall Base Detail
1 1/2" = 1'-0"



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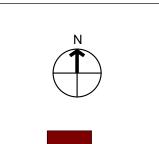
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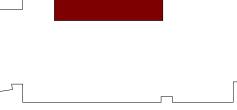
Project :

MATTHAEI ACADEMIC RESOURCE CENTER RENOVATION

5101 John C Lodge Fwy, Detroit, MI 48202

Key Plan:





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Drawn by :

Author
Checked by:


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Sheet Title:

STANDARD MOUNTING
HEIGHTS, PARTITION TYPES
AND DETAILS

Project No. : 2022.038

Sheet No. :

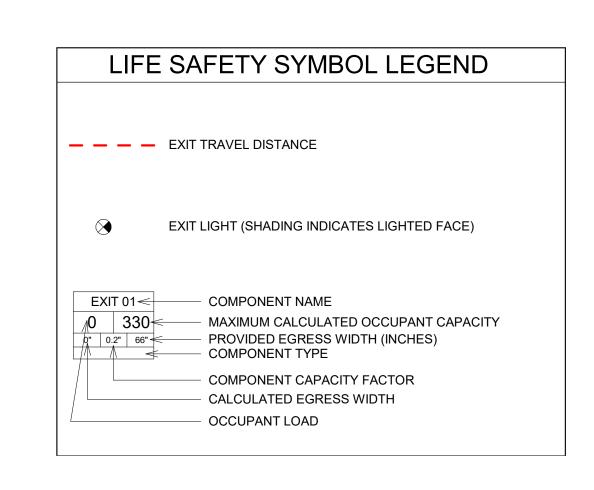


	EGRESS TRAVEL DISTANCE SCHEDULE
Egress Path	Travel Distance
B1	101' - 8"
E1	63' - 8"
E2	101' - 0"
E3	54' - 3"

= 4,690 EXISTING EDUCATIONAL BUILDING OCCUPANT LOAD EXISTING BUSINESS + EDUCATIONAL OCCUPANT LOAD = 101 TOTAL FACILITY OCCUPANT LOAD = 4,791 TOTAL OCCUPANT EGRESS CAPACITY PROVIDED = 5,095

> EXISTING EDUCATIONAL TO REMAIN CONSTRUCTION TYPE = TYPE II AREA = 108,500 SF SUPPRESSED = NO OCCUPANCY = EDUCATIONAL

> > Key Plan:

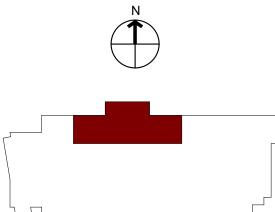

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Seal:

Project:

MATTHAEI ACADEMIC

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RESOURCE CENTER

RENOVATION

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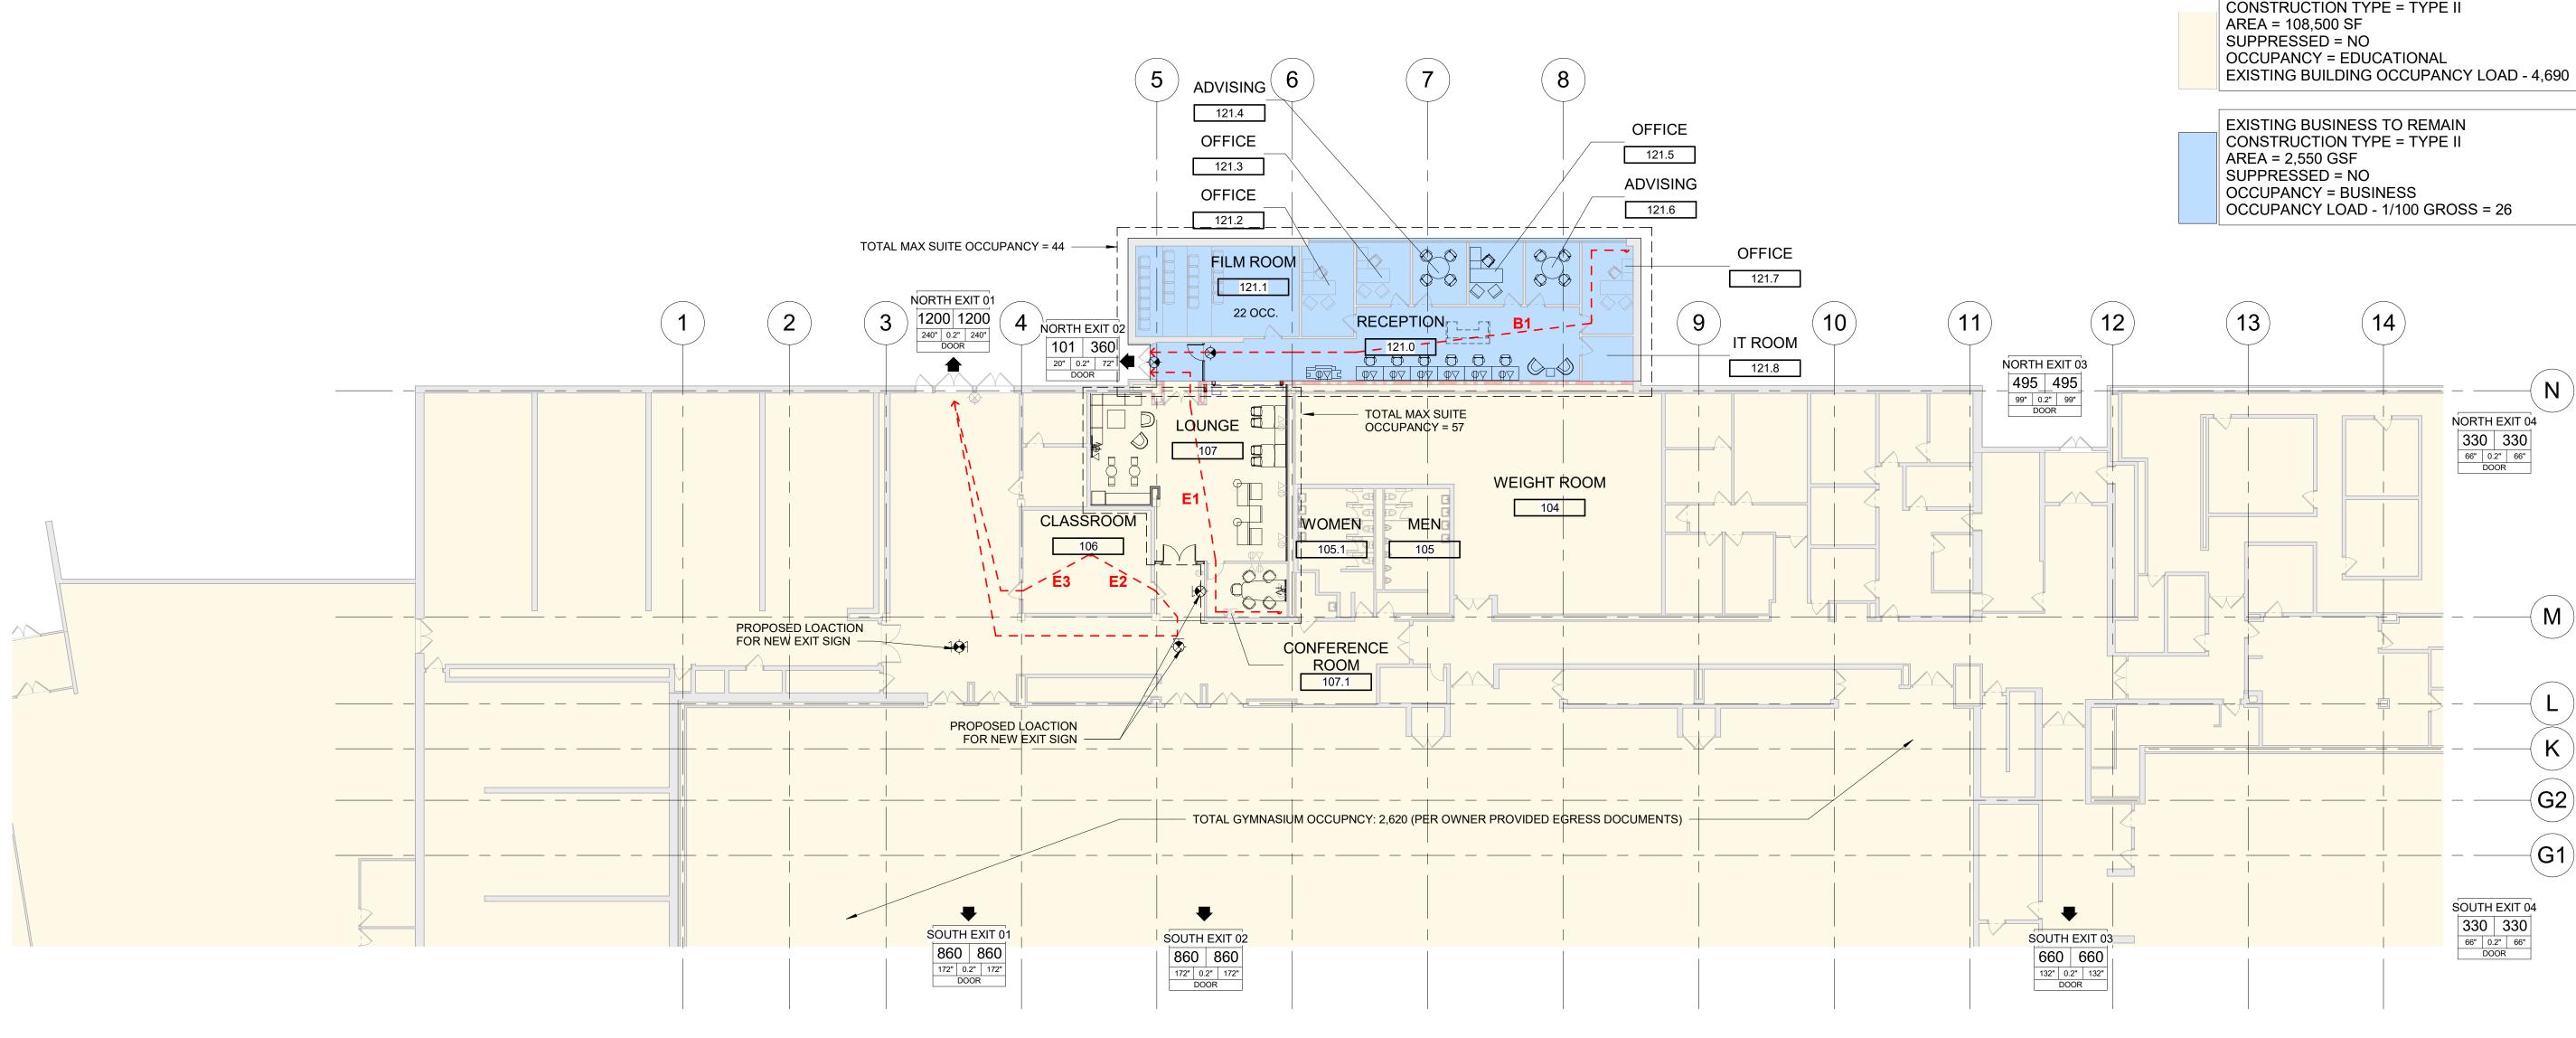
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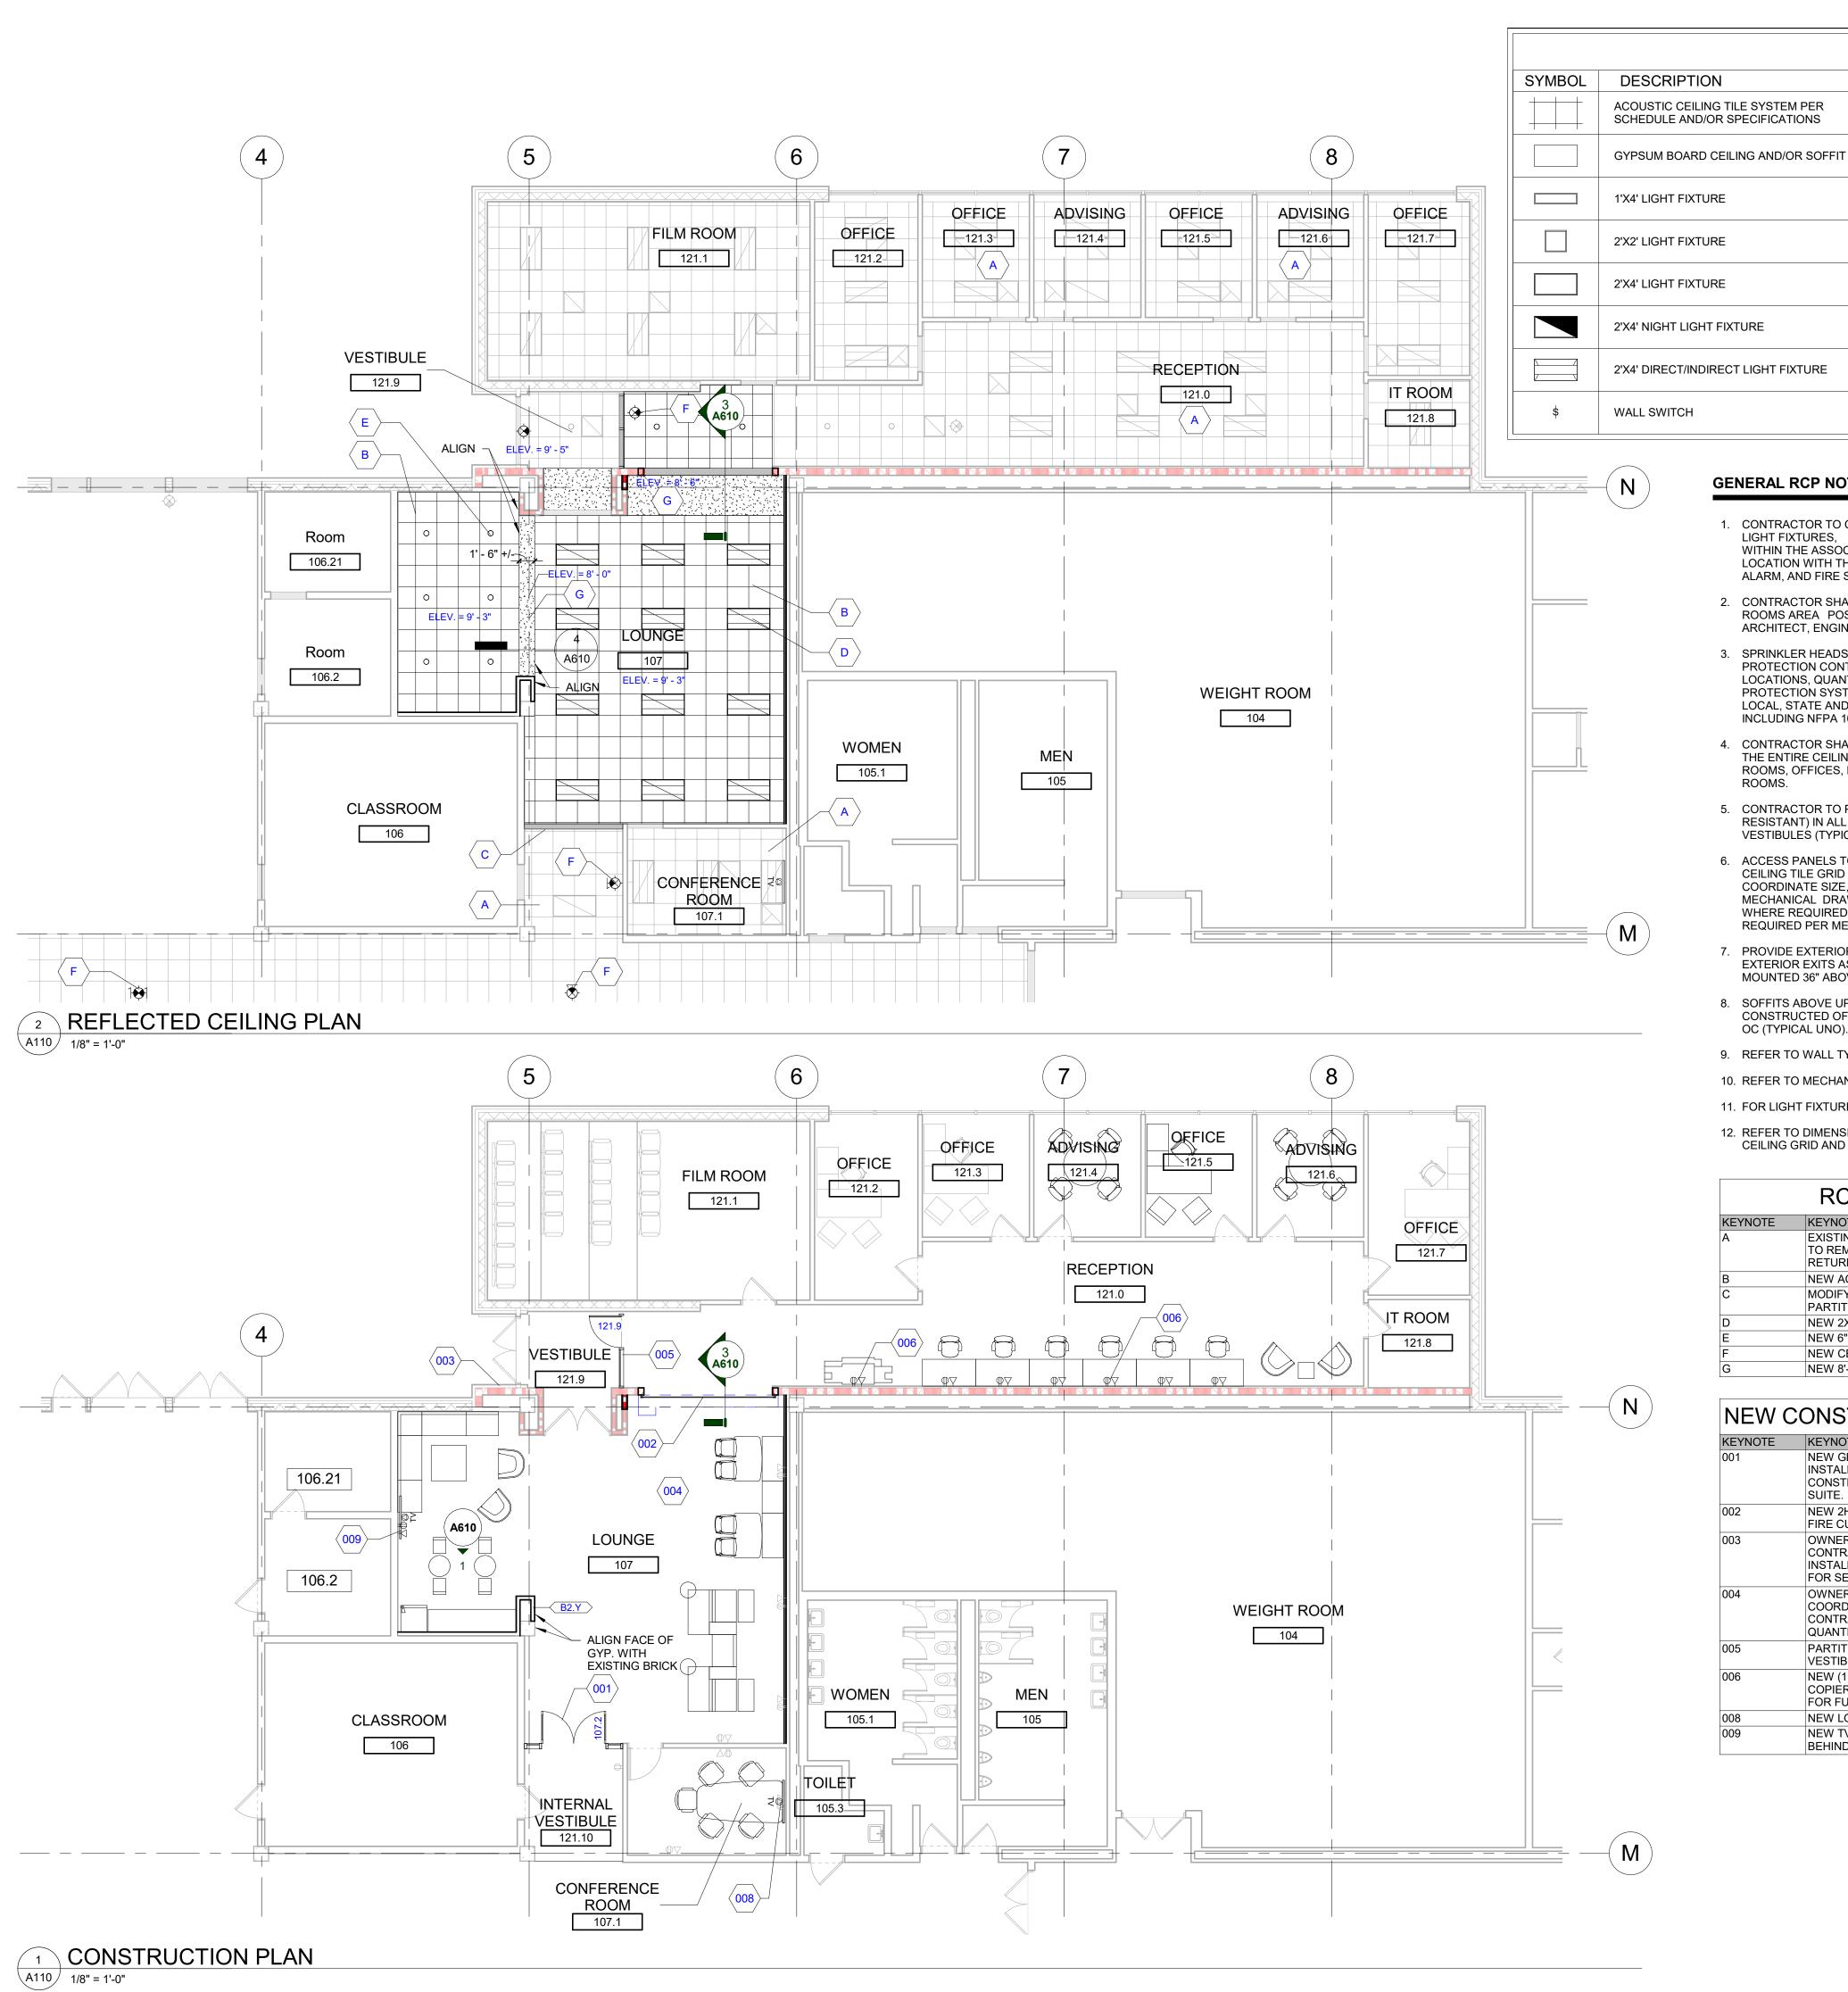
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Sheet Title: CODE INFORMATION AND FLOOR LIFE SAFETY PLAN -EGRESS PLANS

Project No. 2022.038

Sheet No.





GENERAL RCP NOTES

1. CONTRACTOR TO CENTER ALL CEILING MOUNTED ITEMS (i.e., RECESSED LIGHT FIXTURES, SMOKE DETECTORS, FIRE SUPPRESSION HEADS) WITHIN THE ASSOCIATED CEILING TILE AS SHOWN. COORDINATE FINAL LOCATION WITH THE APPROPRIATE MECHANICAL, ELECTRICAL, FIRE ALARM, AND FIRE SUPPRESSION DRAWINGS AS REQUIRED.

REFLECTED CEILING LEGEND

RECESSED DOWNLIGHT FIXTURE

WALL WASHING LIGHT FIXTURE

UNDER CABINET LIGHT FIXTURE

EMERGENCY LIGHT FIXTURE W/ BATTERY SUPPLY

EXIT LIGHT (SHADING INDICATES LIGHTED FACE)

COORDINATE FINAL LOCATION WITH MEP

WALL SCONCE FIXTURE

SUPPLY AIR DIFFUSER

SYMBOL DESCRIPTION

- 2. CONTRACTOR SHALL VERIFY IN FIELD IF DESIGNATED CEILING HEIGHTS IN ROOMS AREA POSSIBLE. IF NOT, MAXIMIZE CEILING HEIGHTS AND NOTIFY ARCHITECT, ENGINEER OR PROJECT MANAGER OF ANY DISCREPANCY.
- 3. SPRINKLER HEADS SHOWN FOR REFERENCE ONLY, DESIGN-BUILD FIRE PROTECTION CONTRACTOR SHALL BE RESPONSIBLE FOR FINAL LOCATIONS, QUANTITY, TYPE AND FULL FIRE PROTECTION DESIGN. FIRE PROTECTION SYSTEM SHALL BE IN ACCORDANCE WITH ALL APPLICABLE LOCAL, STATE AND FEDERAL CODES AND BUILDING STANDARDS INCLUDING NFPA 101 LIFE SAFETY CODE (SPECIFICALLY CHAPTER 20).
- 4. CONTRACTOR SHALL PROVIDE ACOUSTIC SOUND BATT INSULATION ABOVE THE ENTIRE CEILING IN THE FOLLOWING ROOMS (TYPICAL UNO): TOILET ROOMS, OFFICES, RECEPTION AREAS, EXAM ROOMS AND CONFERENCE
- 5. CONTRACTOR TO PROVIDE DENS ARMOR PLUS WALL BOARD (MOISTURE RESISTANT) IN ALL CEILING AREAS AND WALLS OF TOILET ROOMS AND VESTIBULES (TYPICAL UNO).
- 6. ACCESS PANELS TO BE INDEPENDENTLY MOUNTED, DO NOT SUPPORT ON CEILING TILE GRID ASSEMBLY, SUPPORT FROM STRUCTURE ABOVE ONLY. COORDINATE SIZE, QUANTITY AND LOCATIONS WITH ARCHITECTURAL AND MECHANICAL DRAWINGS; IF NOT SHOWN, CONTRACTOR TO PROVIDE WHERE REQUIRED AND COORDINATE FINAL LOCATIONS IN FIELD WHERE REQUIRED PER MEP EQUIPMENT AND DRAWINGS.
- PROVIDE EXTERIOR MOUNTED EMERGENCY EGRESS LIGHT AT ALL EXTERIOR EXITS AS REQUIRED BY CODE, BATTERY BACK-UP AND MOUNTED 36" ABOVE DOOR UNO.
- 8. SOFFITS ABOVE UPPER CABINETS SHALL BE 16" DEEP AND SHALL BE CONSTRUCTED OF 5/8" GYPSUM BOARD ON 3 5/8" METAL FRAMING AT 16" OC (TYPICAL UNO).
- 9. REFER TO WALL TYPES FOR WALLS THAT PENETRATE CEILINGS.
- 10. REFER TO MECHANICAL HVAC PLANS FOR DIFFUSER / GRILLE SIZES.
- 11. FOR LIGHT FIXTURE TYPES SEE ELECTRICAL LIGHTING PLANS.
- 12. REFER TO DIMENSIONS ON REFLECTED CEILING PLAN TO LOCATE / LAYOUT CEILING GRID AND LIGHT FIXTURES.

RCP KEYNOTE LEGEND

KEYNOTE	KEYNOTE DESCRIPTION
A	EXISTING CEILING SYSTEM, SUPPORT STRUCTURE AND LIGHTS TO REMAIN. COORDINATE NEW MECHANICAL DIFFUSER AND RETURN GRILLS AS INDICATED ON MECHANICAL DOCUMENTS.
В	NEW ACOUSTIC CEILING GRID TO BE INSTALLED, TYP.
С	MODIFY EXISTING CEILING SYSTEM AS REQUIRED FOR NEW PARTITION.
D	NEW 2X4 LIGHTS TO BE INSTALLED, TYP.
E	NEW 6" DOWN LIGHTS TO BE INSTALLED, TYP.
F	NEW CEILING MOUNTED EXIT SIGNS TO BE INSTALLED.
G	NEW 8'-0" SOFFIT TO BE INSTALLED.

KEYNOTE	KEYNOTE DESCRIPTION
001	NEW GLASS AND ALUMINUM STOREFRONT DOOR SYSTEM TO BI INSTALLED. CONTRACTOR TO PROVIDE TEMPORARY CONSTRUCTION ACCESS DOORS BETWEEN EXISTING AND NEW SUITE.
002	NEW 2HR FIRE CURTAIN - BOD: COOPERS FIRE MASTER 4/1000 FIRE CURTAIN STRUCTURAL SUPPORT MAY BE REQUIRED.
003	OWNER TO INSTALL SECIRITY HARDWARE (CARD ACCESS). CONTRACTOR RESPONSIBLE FOR CONDUIT AND JUNCTION BOX INSTALLATION. FIELD VERIFY IF DOOR NEEDS TO BE MODIFIED FOR SECURITY HARDWARE INSTALLATION.
004	OWNER TO PROVIDE 175 SF OF CARPETING IN LOUNGE. COORDINATE WITH OWNER ON LOCATION OF EXISTING CARPET CONTRACTOR RESPONSIBLE FOR ORDERING DIFFERENCE IN QUANTITY AND INSTALLATION OF NEW CARPET.
005	PARTITION WALL AND EGRESS DOOR TO BE INSTALLED BETWEE VESTIBULE AND OFFICE AREA.
006	NEW (1) DUPLEX POWER AND (1) DATA IN WALL PER DESK AND COPIER TO BE INSTALLED BY CONTRACTOR. SEE ELECTRICAL FOR FURTHER INFORMATION.
800	NEW LOCATION OF TV SALAGED FROM RECEPTION.
009	NEW TV MOUNTED TO WALL. POWER AND DATA TO BE INSTALLE BEHIND.

GENERAL PLAN NOTES

◆ HEIGHT

1. THIS DRAWING IS DIAGRAMMATIC AND SHOULD BE USED TO DETERMINE THE DESIGN INTENT. THE CONTRACTOR IS RESPONSIBLE FOR THE COMPLETE SET OF WORK AS INDICATED AND SHALL FIELD VERIFY ALL WORK, COORDINATE ALL DRAWINGS / NEW WORK AND SHALL NOTIFY ARCHITECT IMMEDIATELY OF ANY DISCREPANCIES IN THE DOCUMENTS BEFORE PROCEEDING, FAILURE TO DO SO WILL RESULT IN THE CONTRACTOR TAKING FULL RESPONSIBILITY AND LIABILITY FOR SAID DISCREPANCIES.

SYMBOL DESCRIPTION

RETURN AIR GRILL

EXHAUST AIR GRILL

SMOKE DETECTOR

SPEAKER

FIRE SUPPRESSION HEAD

ELEVATION ABOVE FINISHED FLOOR

EXISTING FIXTURE TO BE RELOCATED

EXISTING FIXTURE TO REMAIN

- 2. ALL DIMENSIONS ARE SHOWN FROM FINISH FACE TO FINISH FACE OF PARTITION UNLESS OTHERWISE NOTED.
- 3. WALL THICKNESS' ARE NOMINAL NOT ACTUAL DIMENSIONS. SEE WALL SCHEDULE FOR ACTUAL DIMENSIONS.
- 4. ALL WOOD, INCLUDING BLOCKING, USED ON THE PROJECT SHALL BE FIRE RETARDANT TREATED.
- 5. ALL WORK SHALL BE DONE IN ACCORDANCE WITH ALL LOCAL, STATE, COUNTY CODE REGULATIONS, O.S.H.A., AND THE AMERICAN WITH DISABILITIES ACT (ADA). REFER TO THE CODE PLAN FOR MORE INFORMATION.
- 6. PROVIDE POSITIVE SLOPE TO ALL FLOOR DRAINS WHILE KEEPING FLOOR LEVEL AT WALL BASE CONDITION.
- 7. PROVIDE TRANSITION STRIPS AT EACH CHANGE IN FLOOR FINISH MATERIALS.
- 8. PAINT, PATCH AND REPAIR THE FOLLOWING TO MATCH EXISTING MATERIALS: FLOOR, WALL, AND CEILING SURFACES AS REQUIRED ADJACENT TO AREAS BEING DEMOLISHED. REFER TO DEMOLITION DRAWINGS FOR MORE INFORMATION.
- 9. REINFORCE WALL AND PROVIDE BLOCKING AS REQUIRED TO SUPPORT WALL CABINETS AND COUNTERTOPS.
- 10. THE CONTRACTOR SHALL PROVIDE AND INSTALL WALL REINFORCING FOR INSTALLATION OF ACCESSORIES, COAT RACKS, CHART RACKS, CASEWORK, AND OTHER WALL MOUNTED ITEMS.
- 11. CLEAN AND REPAIR ALL EXISTING FLOOR FINISHES AS NECESSARY.
- 12. ALL EXPOSED PIPES, DUCTS, AND CONDUIT TO BE PAINTED TO MATCH
- 13. PROVIDE CONTROL JOINTS IN GYPSUM BOARD PARTITIONS AT 30'-0" O.C. MAXIMUM AND AS INDICATED IN THE CONTRACT DOCUMENTS.
- 14. COORDINATE WITH OWNER'S EQUIPMENT SUPPLIER FOR INSTALLATION REQUIREMENTS / LOCATIONS OF FLOOR / WALL / CEILING MOUNTED ITEMS; IE. CAMERAS, TV'S, SPEAKERS, SENSORS, SECURITY WIRING, VAULTS,
- 15. CONTRACTOR SHALL CONDUCT A ROUGH ELECTRICAL INSPECTION WITH OWNER, PRIOR TO ENCLOSING WALLS, FOR THE PURPOSE OF CONFIRMING ALL J-BOX LOCATIONS FOR POWER, DATA, VOICE, SWITCH, THERMOSTAT,
- 16. CONTRACTOR TO FILL ANY AND ALL EQUIPMENT PENETRATIONS OR DEPRESSIONS INTO OR THROUGH THE EXISTING SLAB THAT WILL NOT BE UTILIZED TO FEED NEW EQUIPMENT (I.E. ABANDONED FLOOR CORES, IMPRESSION FROM PREVIOUS EQUIPMENT FLOOR PLATE REMOVAL). PENETRATIONS SHALL BE FILLED WITH NON- SHRINK GROUT. THE SIDES OF ANY EXISTING OPENINGS SHALL BE MODIFIED/TAPERED SO THAT THEY ARE WIDER AT THE TOP THAN AT THE BOTTOM. FOR LARGE OPENINGS, PROVIDE ONE (1) #5 BAR 2" UP FROM BOTTOM OF HOLE.
- 17. A TACTILE SIGN STATING 'EXIT' AND COMPLYING WITH ICC-A117.1 SHALL BE PROVIDED ADJACENT TO EACH DOOR TO AN 'AREA OF REFUGE', AN EXTERIOR AREA FOR ASSISTED RESCUE, AN EXIT STAIRWAY, AN EXIT RAMP, AN EXIT PASSAGEWAY, AND THE EXIT DISCHARGE.
- 18. PROVIDE PERMANENT MIN 3-INCH HIGH CONTRASTING COLOR MARKING AND IDENTIFICATION AT ALL FIRE WALLS, FIRE BARRIERS, FIRE PARTITIONS, SMOKE BARRIERS, SMOKE PARTITIONS OR ANY OTHER WALL REQUIRED TO HAVE PROTECTED OPENINGS OR PENETRATIONS WITHIN 15 FEET AT THE END OF EACH WALL, AND NOT EXCEEDING 30 FEET MAXIMUM HORIZONTAL INTERVALS, MINIMUM 2 LOCATIONS EACH WALL. TYPICAL FOR ACCESSIBLE CONCEALED FLOOR, FLOOR-CEILING, OR ATTIC SPACES PER CODE (MBC
- 19. CONTRACTOR TO COORDINATE WITH FURNITURE VENDOR ON FURNITURE SPECIFICATIONS, LAYOUT, AND INSTALL



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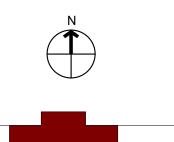
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MATTHAEI ACADEMIC RESOURCE CENTER RENOVATION

5101 John C Lodge Fwy, Detroit, MI 48202

Key Plan:



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Drawn by:

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Sheet Title: FIRST LEVEL NEW CONSTRUCITON AND RCP

Project No. 2022.038


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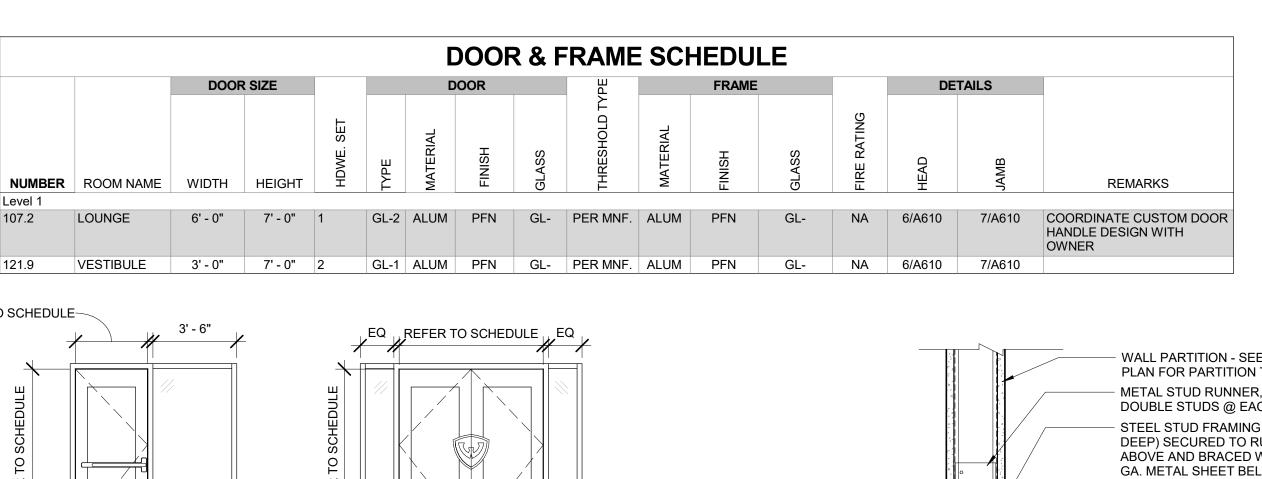
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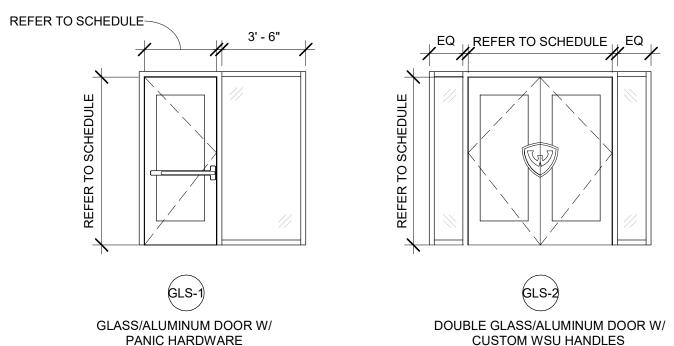
06410	- ARCHITECTURAL CASEWORK	09650	- RESILIENT FLOORING	09910	- PAINT	
PL-1	PLASTIC LAMINATE MANUFACTURER: WILSONART MODEL:STANDARD HPL PRODUCT #: 15504 COLOR: CHARCOAL VELVET FINISH: TRACELESS FINISH LOCATION: REFER TO FINISH PLAN FOR EXACT LOCATION CONTACT:	CT-1	CARPET MANUFACTURER: MATCH EXISTING COLOR: STEEL MATCH EXISTING LOCATION: LOUNGE RUBBER WALL BASE MANUFACTURER: ROPPE COLOR: LUNAR DUST 114	PT-1	INTERIOR FIELD PAINT MANUFACTURER:SHERWIN WILLIAMS COLOR: REPOSE GRAY FINISH: EGG-SHELL LOCATION: REFER TO FINISH PLAN FOR EXACT LOCATION	
09510 - SUSPENDED ACOUSTICAL CEILING			SIZE: 4 1/4"h, 1/4" THICK (USE 8' LENGTHS, NOT COIL) LOCATION: LVT & CPT, REFER TO FINISH PLAN FOR LOCATION. CONTACT:	15000 - ELECTRICAL		
				-	FACE PLATES COLOR: STAINLESS STEEL	
ACT-1	ACOUSTIC CEILING TILE MANUFACTURER: ARMSTRONG COLLECTION: ULTIMA COLOR: WHITE SIZE: 2 X 2			-	DEVICES COLOR: WHITE	
	EDGE: SQUARE LAY IN EDGE GRID PROFILE: KEEP EXISTING (WARREN)			12000	- SIMULATED STONE	
	LOCATION: SEE RCP FOR MORE DETAIL NOTE: WHEN EXISTING GRID IS PRESENT, MATCH WHEN POSSIBLE			SS-1	SIMULATED STONE MANUFACTURER: WILSONART MODEL: QUARTZ PRODUCT #: Q6012 COLOR: GREY WOLF THICKNESS: 3 CM	


FINISH SCHEDULE										
					WALL P					
RM#	ROOM NAME	FLOOR FINISH	BASE FINISH	NORTH WALL	EAST WALL	SOUTH WALL	WEST WALL	REMARKS		
107	LOUNGE	CT-1 - SEE NOTE 004 ON SHEET A110	RB-1	MATCH RECEPTION	MATCH RECEPTION	MATCH RECEPTION	MATCH RECEPTION	MILLWORK TO BE PL-1 AND SS-1		
107.1	CONFERENCE ROOM	EXIST'G TO REMAIN	EXIST'G TO REMAIN							
121.0	RECEPTION	EXIST'G TO REMAIN	EXIST'G TO REMAIN	PATCH AND RE-PAINT AS NECESSARY	PATCH AND RE-PAINT AS NECESSARY	PATCH AND RE-PAINT AS NECESSARY	PATCH AND RE-PAINT AS NECESSARY			
121.4	ADVISING	EXIST'G TO REMAIN	EXIST'G TO REMAIN	EXIST'G TO REMAIN	EXIST'G TO REMAIN	EXIST'G TO REMAIN	EXIST'G TO REMAIN			
121.6	ADVISING	EXIST'G TO REMAIN	EXIST'G TO REMAIN	EXIST'G TO REMAIN	EXIST'G TO REMAIN	EXIST'G TO REMAIN	EXIST'G TO REMAIN			
121.9	VESTIBULE	EXIST'G TO REMAIN	EXIST'G TO REMAIN							
121.10	INTERNAL VESTIBULE	EXIST'G TO REMAIN	EXIST'G TO REMAIN	MATCH EXIST'G CORRIDOR	MATCH EXIST'G CORRIDOR	N/A	MATCH EXIST'G CORRIDOR			

Level 1: 7 TOTAL ROOMS: 7






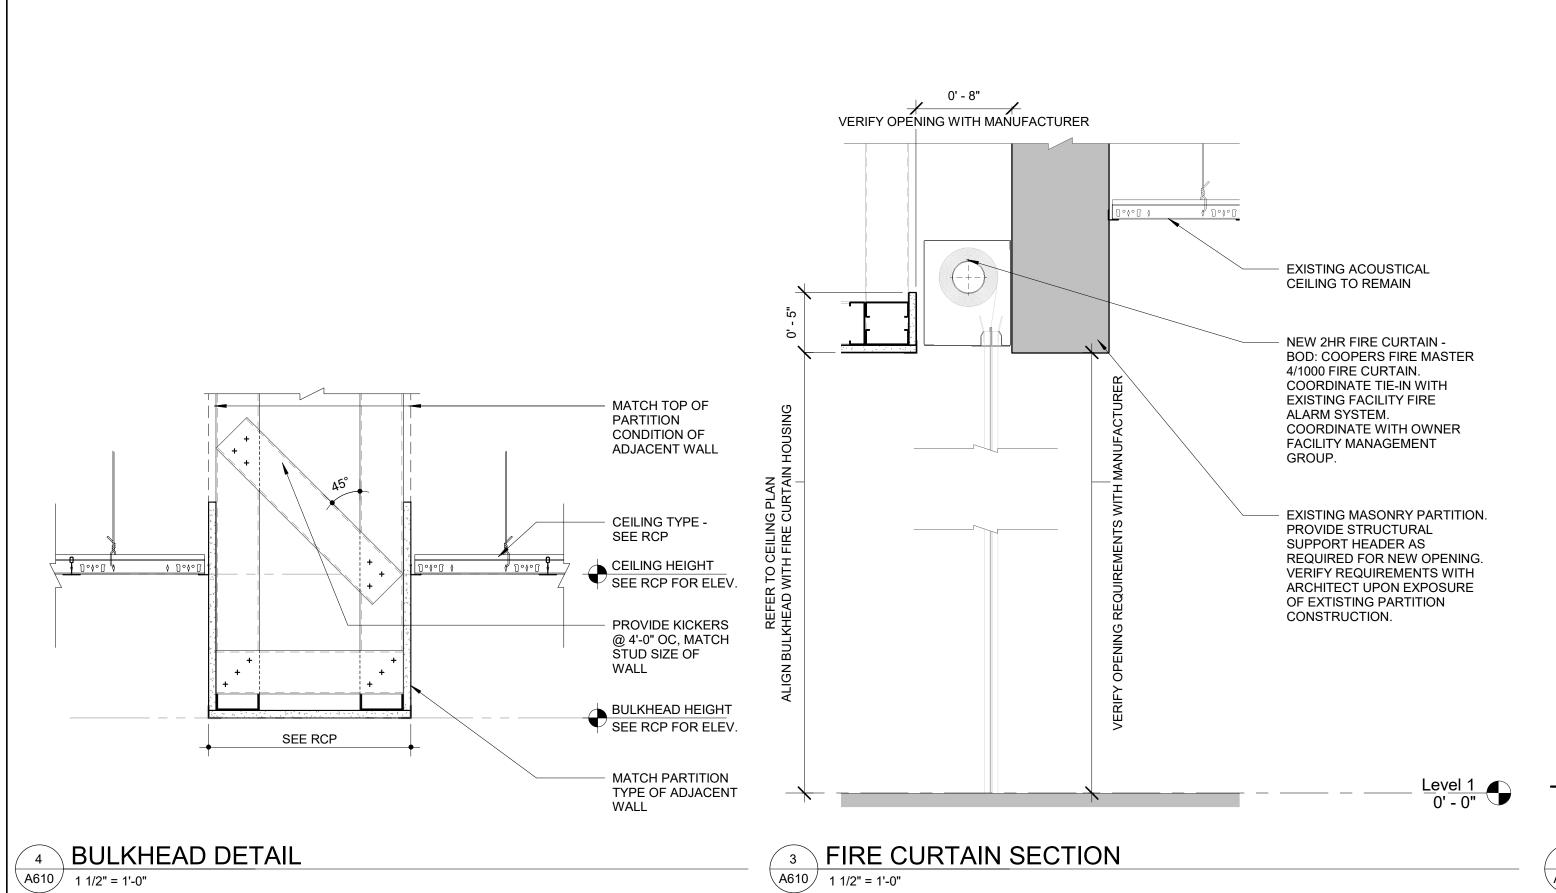


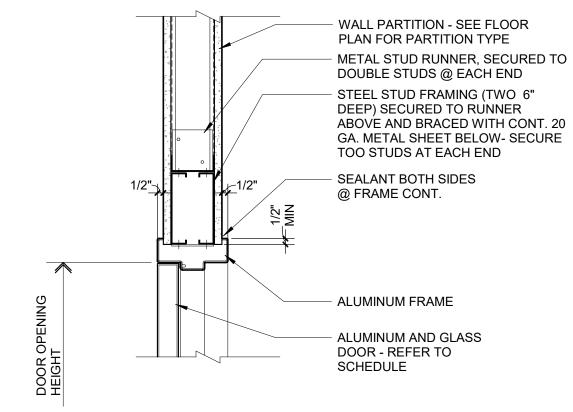




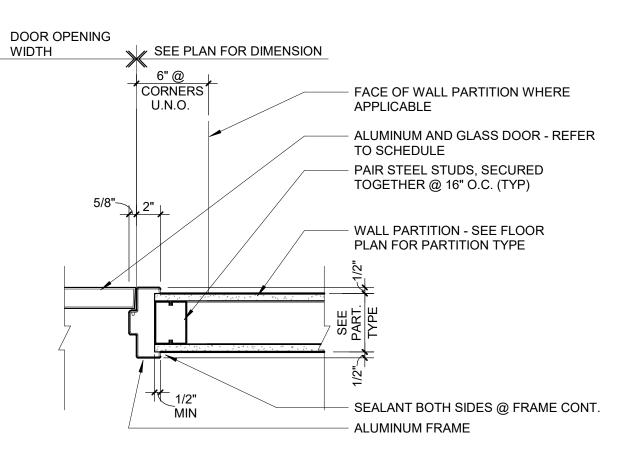

JAMB AT TYPICAL STUD PARTITION 5 JAMB A A610 1 1/2" = 1'-0"

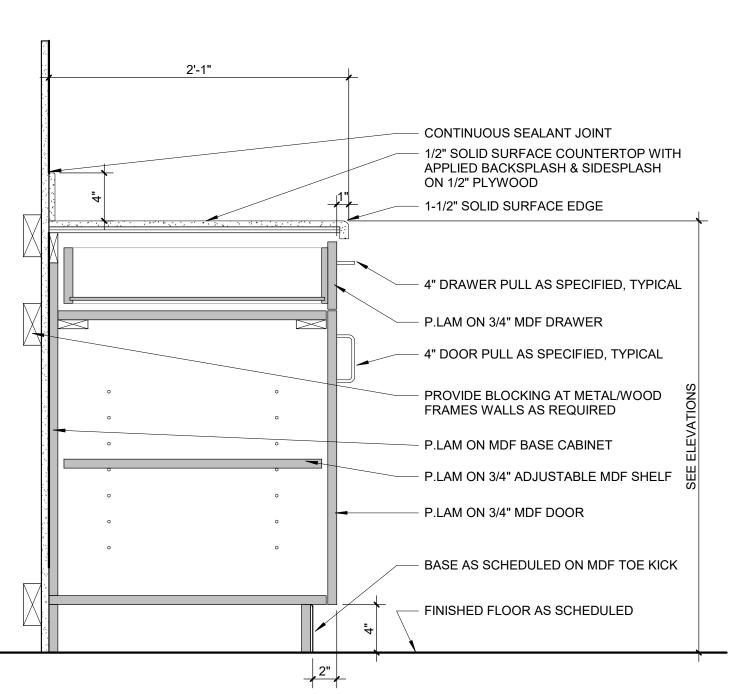



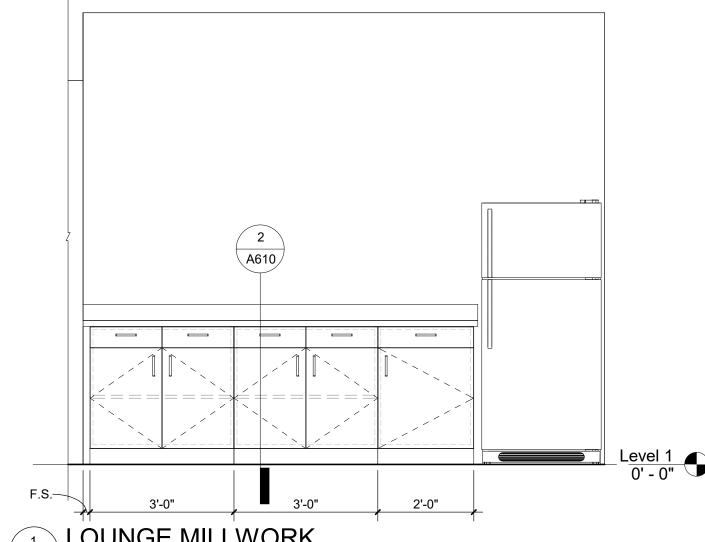

1 LOUNGE MILLWORK A610 1/2" = 1'-0"

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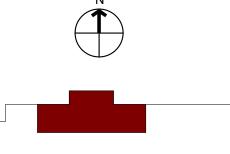
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Project:

MATTHAEI ACADEMIC RESOURCE CENTER RENOVATION

5101 John C Lodge Fwy, Detroit, MI 48202

Key Plan:



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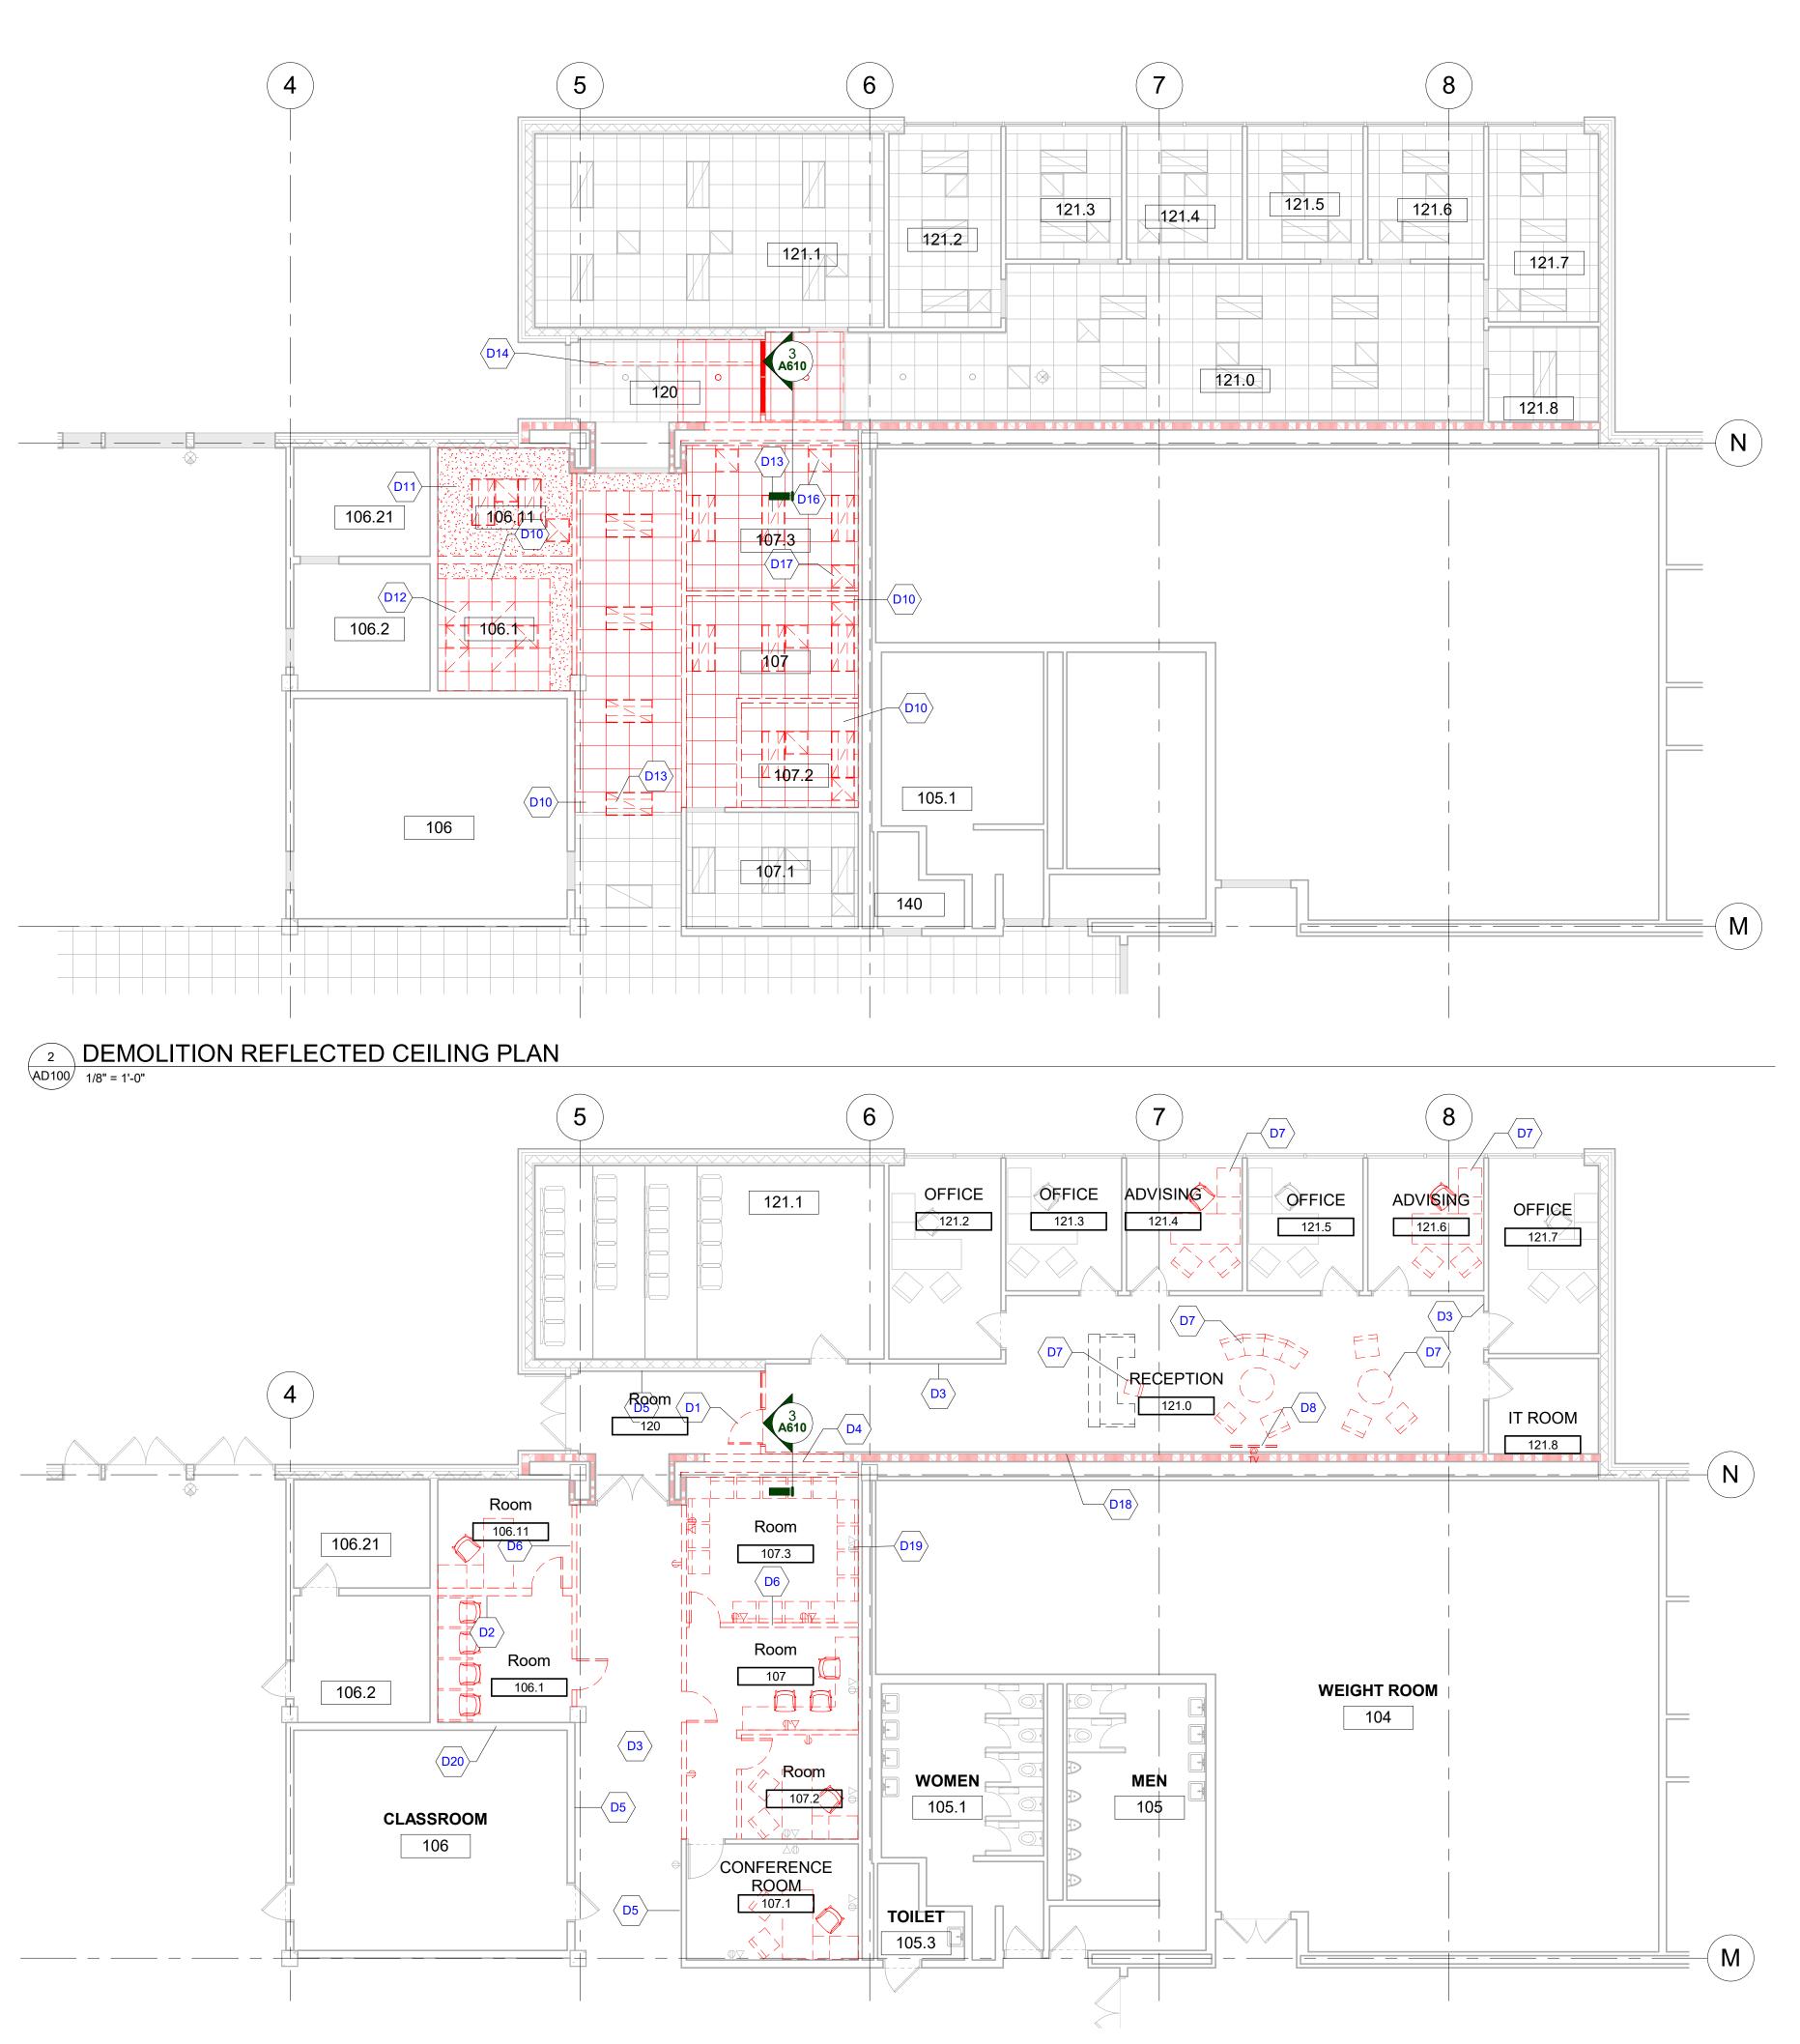
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Sheet Title: INTERIOR ELEVATIONS AND ENLARGED PLANS FIRST LEVEL

Project No. 2022.038

Sheet No.

A610



DEMOLITION PLAN

AD100 1/8" = 1'-0"

DEMOLITION KEYNOTE LEGEND

KEYNOTE	KEYNOTE DESCRIPTION
D1	REMOVE EXISTING DOOR AND DOOR FRAME AND SIDE LIGHT. CONTRACTOR TO SALVAGE ALL COMPONENTS FOR OWNERS REUSE. COORDINATE STORAGE/DELIVERY WITH OWNER.
D2	REMOVE EXISTING GLASS BOARD. CONTRACTOR TO SALVAGE AND REINSTALL GLASS BOARD.
D3	REMOVE EXISTING SIGNAGE AND SALVAGE FOR OWNER. COORDINATE STORAGE LOCATION OF REMOVED SIGNAGE.
D4	MODIFY EXISTING PARTITION AS REQUIRED FOR NEW OPENING AND FIRE CURTAIN. COORDINATE ROUGH OPENING AND BLOCKING REQUIREMENTS WITH FIRE CURTAIN MANUFACTURER. CONTRACTOR TO PROVIDE 1HR RATED BARRIER DURRING CONSTRUCTION.
D5	REMOVE EXISTING VINYL WALLPAPER. PATCH AND REPAIR WLLS AS NECESSARY, TYP.
D6	REMOVE EXISTING PARTITION WALL, PATCH AND REPAIR AS NECESSARY, TYP.
D7	EXISTING FURNITURE TO BE REMOVED BY OWNER PRIOR TO CONSTRUCTION.COORDINATE WITH OWNER IF ANY DEMO FURNITURE REMAINS.
D8	REMOVE EXISTING WALL MOUNTED TELEVISION. CONTRACTOR TO SALVAGE AND REUSE ALL COMPONENTS. SEE NEW WORK PLAN FOR NEW INSTALL LOCATION.
D10	REMOVE EXISTING CEILING TILE AND GRID AS REQUIRED FOR NEW PARTITION LAYOUT, TYP.
D11	REMOVE EXISTING GYP. BOARD CEILING AS REQUIRED FOR NEW PARTITION LAYOUT.
D12	REMOVE EXISTING 2X2 LIGHT FIXTURE. REUSE WHERE POSSIBLE, TYP.
D13	REMOVE EXISTING 2X4 LIGHT FIXTURE. REUSE WHERE POSSIBLE, TYP.
D14	REMOVE EXISTING STRIP LIGHT. REUSE WHERE POSSIBLE.
D16	REMOVE EXISTING RETURN AIR GRILLE. REUSE WHERE POSSIBLE, TYP.
D17	REMOVE EXISTING EXHAUST AIR GRILLE. REUSE WHERE POSSIBLE, TYP.
D18	EXISTING 2HR FIRE SEPARATION TO REMAIN.

EXISTING POWER AND DATA TO REMAIN.

EXISTING MOVABLE PARTITION WALL TO REMAIN.

DEMOLITION RCP LEGEND

	EXISTING CEILING GRID ASSEMBLY TO REMAIN
+ + + + + + + + + + + + + + + + + + + +	CEILING GRID ASSEMBLY TO BE REMOVED
	EXISTING CEILING FIXTURE (LIGHT, DIFFUSER, ETC.) TO REMAIN
	CEILING (LIGHT, DIFFUSER, ETC.) FIXTURE TO BE REMOVED UNLESS NOTED OTHERWISE
	CEILING FINISH TO BE REMOVED

DEMOLITION PLAN LEGEND


1. ALL DEMOLITION WORK REQUIRED IS NOT NECESSARILY LIMITED TO WHAT IS SHOWN ON THE DEMOLITION PLANS. THE INTENT IS TO REMOVE ALL MECHANICAL, ELECTRICAL, AND ARCHITECTURAL ITEMS AS REQUIRED TO FACILITATE NEW CONSTRUCTION.

CEILING FINISH TO BE REMOVED

- 2. COORDINATE SCOPE AND EXTENT OF DEMOLITION WORK WITH NEW WORK PLANS AND DETAILS.
- 3. ALL WALLS, DOORS, FRAMES, AND RELATED HARDWARE ASSEMBLIES DESIGNATED AS "TO BE REMOVED" (SHOWN AS DASHED LINES) SHALL BE COMPLETELY REMOVED AND DISPOSED OF AS DESIGNATED BY OWNER/TENANT. ALL EXISTING WALLS NOT DESIGNATED FOR DEMOLITION SHALL BE PROTECTED FROM DAMAGE AND REMAIN "AS-IS".
- 4. IN OCCUPIED BUILDINGS, ANY CONSTRUCTION BEYOND 48 HOURS MUST BE ISOLATED WITH HARD BARRIER WALL (1 HR. RATED), PER BUILDING CODE.1 HOUR FIRE RATED PLASTIC BARRIER MAY NOT BE USED. PROVIDE ANY/ALL DUST CONTROL AND INFECTION CONTROL MEASURES TO ISOLATE ALL WORK TO PROJECT AREA.
- 5. PHASED CONSTRUCTION MAY BE REQUIRED, FINAL NUMBER OF PHASES TBD BY OWNER/ ARCHITECT/ GC PRIOR TO CONSTRUCTION. CONTRACTOR PROVIDE ANY/ALL TEMP. CONSTRUCTION MEASURES AS REQUIRED BY LOCAL AHJ (EXIT SIGNS, EMERGENCY LIGHTING, CONSTRUCTION LIGHTING, EGRESS SIGNAGE, ETC.)
- 6. ALL EQUIPMENT, DOORS, FRAMES, RELATED HARDWARE, AND DESIGNATED ITEMS TO BE SALVAGED SHALL BE REMOVED, PROTECTED FROM DAMAGE, AND STORED FOR REUSE.
- 7. CLEAN AND REPAIR ALL EXISTING FLOOR FINISHES AS NECESSARY.
- 8. ALL DEMOLITION WORK SHALL BE PERFORMED IN A NEAT AND WORKMANSHIP MANNER. ALL SURFACES ADJACENT TO AND ABUTTING TO THOSE DESIGNATED "TO BE REMOVED" SHALL BE LEFT WITH A SMOOTH AND FLUSH APPEARANCE.
- 9. THE CONTRACTOR SHALL EXERCISE ALL REQUISITE CARE NECESSARY TO ENSURE THAT ALL EQUIPMENT, MATERIALS, FINISHES AND ASSEMBLIES WHICH ARE NOT BEING REMOVED ARE PROTECTED FROM DAMAGE DURING DEMOLITION AND SUBSEQUENT CONSTRUCTION OPERATIONS.
- 10. REFER TO MECHANICAL AND ELECTRICAL DEMOLITION DRAWINGS AND SPECIFICATIONS FOR ADDITIONAL DEMOLITION INFORMATION.
- 11. GENERAL PRECAUTIONS SHALL BE TAKEN AS NECESSARY TO HOLD ALL
- DISRUPTION, DUST, DIRT, NOISE, AND DEBRIS TO A MINIMUM. 12. THE CONTRACTOR SHALL COORDINATE DEMOLITION WORK WITH OWNER TO ENSURE THAT IMPACTS ON THE BALANCE OF THE BUILDING
- ARE HELD TO A MINIMUM. 13. PREPARE ALL SURFACES TO RECEIVE THE NEW WORK AND FINISHES OF
- 14. THE CONTRACTOR SHALL DESIGN, PROVIDE, INSTALL AND MAINTAIN ANY AND ALL TEMPORARY BRACING AS REQUIRED TO ENSURE THE STABILITY OF THE BUILDING ASSEMBLY AND/OR ANY SYSTEMS AND/OR SUB-ASSEMBLIES AND/OR SYSTEMS APPURTENANT THERETO UNTIL SAID ASSEMBLY AND/OR SUB-ASSSEMBLIES ARE COMPLETE, SELF-SUPPORTING AND/OR STABLE.
- 15. CONTRACTOR TO HOLD A PRE DEMOLITION WALK-THRU WITH OWNER AND SUBCONTRACTORS
- 16. SALVAGE AND RETURN SIGNAGE TO OWNER
- 17. FIRE ALARM DEVICES EXISTING, TO BE REMOVED, OR RELOCATED (TYP.) IT IS A NATIONAL TIME SYSTEM

DEMOLITION PLAN LEGEND

THE CONTRACT.

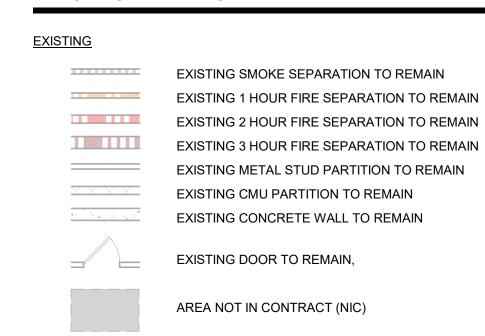

<u>DEMO</u>

	DEMO SMOKE SEPARATION
====	DEMO 1 HOUR FIRE SEPARATION
====	DEMO 2 HOUR FIRE SEPARATION
	DEMO 3 HOUR FIRE SEPARATION
	DEMO METAL STUD PARTITION
	DEMO CMU PARTITION
- A	DEMO CONCRETE WALL



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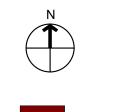
Consultants


Project:

MATTHAEI ACADEMIC RESOURCE CENTER RENOVATION

5101 John C Lodge Fwy, Detroit, MI 48202

Key Plan:



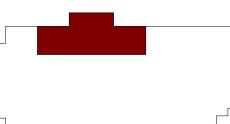

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Drawn by: JML

Checked by: JAV, MJB, AJD

Sheet Title: ARCHITECTURAL DEMOLITION PLANS

Project No. 2022.038

Sheet No.

ABBREVIATIONS AIR CONDITIONING CONDENSING UNIT NORMALLY CLOSED ACCESS DOOR NOT IN CONTRACT ABOVE FINISHED FLOOR NORMALLY OPEN AIR HANDLING UNIT NOM. NOMINAL ACCESS PANEL AUTOMATIC SPRINKLER RISER OUTSIDE AIR RETURN AIR BRITISH THERMAL UNIT RET RETURN RETURN FAN COOLING COIL RELOCATED CENTRIFUGAL FAN REBALANCE CUBIC FEET PER MINUTE CONT CONTINUATION SUPPLY AIR SMOKE DETECTOR SUPPLY FAN DIRECT DIGITAL CONTROL SPR SPRINKLER DET DETAIL SPRINKLER STANDPIPE DIA DIAMETER DOWN TOTAL PRESSURE DWG. DRAWING TYP TYPICAL EXHAUST AIR UNIT HEATER UH EXHAUST FAN UNLESS OTHERWISE NOTED UON ELEV. ELEVATION EXISTING EX. EXH EXHAUST EXIST EXISTING FIR FLOOR FEET INCHES INVERT LEAVING AIR TEMPERATURE MAX. MAXIMUM 1000 BTU/HR MECH MECHANICAL MINIMUM MISCELLANEOUS MISC

HVAC LEGEND & SYMBOLS 18x6 WITH DUCT SIZE 18 INCHES WIDE (IN PLANE OF DRAWING) AND 6 INCHES DEEP. SIZE PERTAINS TO THE ENTIRE RUN OF DUCT UNLESS OTHERWISE NOTED. 22x14ø -WITH DUCT SIZE 22 INCHES WIDE (IN PLANE OF DRAWING) AND 14 INCHES DEEP. SIZE PERTAINS TO THE ENTIRE RUN OF DUCT UNLESS OTHERWISE NOTED. 6"ø 6 INCHES IN DIAMETER. SIZE PERTAINS TO THE ENTIRE RUN OF DUCT (FROM DUCT ORIGIN AT TAP TO END OF DUCT) UNLESS OTHERWISE NOTED. VANE TURN ELBOW & AIR SPLIT TYPE DUCT TAKE-OFF RISE → INCLINED RISE IN RESPECT TO AIR FLOW DN.→ INCLINED DROP IN RESPECT TO AIR FLOW VANED ELBOW (PROVIDE ALL SQUARE OR RECTANGULAR ELBOWS VANED ELBOW (SHORT RADIUS) INDICATES FLEXIBLE DUCT (RUNOUT) OF SIZE AS SCHEDULED OR SHOWN. LENGTH SHALL NOT EXCEED 5 FT. DUCT TURNING UP VOLUME CONTROL DAMPER (MANUAL) FLEXIBLE CONNECTION OR FLEXIBLE DUCT CONNECTOR VERTICAL FIRE DAMPER MOTORIZED DAMPER COMBINATION FIRE AND SMOKE DAMPER HORIZONTAL FIRE DAMPER RF SHEILDING DAMPER THERMOSTAT POINT OF NEW CONNECTION TEMPERATURE SENSOR DUCT SMOKE DETECTOR ITEM TO BE REMOVED

GENERAL HVAC NOTES:

THE FOLLOWING NOTES APPLY TO ALL HVAC DRAWINGS, EXCEPT WHERE OTHERWISE INDICATED.

1. WHEREVER VOLUME DAMPERS OCCUR ABOVE CEILINGS WITHOUT REMOVABLE TILE AND AN ACCESS PANEL IS NOT FURNISHED, PROVIDE AN EXPOSED DAMPER REGULATOR TO ALLOW DAMPER ADJUSTMENT FROM BELOW CEILING. UNIT TO BE EQUAL TO VENTLOCK No. 666 IN 1/2"x3/8" SIZE.

2. ALL DIMENSION SHOWN FOR DUCTWORK ARE NET INSIDE DIMENSIONS.

3. DIFFUSER AND REGISTER LOCATIONS SHALL BE COORDINATED WITH ARCHITECTURAL REFLECTED CEILING PLAN.

4. THOUGH SOME OFFSETS & TRANSITIONS ARE SHOWN IN PIPING AND SHEET METAL TO HELP INDICATE THE PHYSICAL RELATIONSHIP BETWEEN THEM. IT IS NOT THE INTENT OF THE DRAWINGS TO SHOW ALL PIPING AND SHEET METAL OFFSET & TRANSITIONS REQUIRED, THE CONTRACTOR SHALL FULLY COORDINATE THE MECHANICAL WORK WITHIN ITSELF AND WITH THE WORK OF ALL TRADES TO PROVIDE COMPLETE AND OPERABLE SYSTEMS WITHOUT INTERFERENCES.

5. DUCT PRESSURE CONSTRUCTION CLASSIFICATION SHALL BE AS SPECIFIED.

6. ALL ROUND RUNOUTS AND DROPS TO DIFFUSERS SHALL BE SAME NOMINAL SIZE AS INDICATED ON THE DRAWINGS.

7. ALL PIPING AND DUCTS IN FINISHED ROOMS OR SPACES SHALL BE CONCEALED IN FURRED CHASE OR SUSPENDED CEILING.

8. ACCESS PANELS AND DOORS ARE REQUIRED THROUGH BUILDING CONSTRUCTION ASSEMBLIES SUCH AS WALLS, CEILING, PARTITONS AND FLOORS TO SERVICE AND MAINTAIN DAMPERS, CONTROL MOTORS, REGULATORS, VALVES, FLEXIBLE DUCT CONNECTIONS AND OTHER ITEMS OR DEVICES INCORPORATED IN MECHANICAL WORK, SUCH PANELS AND DOORS SHALL BE PROVIDED AND INSTALLED UNDER THE ARCHITECTURAL SPECIFICATIONS. MECHANICAL CONTRACTOR SHALL COORDINATE LOCATION OF ACESS DOORS AND PANELS AND VERIFY THE EXACT QUANTITY, SIZE, FIRE-RATING AND LOCATION AFTER THE SYSTEMS AND EQUIPMENT REQUIRING ACCESS HAVE BEEN INSTALLED AND PRIOR TO THE CLOSURE OF THE AFFECTED CEILING AND BUILDING ASSEMBLIES. MINIMUM ACCESS PANEL AND DOOR SIZE SHALL BE 24 INCHES BY 18 INCHES UNLESS OTHERWISE NOTED.

9. ALL DUCTWORK PENETRATIONS THROUGH FIRE-RATED WALLS AND FLOORS SHALL BE PROVIDED WITH FIRE DAMPERS AND ACCESS DOOR.

MECHANICAL SHEET INDEX		
M000	MECHANICAL SYMBOLS LIST, INDEX, NOTES & SPECIFICATIONS	
M100	DEMOLITION & NEW WORK HVAC PLANS & DETAILS	
F100	FIRST LEVEL NEW WORK FIRE PROTECTION PLAN	

MECHANICAL SPECIFICATION

MECHANICAL MATERIALS, METHODS AND EXECUTION WORK INCLUDED:

A. FURNISH ALL LABOR AND MATERIAL, APPLIANCES, EQUIPMENT AND SUPERVISION TO PUT IN PLACE A COMPLETE AND FUNCTIONING MECHANICAL INSTALLATION READY FOR OPERATION, AS SPECIFIED HEREIN AND AS INDICATED ON THE DRAWINGS. SYSTEMS SHALL INCLUDE BUT NOT NECESSARILY LIMITED TO THE FOLLOWING MAJOR EQUIPMENT OR OPERATIONS: HEATING, VENTILATING AND AIR CONDITIONING. FIRE PROTECTION.

A. "PROVIDE": TO FURNISH AND COMPLETELY INSTALL SPECIFIED PRODUCTS AND INCIDENTALS. WHETHER SPECIFICALLY INDICATED OR NOT, NECESSARY FOR A COMPLETE, FUNCTIONAL INSTALLATION. INCLUDES ALL GENERAL AND SPECIALIZED LABOR,

EQUIPMENT AND TOOLS NECESSARY TO COMPLETE THE INSTALLATION. B. "PIPING": A COMPLETE SYSTEM, INCLUDING PIPE, TUBING, FITTINGS, HANGERS, SUPPORTS, VALVES, AND ALL SPECIALTIES THAT COMPRISE A FULLY FUNCTIONAL PIPING SYSTEM, WHETHER SPECIFICALLY INDICATED OR NOT.

CODES, ORDINANCES, AND STANDARDS: A. ALL WORK SHALL CONFORM IN ALL RESPECTS TO THE REQUIREMENTS OF THE LATEST ADOPTED FEDERAL, STATE AND LOCAL

CODES, ORDINANCES, AND STANDARDS HAVING JURISDICTION OVER THE WORK. WHERE CONTRACT DOCUMENT REQUIREMENTS EXCEED THE REQUIREMENTS OF THE REFERENCED CODES, ORDINANCES, AND

STANDARDS, THE CONTRACT DOCUMENT REQUIREMENTS SHALL BE TAKEN AS MINIMUM. C. ALL EQUIPMENT CONTAINING ELECTRICAL WIRING AND/OR ELECTRICAL COMPONENTS SHALL HAVE A UNDERWRITERS

LABORATORIES (UL) "PACKAGE" LABEL. D. ALL GAS FIRED EQUIPMENT SHALL HAVE THE AMERICAN GAS ASSOCIATION (AGA) LABEL.

PERMITS, FEES AND INSPECTIONS:

A. SECURE ALL NECESSARY PERMITS, CONNECTION FEES, TAD FEES, LICENSES AND APPROVALS AND ARRANGE FOR ALL

INSPECTIONS, INCLUDE ALL RELATED COSTS. B. FURNISH CERTIFICATES OF FINAL INSPECTION AND APPROVAL UPON COMPLETION OF PROJECT.

EXAMINATION OF SITE: A. VISIT PROJECT SITE AND BECOME FULLY COGNIZANT OF ALL EXISTING ARCHITECTURAL, MECHANICAL, ELECTRICAL, STRUCTURAL

AND SITE CONDITIONS, OR EXISTING CODE VIOLATIONS WHICH MAY AFFECT THE WORK. NOTIFY ARCHITECT PRIOR TO SUBMITTING BID IF REVISIONS TO CONTRACT DOCUMENTS ARE NECESSARY TO RECTIFY ANY OF THE AFOREMENTIONED EXISTING CONDITIONS.

C. NO "EXTRAS" TO CONTRACT PRICE WILL BE ALLOWED AFTER RECEIVING BID IN ORDER TO RECTIFY EXISTING CONDITIONS IN ORDER TO MEET THE DESIGN INTENT OF THE CONTRACT DOCUMENTS OR SATISFY CODE REQUIREMENTS.

COORDINATE ALL WORK BEFORE AND DURING CONSTRUCTION WITH ALL OTHER AFFECTED TRADES.

WHERE INTERFERENCES DEVELOP, NOTIFY ARCHITECT FOR RESOLUTION OF CONFLICT.

RELOCATION OF CONFLICTING INSTALLED WORK, DUE TO LACK OF COORDINATION, OR POOR COORDINATION WILL NOT

APPROVED MANUFACTURERS:

A. USE ONLY MATERIALS SPECIFICALLY INDICATED IN CONTRACT DOCUMENTS, OR COMPARABLE MATERIALS BY OTHER LISTED ACCEPTABLE MANUFACTURERS. NOTE THAT "ACCEPTABLE MANUFACTURER" DOES NOT CONSTRUE AUTOMATIC APPROVAL OF SPECIFIC MATERIALS BY ONE OR ALL OF THE LISTED ACCEPTABLE MANUFACTURERS. ARCHITECT AND/OR ENGINEER OF RECORD RESERVES THE RIGHT OF FINAL DETERMINATION OF ACCEPTABILITY OF EACH ITEM.

SUBMIT COMPLETE SHOP DRAWINGS FOR ALL MATERIALS AND EQUIPMENT INTENDED FOR USE ON THIS PROJECT. SHOP DRAWINGS SHALL CLEARLY INDICATE ALL PHYSICAL, PERFORMANCE AND ELECTRICAL CHARACTERISTICS FOR ALL MATERIALS

SUBMIT ELECTRONIC COPY OF ALL SHOP DRAWINGS FOR REVIEW. D. NO WORK IS TO BE INSTALLED PRIOR TO RETURN OF ARCHITECT REVIEWED SHOP DRAWINGS.

OPERATION AND MAINTENANCE MANUALS:

A. UPON COMPLETION OF PROJECT, SUBMIT TWO (2) COMPLETE BOUND SETS OF OPERATING AND MAINTENANCE MANUALS FOR ALL EQUIPMENT AND SYSTEMS INSTALLED IN THIS PROJECT.

MANUALS SHALL INCLUDE GUARANTEE(S), COMPLETE OPERATING INSTRUCTIONS, REPAIR PARTS LIST, PREVENTATIVE MAINTENANCE SCHEDULE, BELT AND FILTER SCHEDULE, AND LIST OF ALL SUBCONTRACTORS ASSOCIATED WITH THE WORK, INCLUDING TELEPHONE NUMBER AND CONTACT PERSON.

A. PRIOR TO FINAL ACCEPTANCE BY OWNER, PROVIDE ALL PERSONNEL, EQUIPMENT, AND LABOR AS NECESSARY TO INSTRUCT OWNER'S PERSONNEL IN PROPER OPERATION AND MAINTENANCE OF THE SYSTEMS AND EQUIPMENT INSTALLED IN THIS PROJECT. PROVIDE INSTRUCTIONAL SESSION DURING TIME PERIOD AGREED TO WITH OWNER.

ALL CUTTING AND PATCHING SHALL BE PROVIDED BY THE GENERAL TRADES UNDER THE DIRECTION OF THE MECHANICAL TRADES. COST WILL BE PAID BY THE MECHANICAL TRADE REQUESTING THE WORK.

B. RESTORED SURFACES SHALL BE OF SAME MATERIALS AND QUALITY AS ADJACENT SURFACES, AND SHALL MATCH SURROUNDING SURFACES, AND/OR BE RESTORED TO PRE-CONSTRUCTION CONDITION.

PROTECTION OF EXISTING SERVICES:

A. PROTECT FROM ALL DAMAGE, EXISTING SERVICES (I.E., GAS, WATER, ELECTRICAL, ETC.), ENCOUNTERED IN THE WORK, NOT SPECIFICALLY INDICATED TO BE DEMOLISHED. INCLUDE ALL RELATED COSTS.

REPAIR AND/OR REPLACE EXISTING ACTIVE SERVICES INTENDED TO REMAIN IN SERVICE, BUT DAMAGED DURING THE COURSE OF CONSTRUCTION. ABSORB ALL RELATED COSTS. NO "EXTRAS" WILL BE PAID TO RESTORE EXISTING ACTIVE SERVICES DAMAGED DURING CONSTRUCTION.

ARCHITECT WILL DETERMINE COURSE OF ACTION WHEN EXISTING INACTIVE SERVICES ARE DAMAGED DURING COURSE OF CONSTRUCTION. ABSORB ALL COSTS RELATIVE TO ADDITIONAL DEMOLITION, TERMINATION, RELOCATION AND/OR RESTORATION OF EXISTING, DAMAGED INACTIVE SERVICES AS DIRECTED BY ARCHITECT.

SUPPLY AIR DIFFUSER

RETURN AIR GRILLE

PROVIDE ALL ELECTRICAL WORK ASSOCIATED WITH, AND NECESSARY TO COMPLETE THIS PROJECT, WHICH IS NOT INCLUDED AS

ELECTRICAL TRADES WORK. PROVIDE ALL ELECTRICAL WORK. AS APPLICABLE. IN ACCORDANCE WITH DIVISION 16 REQUIREMENTS.

CONTRACTOR SHALL BE RESPONSIBLE FOR VERIFICATION (WITH ELECTRICAL TRADES) OF CORRECT VOLTAGES FOR ALL MECHANICAL EQUIPMENT. IN CASE OF DISCREPANCY, NOTIFY ENGINEER IMMEDIATELY AND PRIOR TO SHOP DRAWING SUBMITTALS. FAILURE TO COMPLY WITH THIS REQUIREMENT HOLDS THE CONTRACTOR FULLY RESPONSIBLE FOR ANY SUBSEQUENT PROBLEMS

A. PRIOR TO FINAL ACCEPTANCE BY OWNER, THOROUGHLY CLEAN ALL WORK INSIDE AND OUT AS APPLICABLE, AND LEAVE ALL SYSTEMS AND EQUIPMENT IN PERFECT WORKING ORDER. THOROUGHLY CLEAN ALL PLUMBING FIXTURES, EXPOSED PIPING, FLOOR DRAIN GRATES, AND CLEANOUT COVERS AS APPLICABLE.

A. REFER TO ARCHITECTURAL SPECIFICATIONS FOR GUARANTEES, IF NONE EXIST THE FOLLOWING MINIMUM GUARANTEES SHALL BE

PROVIDED. PROVIDE A ONE (1) YEAR GUARANTEE COVERING ALL LABOR AND MATERIAL PROVIDED IN THIS PROJECT. GUARANTEE SHALL INCLUDE ALL SHIPPING AND TRANSPORTATION CHARGES NECESSARY TO RETURN DEFECTIVE MATERIALS TO MANUFACTURER, AS WELL AS LABOR CHARGES NECESSARY TO REMOVE AND REPLACE DEFECTIVE MATERIALS.

PROVIDE 5 YEAR GUARANTEE FOR ALL COMPRESSORS. 3. DEFECTIVE MATERIALS AND/OR EQUIPMENT MAY BE REPAIRED IN LIEU OF REPLACED WITH PRIOR APPROVAL OF ARCHITECT AND/OR OWNER.

SHEET METAL NOTES:

INSTALL TRANSFER GRILLES IN ALL FULL HEIGHT PARTITIONS TO ALLOW RETURN AIR FLOW. SIZE PER MECHANICAL ENGINEER REQUIREMENTS. THESE SHALL BE FIRE DAMPERS IN RATED WALLS.

BLANK-OFF RETURN DUCTWORK IN AREAS OF WORK THAT CREATES DUST TO PREVENT DEBRIS FROM ENTERING MECHANICAL SYSTEM.

DUCTWORK ON INLET OF V.A.V. BOXES SHALL BE CONSTRUCTED AND SEALED IN ACCORDANCE WITH THE REQUIREMENTS OF THE LATEST SMACNA'S ISSUE OF "HIGH PRESSURE DUCT CONSTRUCTION STANDARDS".

ALL DUCTWORK ON DISCHARGE OF V.A.V. BOXES, ALL RETURN AIR DUCTWORK AND EXHAUST AIR DUCTWORK SHALL BE CONSTRUCTED AND SUPPORTED IN ACCORDANCE WITH THE REQUIREMENTS OF THE LATEST SMACNA'S ISSUE OF "LOW PRESSURE DUCT CONSTRUCTION

IN ADDITION, ALL JOINTS AND SEAMS SHALL BE SEALED WITH DUCT SEALANT EQUAL TO FOSTER #32-14. APPROVED SEALANT MANUFACTURERS: 3M COMPANY, BENJAMIN FOSTER COMPANY, UNITED SHEET METAL, FLINTKOTE.

ALL ROUND TAKE-OFFS DOWNSTREAM OF TERMINAL UNITS SHALL BE MADE WITH CONICAL TAKE-OFF SPIN-IN FITTINGS TYPE SM-2DG, WITH FACTORY INSTALLED ADJUSTABLE DAMPER AS MANUFACTURED BY GENERAL ENVIRONMENT CORPORATION, GLENDALE, CALIFORNIA OR

AT EACH POINT OF CONNECTION OF DUCTWORK TO FANS, PROVIDE A FLEXIBLE CONNECTION, VENTFABRICS, INC., "VENTGLAS L.A." NOT LESS THAN 12" IN LENGTH AND MADE OF HEAVY GRADE GLASS FABRIC DOUBLE COATED WITH NEOPRENE AND PROVIDED WITH A SUITABLE FRAME AT EACH END ARRANGED FOR BOLTING TO INLET AND OUTLET OF FAN AND DUCTWORK, RESPECTIVELY.

FOR RANGE HOOD EXHAUST FANS, WHERE INDICATED, PROVIDE VENTFABRICS, INC., "VENTBESTOS" FLEXIBLE CONNECTIONS.

ALL AS APPROVED BY THE FIRE MARSHAL, AND ANY OTHER LOCAL AUTHORITY HAVING JURISDICTION.


ALL ELBOWS AND TURNS SHALL BE MADE WITH A RADIUS NOT LESS THE 1-1/2" TIMES THE DUCT DIAMETER OR WIDTH. WHERE BUILDING CONSTRUCTION DOES NOT PERMIT A LONG RADIUS ELBOW OR TURN OR IF SHOWN ON THE CONTRACT DOCUMENTS, ACOUSTICAL TURNING VANES AND DEFLECTORS SHALL BE

FIRE PROTECTION:

FIRE PROTECTION CONTRACTOR SHALL SUBMIT NECESSARY DRAWINGS AND DOCUMENTS TO LOCAL AND STATE AGENCIES AND OBTAIN APPROVALS OF SAME. FIRE PROTECTION CONTRACTOR SHALL DESIGN AND PROVIDE ALL MODIFICATIONS TO THE SPRINKLER SYSTEM INCLUDING RELOCATION OF HEADS TO ACCOMMODATE NEW CEILING AND WALL CONFIGURATIONS AS SHOWN OR REQUIRED COMPLYING WITH N.F.P.A. 13, U.L. AND ALL STATE AND LOCAL CODES.

SPRINKLER HEADS ARE TO MATCH EXISTING CONCEALED TYPE WITH WHITE COVER. ALL SPRINKLER HEADS AND INCANDESCENT LIGHT FIXTURES SHALL BE CENTERED WITHIN THE GRID U.N.O. THE FIRE PROTECTION CONTRACTOR SHALL COORDINATE HEAD AND BRANCH LINE LOCATIONS TO ALLOW INSTALLATION OF LIGHTING, GRILLES AND DUCTWORK

THE FIRE PROTECTION CONTRACTOR SHALL RELOCATE EXISTING HEADS AND BRANCH LINES AS REQUIRED TO ACCOMMODATE NEW MECHANICAL WORK LIGHT FIXTURE LAYOUT AND ALL APPLICABLE CODES.

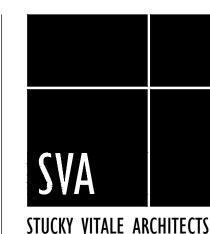


27172 WOODWARD AVENUE ROYAL OAK. MI 48067-0925

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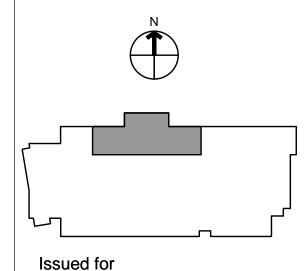


Project:

MATTHAEI ACADEMIC RESOURCE CENTER RENOVATION

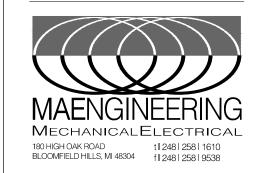5101 John C Lodge Fwy. Detroit, MI 48202

Key Plan:



07.07.22

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Sheet Title:

MECHANICAL SYMBOLS LIST, INDEX, NOTES & SPECIFICATIONS

| Project No. : 2022.038

Sheet No. :

9:55am

D\MECH\81520-M100

AD\FILES\81\81520-WSSU

1 DEMOLITION HVAC PLAN

M100 1/8" = 1'-0"

OFFICE

121.2

ADVISING


121.4

NEW WORK HVAC KEY NOTES:

- 1 EXISTING RELOCATED SUPPLY AIR DIFFUSER/RETURN AIR GRILLE.
- (2) EXISTING RELOCATED RETURN AIR GRILLE WITH NEW BOOT.
- 3 EXISTING RELOCATED THERMOSTAT. EXTEND WIRING TO THIS

GENERAL HVAC NOTES:

A. COORDINATE ALL WORK WITH OTHER TRADES.

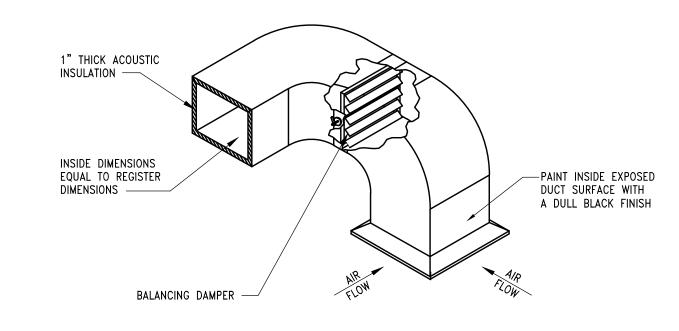

DETAIL OF A TYPICAL SOUND INSULATED RETURN

1 AIR PLENUM FOR OFFICES AND CONFERENCE ROOMS

SCALE: NONE

DEMOLITION HVAC KEY NOTES:

- REMOVE, CLEAN AND RELOCATE EXISTING AIR DIFFUSER/RETURN AIR GRILLE. AND ALL ASSOCIATED DUCT WORK. PREPARE BRANCH DUCT TO ACCEPT NEW CONNECTION.
- REMOVE, CLEAN AND RELOCATE EXISTING RETURN AIR GRILLE.
 REMOVE AND LEGALLY DISCARD ASSOCIATED DUCTWORK TO MAIN
- REMOVE, CLEAN AND RELOCATE EXISTING THERMOSTAT. EXTEND WIRING AS NECESSARY TO ACCOMMODATE NEW LOCATION.

GENERAL HVAC NOTES:

A. COORDINATE ALL WORK WITH OTHER TRADES.



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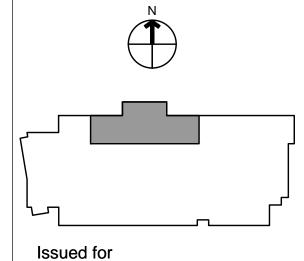


Project:

MATTHAEI ACADEMIC RESOURCE CENTER RENOVATION

5101 John C Lodge Fwy, Detroit, MI 48202

Key Plan:



07.07.22

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DEMOLITION & NEW WORK **HVAC PLANS & DETAILS**

Project No. :

2022.038

Sheet No.: M100

/81

ELECTRICAL SPECIFICATIONS:

ALL WORK SHALL BE IN ACCORDANCE WITH NATIONAL ELECTRICAL CODE, LATEST EDITION, AND ALL LOCAL AND STATE AUTHORITIES HAVING JURISDICTION THEREOF.

ALL EQUIPMENT SHALL BE SPECIFICATION GRADE AND SHALL HAVE U.L. LABEL FOR INTENDED USE. ELECTRICAL SYSTEMS SHALL BE COMPLETE IN EVERY DETAIL, INCLUDING ALL INCIDENTAL ITEMS FOR A PROPER AND FUNCTIONING INSTALLATION SUBJECT TO FINAL APPROVAL OF ARCHITECT/ENGINEER.

ALL REQUIRED PERMIT AND INSPECTIONS SHALL BE OBTAINED BY CONTRACTOR AND SUCH COSTS SHALL BE INCLUDED IN BID PRICE FOR THIS WORK.

PROVIDE UL LISTED SYSTEM FOR FIRE STOPPING PENETRATIONS THROUGH FIRE RATED ASSEMBLIES. PROVIDE SYSTEM WITH EQUAL OR GREATER RATING THAN ASSEMBLY. REFER TO ARCHITECTURAL DOCUMENTS FOR RATINGS AND LOCATIONS OF ASSEMBLIES.

EXAMINATION OF SITE IS MANDATORY. CONTRACTOR IS HEREBY HELD TO HAVE EXAMINED THE SITE AND HAVE INCLUDED IN HIS BID PRICE ALL COSTS DUE TO SITE AND FIELD CONDITIONS.

COMPLETE IDENTIFICATION OF PROJECT ELECTRICAL COMPONENTS IS REQUIRED. IDENTIFY ALL PANELS, DISCONNECTS, CONTROL DEVICES, ETC., WITH THE NOMENCLATURE INDICATED ON THE DOCUMENTS AND WITH POWER SOURCE AND ELECTRICAL RATINGS USING PLASTIC LAMINATE NAMEPLATE. INSTALL TYPEWRITTEN DIRECTORIES OF ALL CIRCUITS ON INSIDE OF PANELS. IDENTIFY WIRING DEVICE COVERPLATES WITH PANELBOARD AND BRANCH CIRCUIT NUMBER SERVING DEVICE, E.G. "A-15". PROVIDE ¼" MACHINE-WRITTEN BLACK LETTERING ON CLEAR PLASTIC ADHESIVE TAPE. LOCATE ON BOTTOM FRONT OF COVERPLATE, CENTERED BELOW WIRING DEVICE(S). SUBMIT SAMPLE OF LABELED TAPE WITH WIRING DEVICE/COVERPLATE SUBMITTAL. SAMPLE MAY BE ADHERED TO PAPERWORK IN SUBMITTAL, RATHER THAN TO A COVERPLATE.

PROVIDE TEMPORARY POWER AND LIGHTING DURING CONSTRUCTION. REMOVE TEMPORARY WIRING UPON COMPLETION OF THE PROJECT. TEMPORARY SERVICES SHALL BE AS REQUIRED, BY N.E.C. AND OSHA. CONTRACTOR IS RESPONSIBLE TO MEET WITH UTILITY TO FOR TEMPORARY POWER PROVISION AND ALL REQUIRED SKID UNITS.

GROUND CONTINUITY SHALL BE MAINTAINED THROUGHOUT THE ELECTRICAL SYSTEM. INSTALL EQUIPMENT GROUNDING CONDUCTOR WITH EVERY CIRCUIT.

COORDINATE SIZE AND LOCATION OF ANY REQUIRED ACCESS PANELS IN WALLS OR FINISHED CEILINGS WITH ARCHITECT PRIOR TO INSTALLATION.

UNLESS A LONGER PERIOD IS SPECIFIED IN INDIVIDUAL PARAGRAPHS, PROVIDE A MINIMUM OF ONE YEAR WARRANTY ON ALL ELECTRICAL WORK BEGINNING THE DATE OF FINAL ACCEPTANCE OF THE PROJECT BY THE OWNER.

<u>SUBMITTALS:</u>
SUBMIT SHOP DRAWINGS FOR ALL MAJOR COMPONENTS OR SYSTEMS OF THE PROJECT. SUBMIT ADDITIONAL SHOP DRAWINGS IF REQUESTED BY ENGINEER.

NO APPARATUS OR EQUIPMENT SHALL BE SHIPPED FROM STOCK OR FABRICATED UNTIL ITS SHOP DRAWINGS HAVE BEEN STAMPED 'REVIEWED" OR "APPROVED AS NOTED". SUBMIT DATA REQUIRED FOR TRANSFORMERS SUCH AS EFFICIENCY, REGULATION, CORE LOSS AND SOUND LEVELS. (SEE APPLICABLE

SUBMIT SYSTEM COMPONENTS, PRODUCT DATA AND SHOP DRAWINGS COMPLETE FOR EACH SYSTEM UNDER ONE SUBMITTAL. DO NOT BREAK OUT EQUIPMENT FOR ONE SYSTEM BETWEEN MULTIPLE

ALL SHOP DRAWINGS MUST BE CLEARLY MARKED TO SHOW EQUIPMENT SUBMITTED AND ANY DEVIATIONS FROM SPECIFICATIONS SHALL BE NOTED THEREON. DO NOT INCLUDE ONLY MODEL NUMBERS TO INDICATE SUBMITTED EQUIPMENT. STRIKE OUT ANY INFORMATION ON PRODUCT DATA THAT IS NOT PROJECT SPECIFIC, AND EDIT RELEVANT INFORMATION TO SHOW ACTUAL EQUIPMENT SUBMITTED. ELECTRICAL CONTRACTOR MUST SIGN AND APPROVE ALL SHOP DRAWINGS PRIOR TO SUBMITTAL. UNIQUELY NUMBER EACH PAGE IN SUBMITTAL.

IF DIFFERENT SYSTEMS ARE INCLUDED IN ONE SUBMITTAL. CLEARLY SEPARATE INFORMATION AND PROVIDE DIFFERENT SUB-NUMBERING OF SYSTEMS. SHOP DRAWINGS THAT ARE INCOMPLETE, UNSIGNED AND NOT PLAINLY MARKED WILL NOT BE REVIEWED.

DEMOLITION AND RENOVATION WORK:

DISCONNECT, REMOVE, RELOCATE, REWIRE OR DISPOSE OF ANY EQUIPMENT INTERFERING WITH NEW CONSTRUCTION OR AFFECTED BY RENOVATION WORK.

ANY ELECTRICAL EQUIPMENT OR SYSTEMS WHICH ARE TO REMAIN, AND ARE AFFECTED BY THIS WORK, SHALL BE IMMEDIATELY RESTORED TO FULL OPERATING CONDITION AND AT NO ADDITIONAL COST TO

EQUIPMENT REMOVED SHALL BE DISPOSED OF AS DIRECTED, EITHER TO STORAGE OR OFF THE

WHERE SERVICES OR CIRCUITS ARE DISCONNECTED OR DISCONTINUED. IT IS MANDATORY THAT ANY EXISTING UNUSED WIRING BE REMOVED TO THE SOURCE UNLESS SPECIFICALLY NOTED ON THE DRAWINGS. IT IS THE INTENT OF THIS ARTICLE TO PERMANENTLY DISCONNECT ALL UNUSED CIRCUITS AT THE MAIN SOURCE WHENEVER POSSIBLE. NO ENERGIZED CIRCUIT SHALL BE TAPED AND ABANDONED IN OUTLET BOXES UNLESS SO SPECIFIED ON DRAWINGS.

CIRCUIT TRACE EXISTING TO REMAIN CIRCUITS AS NECESSARY FOR PROPER IDENTIFICATION, AND AS REQUIRED TO PERFORM AND DOCUMENT WORK.

REMODELING WORK INVOLVING EXISTING BRANCH CIRCUIT PANELBOARD SHALL BE SUCH THAT, WHEN ALL WORK IS COMPLETED EXISTING PANELS ARE PROVIDED WITH NEW AND UPDATED ACCURATE DIRECTORIES. ALL VACATED CIRCUITS SHALL BE MARKED SPARE. WHEN NEW BREAKERS ARE REQUIRED, THEY SHALL BE INSTALLED IN EXISTING SPACES AND SHALL MATCH THOSE THAT ARE EXISTING. PROVIDE NEW PANELS IF REQUIRED AND WHERE INDICATED.

CONTRACTOR MAY USE EXISTING CONDUITS AND OUTLET BOXES, PROVIDED THEY ARE IN GOOD ELECTRICAL CONDITION AND THE INSTALLATION IS APPROVED BY THE AHJ. RE-SUPPORT EXISTING TO REMAIN CONDUIT AND BOXES IN RENOVATION AREA IF INADEQUATELY SUPPORTED. PROVIDE SUPPORT AS REQUIRED TO COMPLY WITH NEC AND AHJ REQUIREMENTS.

IT IS THE INTENT OF THE OVERALL DESIGN TO CONCEAL ALL WORK EXCEPT IN UNFINISHED AREAS. CUT AND PATCH EXISTING SURFACES AS REQUIRED FOR A CONCEALED INSTALLATION.

ALL ELECTRICAL OPENINGS THAT ARE ABANDONED IN WALLS, CEILINGS OR FLOOR SHALL BE PROVIDED WITH SUITABLE BLANK COVER PLATES. ABANDONED FLOOR OUTLETS AND PENETRATIONS SHALL BE FILLED TO MATCH EXISTING SURROUNDING CONDITIONS.

CONDUITS AND OTHER PARTS OF ELECTRICAL SYSTEMS THAT BECOME EXPOSED AS A PART OF NEW WORK SHALL BE REMOVED AS REQUIRED TO A POINT WHERE THE ABANDONED PORTION IS TOTALLY

ALL SURFACES DAMAGED BY THIS CONTRACTOR IN THE COURSE OF PERFORMING WORK SHALL BE RESTORED TO SATISFACTORY CONDITION, AS DIRECTED BY THE ARCHITECT AND ALL COSTS OF REPAIRS SHALL BE PAID FOR BY THE CONTRACTOR

REMOVE SERVICE TO MECHANICAL, ELECTRICAL AND BUILDING EQUIPMENT SPECIFIED AND/OR INDICATED AS REMOVED OR DISCONNECTED. MAINTAIN CIRCUITS TO EXISTING—TO—REMAIN EQUIPMENT. IDENTIFY UNUSED, REMOVED CIRCUITS ON PANEL SCHEDULE AS SPARE. COORDINATE WITH ARCHITECTURAL, MECHANICAL AND ELECTRICAL DRAWINGS FOR EXISTING TO REMAIN EQUIPMENT AND FOR DEMOLITION WORK.

SERVICE SHUTDOWN AND POWER OUTAGES SHALL BE SCHEDULED WITH THE OWNER PRIOR TO PERFORMING ANY WORK ON EXISTING SERVICE. SCHEDULE SHALL BE PROVIDED IN WRITING 72 HOURS IN ADVANCE AND SHALL SHOW A DETAILED DESCRIPTION OF THE PROPOSED WORK AND THE DURATION OF OUTAGE.

PROVIDE LUMINAIRE DISCONNECTING MEANS PER LIGHTING SPECIFICATIONS.

<u>UTILITY SERVICES:</u>
ELECTRIC SERVICE TO THE SITE IS EXISTING AND SHALL BE UTILIZED AS INDICATED ON THE DRAWINGS.

ELECTRICAL EQUIPMENT AND DEVICES: MINI POWER ZONE (MLC) SHALL BE COMBINATION OF 15KVA 115 DEGREE C RISE ENCAPSULATED TRANSFORMER, 480V INPUT, 208/120V-3PH-4W OUTPUT, 40A-3P MAIN PRIMARY CIRCUIT BREAKER, 60A-3P MAIN SECONDARY BREAKER AND BRANCH BREAKERS AS INDICATED.

GE, EATON, SIEMENS, SQUARE D, OR APPROVED EQUAL. PROVIDE GROUNDING OF TRANSFORMERS AS SEPARATELY DERIVED SOURCES PER NEC ARTICLE 250.30. INCLUDE INSULATION CLASS IN SUBMITTAL

RECEPTACLES SHALL BE SPECIFICATION GRADE, GROUNDING TYPE, 2-POLE, 3-WIRE, AND POLARIZED. RECEPTACLES IN GENERAL SHALL BE 20A, 125 V., HUBBELL #HBL5362 OR EQUAL MOUNTED 16" AFF IN OFFICES AREAS AND 48" AFF IN SHOP AREAS EXCEPT AT COUNTERS WHERE THEY SHALL BE 6" ABOVE COUNTER AND IN TOILET ROOMS AT 48" AFF. RECEPTACLES ON SINGLE CIRCUIT SHALL BE 20 AMPERES, HUBBELL #HBL5362. HIGH AMPERE RATINGS AND VOLTAGES ARE INDICATED ON

RECEPTACLES DESIGNATED "GFR" SHALL BE GROUND FAULT RECEPTACLES, SIMILAR TO HUBBELL #GF-5362. FOR OUTDOOR OR WET LOCATIONS, PROVIDE WEATHERPROOF BOX AND GASKETED COVER PLATE. WIRE 'GFR' RECEPTACLES FOR SELF PROTECTION AND NOT DOWNSTREAM PROTECTION OF OTHER WIRING DEVICES.

SWITCHES SHALL BE SINGLE POLE, TWO POLE, OR THREE-WAY, AS INDICATED, TOGGLE TYPE, 20A, 120/277V., QUIET TYPE, HUBBELL #1221/1222/1223 OR APPROVED EQUAL. PILOT TYPE SWITCHES

DEVICE COVER PLATES SHALL BE OF TYPE AND NUMBER OF GANGS FOR DEVICES INSTALLED, SMOOTH EDGED 302/304 GRADE BRUSHED STAINLESS STEEL. PROVIDE BRANCH CIRCUIT IDENTIFICATION ON ALL COVERPLATÉS AS SPECIFIED UNDER "GENERAL REQUIREMENTS". COVERPLATES FOR DEVICES CONNECTED TO THE EMERGENCY SYSTEM SHALL ALSO BE FACTORY LABELED WITH BLACK LETTERING TO READ "FMFRGFNCY".

ALL CONDUCTORS SHALL BE SOFT-DRAWN COPPER OF SIZES INDICATED ON THE DRAWINGS. ALL CONDUCTORS SHALL BE INSULATED FOR 600 VOLTS AND WITH 90 DEGREES (CENTIGRADE) CODE

CONDUCTORS SIZED #10 AND SMALLER SHALL BE SOLID. ALL CONDUCTORS LARGER THAN #10 SHALL BE MADE UP OF STRANDED SINGLE CONDUCTOR CABLE. CONDUCTORS SHALL HAVE THWN OR THHN INSULATION AS APPLICABLE. CONDUCTORS IN UNDERGROUND CONDUIT AND FOR SERVICE ENTRANCE CONDUCTOR SHALL HAVE XHHW OR THWN INSULATION.

#12 AWG SHALL BE THE MINIMUM WIRE SIZE ALLOWED EXCEPT #14 AWG MAY BE USED FOR

TYPICAL BRANCH CIRCUITS FROM 20A, 1-POLE BRANCH OVERRCURRENT DEVICES ARE 1/2"C, 2#12 AND 1#12G.

MAIN DISTRIBUTION PANELS SHALL BE AS SHOWN ON DRAWINGS, BRACED FOR 35,000 A.I.C. MINIMUM, DEAD FRONT CONSTRUCTION. VOLTAGE, PHASE, AMPERE RATING, AND DEVICES SHALL BE AS

LIGHTING PANELS SHALL BE OF VOLTAGE, PHASE, SERVICE AND NUMBER OF WIRES INDICATED ON THE DRAWINGS. BREAKERS SHALL BE THERMAL MAGNETIC, TRIP FREE, SINGLE OR MULTIPOLE, BOLTED DESIGN. MOLDED CASE. MINIMUM 10,000 A.I.C. AT 240 VOLTS OR 14,000 A.I.C. AT 277 VOLTS. DEVICES SHALL BE AS INDICATED ON THE DRAWINGS OR AS SCHEDULED.

LIGHTING PANELS RATED FOR 277/480V, 3-PHASE, 4W SERVICE SHALL BE SQUARE D TYPE "NF" OR EQUAL, AND THOSE RATED FOR 120/208V, 3-PHASE, 4-WIRE SERVICE SHALL BE SQUARE D TYPE "NOOD" OR EQUAL. LOAD CENTERS ARE NOT PERMITTED.

CONTRACTOR, MANUFACTURER MAY RE-ARRANGE CIRCUIT ORDER IN PANELS, HOWEVER CIRCUIT NUMBERS FROM PANELBOARD SCHEDULES IN CONTRACT DOCUMENTS MUST BE INDICATED ON ANY SUBMITTED PANELBOARD ELEVATIONS, DRAWINGS, TABLES AND SCHEDULES.

INSTALLATION AND METHODS OF EXECUTION:

ALL WIRING SHALL BE IN CONDUIT, MINIMUM 1/2". FLEXIBLE METAL CONDUIT SHALL BE USED FOR SHORT CONNECTION TO MOTORS, FINAL CONNECTION TO RECESSED LIGHTING FIXTURES FROM RIGIDLY MOUNTED OUTLET BOX (NOT BETWEEN FIXTURES), VIBRATING EQUIPMENT, ETC., BUT NEVER LONGER THAN 6 FEET. PROVIDE LIQUID TIGHT FLEXIBLE METAL CONDUIT FOR ALL APPLICATIONS EXPOSED TO WATER OR WEATHER. PROVIDE ANTI-SHORT BUSHINGS FOR ALL FLEXIBLE CONDUIT ARMOR TERMINATIONS. PROVIDE SEPARATE EQUIPMENT GROUND WIRE IN ALL CONDUIT RUNS.

CONDUIT CONCEALED IN CEILING, WALLS OR FURRED SPACES OR EXPOSED IN DRY LOCATIONS SHALL BE EMT, THIN WALL ELECTRIC METALLIC TUBING. CONDUIT EXPOSED TO WEATHER, IN CONTACT WITH CONCRETE. BURIED IN SLAB. OR IN HAZARDOUS AREAS, SHALL BE HEAVY WALL, RIGID. ALL CONDUITS SHALL BE HOT DIPPED GALVANIZED STEEL.

ALL WORK IN HAZARDOUS LOCATIONS SHALL BE DONE IN STRICT CONFORMANCE WITH NEC ARTICLE

PLASTIC CONDUIT. PVC-40. SHALL BE USED ONLY AS INDICATED ON THE DRAWINGS. PLASTIC CONDUIT SHALL BE APPROVED FOR UNDERGROUND USE. PVC BURIAL DEPTH SHALL BE 36" MINIMUM BELOW FINISH GRADE. IN PVC CONDUIT SYSTEMS, RISERS ABOVEGROUND SHALL BE RIGID HEAVY

CONDUIT RUNS SHOWN ON DRAWINGS ARE DIAGRAMMATIC. EXACT ROUTING OF CONDUIT RUNS SHALL SUIT JOB CONDITIONS. EXPOSED CONDUIT SHALL BE RUN ONLY IN UNFINISHED AREAS SUBJECT TO FINAL APPROVAL OF ENGINEER AND SHALL RUN PARALLEL TO BUILDING LINES, NEVER DIAGONALLY.

CONNECTION TO EQUIPMENT SHALL BE DONE IN ACCORDANCE WITH MANUFACTURER'S SHOP AND INSTALLATION DRAWINGS. REQUIREMENTS GENERALLY VARY FROM ONE MANUFACTURER TO ANOTHER AND CONTRACTOR IS BOUND TO COMPLY AND PROVIDE ALL WORK AS REQUIRED ALTHOUGH CERTAIN DISCREPANCIES MAY EXIST REGARDING THE REQUIREMENT FROM ONE MANUFACTURER TO ANOTHER.

PROVIDE POWER WIRING, DISCONNECTS, AND PROTECTION DEVICES TO ALL MECHANICAL EQUIPMENT AND MAKE FINAL CONNECTIONS, INCLUDING TESTING OF MOTORS FOR PROPER ROTATION.

OUTLET BOXES MAY-BE SURFACE MOUNTED ON EXISTING WALLS (CMU, BRICK OR CONCRETE) WITH SMALLEST SURFACE RACEWAY AS REQUIRED FOR WIRING INSTALLED. PROVIDE FLUSH OUTLET BOXES AND CONDUIT AT NEW CONSTRUCTION WALL AND AT EXISTING WALLS WHICH ARE NOT CMU BRICK OR CONCRETE CONSTRUCTION. CUT AND PATCH EXISTING WALLS AS REQUIRED FOR FLUSH INSTALLATION.

ALL WIRING LOCATED ABOVE THE SUSPENDED CEILING MUST BE SUPPORTED INDEPENDENTLY OF THE SUPPORT WIRES FOR THE SUSPENDED CEILING.

OUTLET BOXES ON OPPOSITE SIDES OF FIRE RESISTANT WALLS OR PARTITIONS SHALL BE SEPARATED BY A HORIZONTAL DISTANCE OF TWENTY FOUR (24) INCHES.

PROVIDE PROPER WORKING CLEARANCES FOR ELECTRICAL EQUIPMENT AS REQUIRED PER NEC.

LIGHTING SPECIFICATIONS: LED LIGHTING FIXTURES SHALL HAVE 5 YEAR WARRANTY, A COLOR RENDERING INDEX OF 90 OR HIGHER, 3500K COLOR TEMPERATURE UNLESS OTHERWISE INDICATED ON DRAWINGS, LIFETIME: 50,000 HOURS OR GREATER AND MAINTAIN AT LEAST 70% OF INITIAL LUMEN OUTPUT. RATED FOR OUTDOOR USE AND WET LOCATION, IF IN OPEN FIXTURE.

SHALL POSSESS COLOR MANAGEMENT SYSTEM TO MAINTAIN COLOR CONSISTENCY OVER TIME AND TEMPERATURE OF NO GREATER THAN ±100K OVER LIFE.

REFER TO LIGHTING FIXTURE SCHEDULE ON ARCHITECTURAL REFLECTED CEILING PLANS FOR LED FIXTURES WITH DIMMING CONTROLS.

LED DRIVERS TO BE ELECTRONIC, HIGH POWER FACTOR, MIN. 0.9; UNIVERSAL VOLTAGE 120-277V; 5 YEAR WARRANTY, COMPATIBLE WITH THE LED LAMP OR MODULE USED.

FIFCTRICAL IFGEND *

"A"	FIXTURE TYPE		FIRE RATED FLUSH FLOOR POKE	THRU WIT	TH DUPLEX OR QUAD RECEPT.
	1x4 LIGHT FIXTURE		& LOW VOLTAGE COMPARTMENTS	S SIMILAR	TO LEGRAND RC4.
	POLE MOUNTED LIGHTING FIXTURE STRIP LIGHTING FIXTURE		FIRE RATED RECESSED DEEP FLOOR POKE THRU WITH DUPLEX OR QUAD RECEPTACLE & LOW VOLTAGE COMPARTMENTS SIMILAR TO LEGRAND EVOLUTION 6 SERIES.		
	2'X2' OR 2'X4' LIGHTING FIXTURE	HP~3	JUNCTION BOX FOR FLEXIBLE CON FURNITURE WHIP PROVIDED BY FU	INECTION TO RNITURE SU	D SYSTEMS (P: POWER, D: DATA JPPLIER. FOR NEW WORK PROVI
	FULL SHADED LIGHTING FIXTURES ARE WIRED UNSWITCHED NIGHT LIGHTS	HD~s HJ-es	1"C OR 1 1/4"C FOR DATA TO A NOTED. COORDINATE LOCATION WI	ABOVE ACCE TH FURNITU	SSIBLE CEILING. UNLESS OTHER RE SYSTEM SUPPLIER.
	HALF SHADED FIXTURES ARE FIXTURES PROVIDED WITH BUILT-IN		PROVIDE FINAL CONNECTION AND	COVERPLATI	E SUITABLE FOR WHIP CONNEC
	EMERGENCY BATTERY PACK FOR EGRESS LIGHTING RECESSED DOWN LIGHT		DISTRIBUTION PANEL SURFACE MOUNTED LIGHTING AN	ID/OR REC	FPTACIF PANFI
	WALL MOUNTED LIGHTING FIXTURE		RECESSED MOUNTED LIGHTING A		
	TRACK LIGHTING FIXTURE	СВ	MOLDED CASE CIRCUIT BREAKER	- SURFA	CE MOUNTED IN NEMA ENCLO
\bigotimes	EXIT LIGHTING FIXTURE — SHADING INDICATES ILLUMINATED FACE (S) CHEVRONS AS INDICATED	СВ	MOLDED CASE CIRCUIT BREAKER	- FLUSH	MOUNTED IN NEMA ENCLOSU
	EMERGENCY LIGHTING UNIT		MOTOR - SINGLE PHASE		
	COMBINATION OF EXIST AND EMERGENCY LIGHTING UNIT	(6)	MOTOR - THREE PHASE		
S	SINGLE POLE LIGHT SWITCH		MANUAL SINGLE PHASE MOTOR S FOR MOTOR APPLICATIONS. MANU	STARTER WI' JAL SINGLE	TH PILOT LIGHT, LOCKABLE OF PHASE MOTOR SWITCH WITH
S ₃	THREE WAY LIGHT SWITCH		LIGHT, LOCKABLE OFF AND WITH APPLICATIONS TO EQUIPMENT NO	OUT OVERL	OADS FOR DISCONNECT IG OVERLOADS AND FOR
S4 Sk	FOUR WAY LIGHT SWITCH KEY OPERATED SWITCH		APPLICATIONS WHERE OVERLOADS FLUSH MOUNT STARTERS / SWIT IN UNFINISHED SPACES.		
Sp	LIGHT SWITCH WITH PILOT LIGHT		NON-FUSIBLE DISCONNECT SWIT		
Sp3	THREE WAY LIGHT SWITCH WITH PILOT LIGHT		FUSIBLE DISCONNECT SWITCH		
So	DIMMER SWITCH, COMPATIBLE WITH LIGHTS CONTROLLED		THREE PHASE COMBINATION MAG		SIBLE MOTOR STARTER
SMD Sd3	DIMMER SWITCH WITH WALL OCCUPANCY SENSOR (SINGLE POLE) THREE WAY LIGHT SWITCH WITH DIMMER		BUS PLUG FUSIBLE DISCONNECT TRANSFORMER	SWITCH	
St St	TIMER SWITCH	С	CONTACTOR		
Siv	LOW VOLTAGE CONTROL STATION WITH DIMMING CAPABILITIES, NUMBER OF	<u> </u>	METER		
	BUTTONS AS INDICATED TO PROVIDE PRESET SCENES, RISER, LOWER, ON, OFF CONTROL FOR ZONES INDICATED, COORDINATE WITH LIGHT DIMMING CONTRACTOR FOR DEVICE MODEL NUMBERS, QUANTITIES, LOCATIONS, AND		GROUND TO LIQUITING BANEL		
	ADDITIONAL REQUIREMENTS.	— → — ct —	HOMERUN TO LIGHTING PANEL CABLE TRAY		
RPD	RELAY PACK WITH 0-10V DIMMING OUTPUT	— PS —□	PLUG-IN STRIP		
`	CEILING MOUNTED OCCUPANCY SENSOR. DUAL TECHNOLOGY (PASSIVE	EF	EXHAUST FAN	EWC	ELECTRIC WATER COOLER
- (0 S)-	INFRARED AND MICROPHONIC/ULTRASONIC), WITH AUXILIARY RELAY FOR HVAC	EDH	ELECT. DUCT HTR.	AFF	ABOVE FINISHED FLOOR
	CONTROL. PROVIDE QUANTITY OF 20A, 120V/277V RATED POWER PACKS AND RELAY PACKS AS REQUIRED TO CONTROL SWITCH LEGS INDICATED. ALL FIXTURES IN ROOM/SPACE ARE TO BE CONTROLLED BY THE SENSORS.	A /5	ABOVE COUNTER	WP	WEATHERPROOF
Sw	WALL MOUNTED VACANCY SENSOR, SINGLE POLE. DUAL TECHNOLOGY	A/E CM	ARCHITECT / ENGINEER COFFEE MAKER	RT UFD	RAINTIGHT UNDER FLOOR DUCT
	(PASSIVE INFRARED AND MICROPHONICS/ULTRASONIC), 120/277V. SWITCH IS RATED 800W AT 120V AND 1200W AT 277V, 1/4 HP. IVORY WITH STAINLESS STEEL COVERPLATE. FACTORY COLOR-MATCHED PLATE IS NOT	MW	MICROWAVE	FPB	FAN POWER BOX
	STAINLESS STEEL COVERPLATE. FACTORY COLOR—MATCHED PLATE IS NOT ACCEPTABLE.	НОА	HAND-OFF-AUTOMATIC	DW	DISHWASHER
S _{M2}	SAME AS SM EXCEPT WITH DUAL POLE	PC	PHOTOCELL	GD	GARBAGE DISPOSAL
φ	SINGLE RECEPTACLE	HG UH	HOSPITAL GRADE UNIT HEATER	REF	REFRIGERATOR EXISTING TO REMAIN
Ψ	DUPLEX RECEPTACLE	UON	UNLESS OTHERWISE NOTED	(E)	RELOCATED EXISTING
<u>₩</u> ₩	QUADRUPLEX RECEPTACLE DUPLEX RECEPTACLE WITH GROUND FAULT (GFCI)	EG	EQUIPMENT GROUND	IG	ISOLATED GROUND
GFP	FACELESS GROUND FAULT CIRCUIT INTERRUPTER	Н	HORIZONTALLY MOUNT 6" ABOVI		BACK SPLASH
$\Phi_{\mathbf{c}}$	SAME AS DUPLEX RECEPTACLE EXCEPT CEILING MOUNTED	GFI or GFR	GROUND FAULT CIRCUIT INTERRU POWER POLE VOICE/DATA/POWE		
Φ_{s}	SAME AS DUPLEX RECEPTACLE EXCEPT SHOW WINDOW TO BE MOUNTED 6" ABOVE WINDOW, COORDINATE WITH OWNER/		AUDIO/VISUAL HEAD END EQUIP		
	ARCHITECT PRIOR TO INSTALLATION COMBINATION DUPLEX POWER RECEPTACLE AND TWO USB PORTS	DR	DRIVER FOR 24V UNDER CABINE	T LED LIG	нт
	SAME AS DUPLEX RECEPTACLE EXCEPT HORIZONTALLY MOUNTED	CR	CARD READER		
Ф	SPLIT RECEPTACLES	(C)	PHOTOELECTRIC CONTROLLER		
Φ	FLOOR RECEPTACLE	WPS	COMBINE PARTITION SENSOR		
R	COMMERCIAL GRADE CORD REEL WITH GFCI MOUNTED TO STEEL STRUCTURE	WAP	WIRELESS ACCESS PANEL		
→ R	SPECIAL PURPOSE RECEPTACLE - NEMA TYPE	PP	POWER POLE VOICE/DATA/POWE		
⊘ R	SPECIAL PURPOSE RECEPTACLE - NEMA TYPE ON A CORD REEL MOUNTED TO STEEL STRUCTURE	CP TS	CONTROL PANEL, PROVIDE AS P	ART OF TH	IE EQUIPMENT THEY CONTROI
•	DUPLEX RECEPTACLE FLOOR MOUNTED	B B	BELL		
<u> </u>	CEILING JUNCTION BOX	RB	RADIO ALERT SYSTEM BELL		
<u> </u>	WALL JUNCTION	DS	DOOR SWITCH		
	PUSH BUTTON STATION (1, 2, OR 3 BUTTON)	IC	INTERCOM STATION	laav.	
● рр	DOOR ACTIVATOR PUSH PLATE	FACP	FIRE ALARM CONTROL PANEL	NOTIU	
<u> </u>	COMBINATION DATA AND TELEPHONE OUTLET UNLESS OTHERWISE	FAA	FIRE ALARM CONTROL PANEL FIRE ALARM ANNUNCIATOR PANE	:L	
—	PHONE OUTLET SAME AS NOTED PROVIDE DOUBLE GANG BOX	NACP	NOTIFICATION APPLIANCE CONTR		
<u> </u>	MOUNTED AT +48") WITH SINGLE MUD RING AND 3/4"C UP	MC	MICROPHONE		
$\overline{}$	DATA OUTLET TO CEILING SPACE TELEVISION OUTLET, DOUBLE GANG BOX WITH SINGLE MUD RING	(s) (v) (v)	VOLUME CONTROL DIAL		
TV	AND 1"C TO CEILING SPACE		SMOKE DETECTOR		
[M]	AUDIO/VIDEO OUTLET, DOUBLE GANG BACK BOX WITH 1 1/4"C	HD	HEAT DETECTOR		
AV	TO ABOVE ACCESSIBLE CEILING, TERMINATE CONDUIT WITH INSULATING BUSHING, PROVIDE PULL STRING	(ST	TAMPER SWITCH		
$\bigcirc $	FLOOR MOUNTED THREE GANG (3G) FLUSH BOX, DUPLEX RECEPTACLE, A/V & DATA/PHONE COMPARTMENTS	(FS) (A/V)	FLOW SWITCH OUTDOOR FIRE DEPARTMENT CO	NNECTION	- Alinio Visital Device
	DUPLEX RECEPTACLE & DATA/PHONE FLUSH FLOOR MOUNTED	DH	MAGNETIC DOOR HOLDER	MINECITON	AUDIO VISUAL DEVICE
$\boxed{\Phi} \boxed{\nabla}$	TWO GANG (2G) COMPLETE WITH FLANGE AND COVER	(DS)	DUCT SMOKE DETECTOR		
c M	CEILING MOUNTED TWO GANG (2G) FLUSH BOX, DUPLEX RECEPTACLE & DATA/PHONE COMPARTMENTS	<u></u>	COMBINATION SMOKE/CO DETECTOR		
$\boxed{\Phi} \boxed{\nabla}$, ,	F	MANUAL FIRE ALARM STATION		
⊞ _{F1}	MULTI-SERVICE STAMPED STEEL FLUSH FLOOR BOX - TYPE F1 - WITH (2)-20A DUPLEX RECEPTACLES & (2) DATA COMPARTMENT, WIREMOLD #RFB4 SERIES OR APPROVED EQUAL BY HUBBELL	FO	FIRE ALARM STROBE FIRE ALARM HORN/STROBE		
	MULTI-SERVICE STAMPED STEEL FLUSH FLOOR POKE-THROUGH BOX	-(F)-	FIRE ALARM HORN/STROBE - C	EILING MOL	JNTED
1 1 1	- TYPE F2 - WITH (2)-20A DUPLEX RECEPTACLES & (2) DATA COMPARTMENT, WIREMOLD OR APPROVED EQUAL BY HUBBELL.	I	FIRE ALARM STROBE - CEILING		
F2	COMPARIMENI, WIREMOLD OR APPROVED EQUAL BY HUBBELL.	-(F)- <u>-</u>	FIRE ALARM STRUBE - CEILING	MOUNTED	
☐F2	FLOOR MOUNTED TWO GANG (2G) FLUSH BOX WITH SEPARATE POWER AND DATA COMPARTMENTS FOR FURNITURE CONNECTION	+ THIS IS STA	ANDARD SYMBOL LIST - S		THESE SYMBOL MAY

	1 1		
CLE			ELECTRICAL SHEET INDEX
)		SHEET	DESCRIPTION
). DE WISE ON.		E001	ELECTRICAL LEGEND, SHEET INDEX, SPECIFICATION AND DETAILS
		ED100	DEMOLITION PLANS
		E100	ELECTRICAL PLANS

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Project

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5101 John C Lodge Fwy, Detroit, MI 48202

Key Plan:

07.07.22

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Sheet Title: ELECTRICAL LEGEND, SHEET

Project No.:

INDEX AND SPECIFICATION

2022.038

Sheet No.:

DEMOLITION POWER PLAN



KEY NOTES:

REMOVE ALL RECEPTACLES SHOWN HATCHED AND ASSOCIATED WIRE AND CONDUIT BACK TO SOURCE, UNLESS OTHERWISE NOTED.

RELOCATE LIGHT FIXTURES TO LOCATIONS SHOWN ON SHEET E100. REMOVE ASSOCIATED SWITCHES AND PREPARE CIRCUIT FOR EXTENSION TO NEW LIGHT FIXTURE LOCATION.




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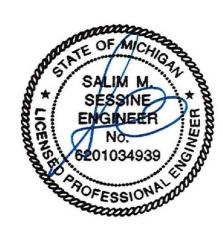
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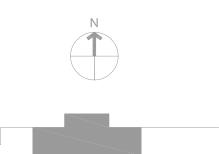


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KEY NOTES :

- PROVIDE SEPARATE 20A-120V-1P CIRCUIT FROM NEAREST AVAILABLE PANEL. VERIFY PANEL
- 2 CONNECT TO BUILDING FIRE ALARM SYSTEM PER BUILDING FIRE ALARM SYSTEM VENDOR'S DIRECTION.
- FIRE CURTAIN, PROVIDE SEPARATE (1)20A-120V-1P LIFE SAFETY CIRCUIT FROM NEAREST AVAILABLE SOURCE. VERIFY SOURCE LOCATION IN FIELD.
- 4 CONNECT TO EXISTING LIGHTING CIRCUIT.
- 5 REWORK SWITCHING AS INDICATED.
- PROVIDE EXIT LIGHT FIXTURE TO MATCH EXISTING-VERIFY INFIELD. CONNECT TO NEAREST AVAILABLE LIFE SAFETY LIGHTING CIRCUIT.
- RECESSED 6" DIAMETER LED DOWNLIGHT WITH LENS, 2000 LUMENS, 3500°K, 80CRI, 0-10V DIMMING, MULTI-VOLT DRIVER.
 GOTHAM EVO-6 OR APPROVED EQUAL.



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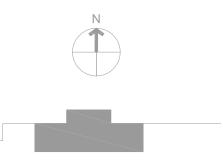

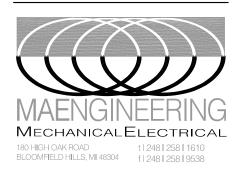
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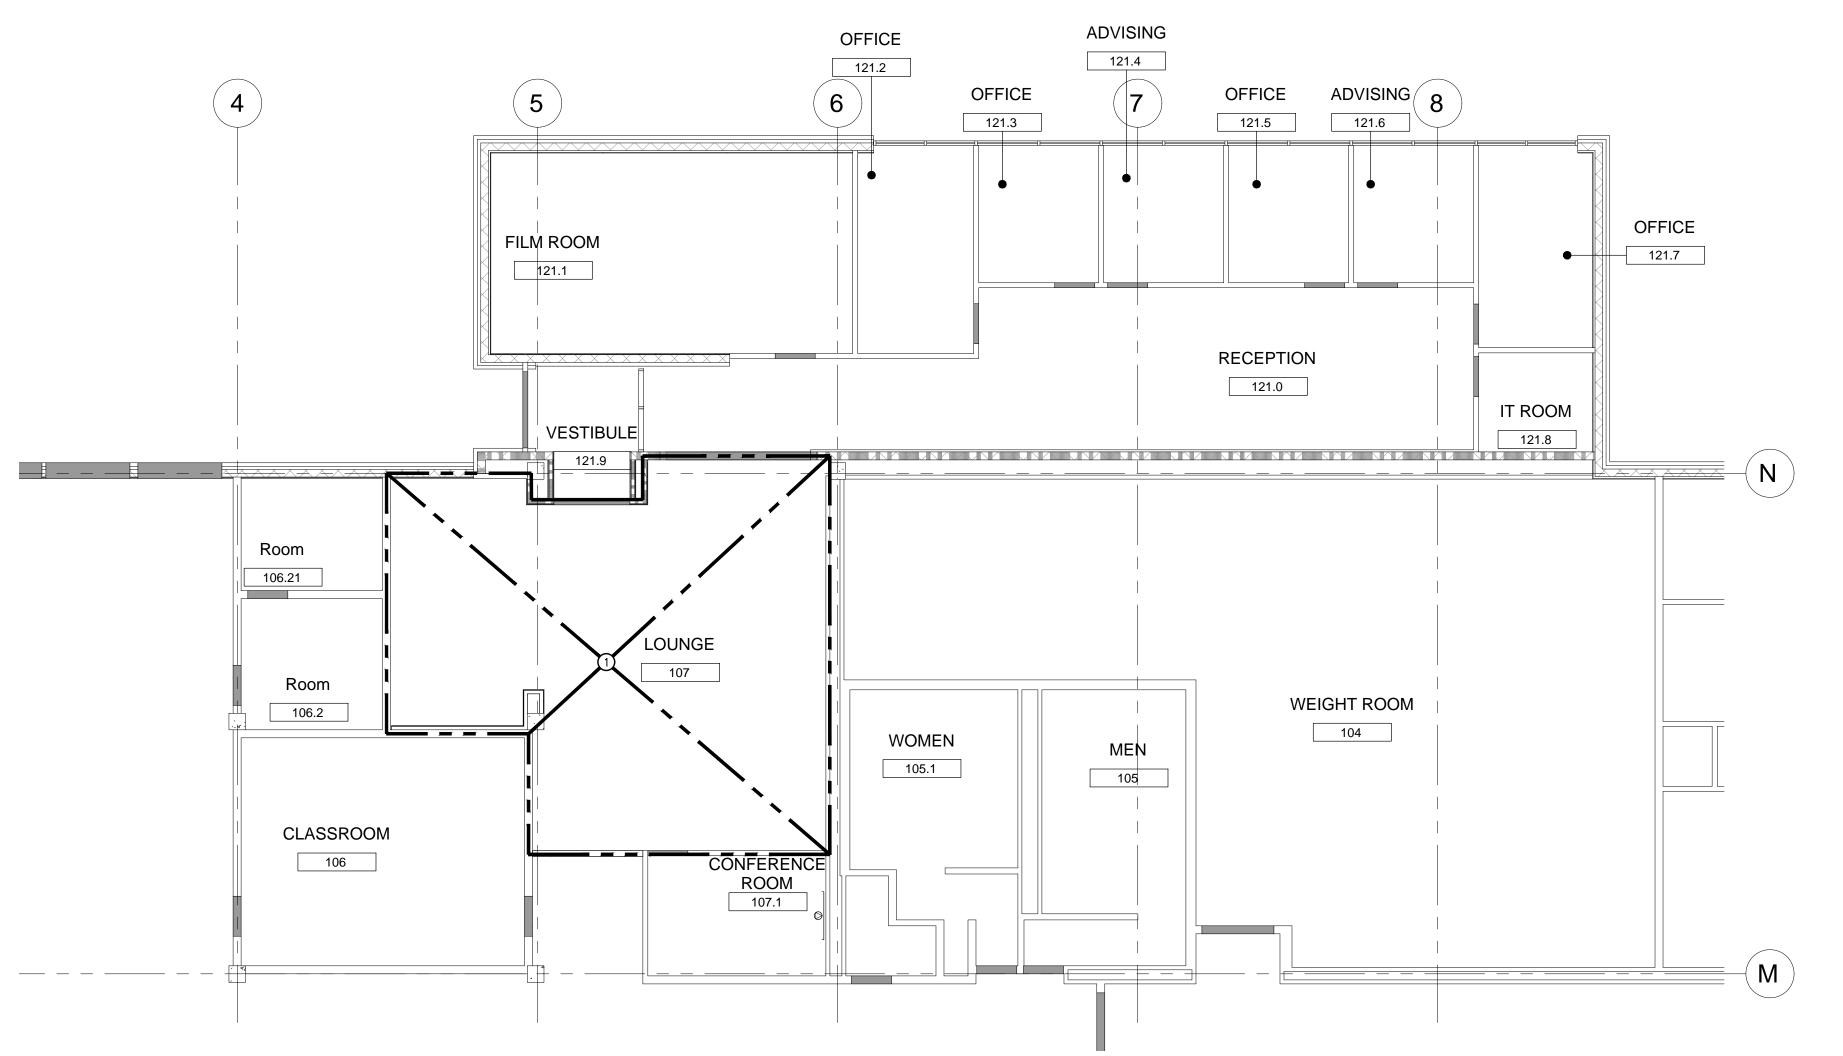
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E100





for the area indicated, rework the existing sprinkler system to accommodate the new layout of the space. Provide new heads and piping as required. Hydraulically DESIGN THE SYSTEM IN ACCORDANCE WITH NFPA-13, THE MICHIGAN BUILDING CODE, THE OWNER'S INSURANCE COMPANY AND THE AUTHORITY HAVING JURISDICTION. THE CONTRACTOR SHALL MAINTAIN AN OPERATIONAL SPRINKLER SYSTEM FOR ALL AREAS DURING CONSTRUCTION.

GENERAL FIRE PROTECTION NOTES:

- A. AREA UNDER RENOVATION IS TO BE FULLY SPRINKLERED. SPRINKLER SYSTEM DESIGN AND LAYOUT TO BE IN COMPLIANCE WITH NFPA 13.
 REFER TO SPECIFICATION FOR ADDITIONAL INFORMATION.
- B. REMOVE ALL AUTOMATIC SPRINKLER HEADS PRESENTLY INSTALLED IN THE AREA OF RENOVATION AND TURN OVER TO THE OWNER. FIELD VERIFY LOCATION OF EXISTING HEADS AND SPRINKLER PIPING LOCATION PRIOR TO DESIGN & INSTALLATION. CONNECT NEW SPRINKLER HEADS TO EXISTING MAINS IF FEASIBLE.
- C. ALL SPRINKLERS LOCATED IN LAY-IN CEILINGS SHALL BE CENTERED IN THE MIDDLE OF THE CEILING TILES UNLESS OTHERWISE INDICATED



- ON THE ARCHITECTURAL SERIES DRAWINGS.



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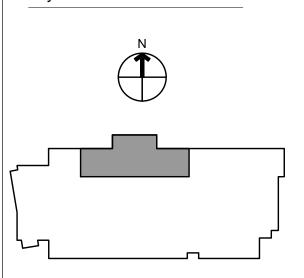


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FIRST LEVEL NEW WORK FIRE PROTECTION PLAN

Project No. :

2022.038

Sheet No.: F100

1 FIRST LEVEL NEW WORK FIRE PROTECTION F100 1/8" = 1'-0"