WSU- DETROIT- UGL-W360 ACADEMIC ENGAGEMENT HUB

5155 GULLEN MALL DETROIT, MI 48202

ARCHITECT

STUCKY VITALE ARCHITECTS 27172 WOODWARD AVENUE ROYAL OAK, MICHIGAN 48067 (248) 546-6700

MECH/PLUMB/ELEC ENGINEER

MA ENGINEERING 180 HIGH OAK RD

BLOOMFIELD HILLS, MI 48304 (248) 258-1610

WSU PROJECT NUMBER:

RENOVATION OF PORTION OF EXISTING LBRARY TO INCLUDE: NEW OFFICE BLOCKS, FURNITURE, FINISHES.

2015 MICHIGAN REHABILITATION CODE FOR EXISTING BUILDINGS (MRC)

- 2018 MICHIGAN PLUMBING CODE (MPC)
- 2013 ANSI/ASHRAE/IES 90.1 2017 NATIONAL ELECTRICAL CODE (NEC)

MBC-2015. CHAPTER 11

ICC / ANSI 117.1 - 2009, EXCEPT SECTION 611 & 707

CHAPTER 3 - USE AND OCCUPANCY CLASSIFICATION

UNIVERSITY

CHAPTER 9 - FIRE PROTECTION SYSTEMS AUTOMATIC SPRINKLER SYSTEMS: <EXISTING TO REMAIN>

DISCIPLINE DESIGNATOR

- G GENERAL LS LIFE SAFETY
- AD ARCHITECTURAL DEMOLITION
- A ARCHITECTURAL F FINISH INFORMATION AE EQUIPMENT INFORMATION
- P PLUMBING
- M MECHANICAL E ELECTRICAL

PROJECT INFORMATION

APPLICABLE CODES

- 2015 MICHIGAN MECHANICAL CODE (MMC)
- 2015 MICHIGAN ENERGY CODE (MEC)
- 2015 NFPA 101 LIFE SAFETY CODE

BARRIER FREE REQUIREMENTS:

2010 ADA STANDARDS FOR ACCESSIBLE DESIGN (DOJ)

FIRE ALARM AND DETECTION SYSTEMS: <EXISTING TO REMAIN>

SHEET DESIGNATION

DRAWINGS ARE NUMBERED ACCORDING TO THE FOLLOWING CONVENTIONS:

DRAWING SEQUENCE NUMBER

INTERIOR ELEVATIONS

7 INTERIOR AND MILLWORK DETAILS

DRAWING TYPE DESIGNATOR GENERAL, LEGENDS, SCHEDULES REFLECTED CEILING PLANS

NOTE: THESE CONSTRUCTION DRAWINGS WERE PREPARED FOR COMPLIANCE WITH THE MICHIGAN CONSTRUCTION CODES IN EFFECT AT THE TIME OF PERMIT SUBMITTAL. ALL ENGINEERS, CONTRACTORS AND SUPPLIERS INVOLVED WITH THIS PROJECT SHALL COMPLY WITH THE SAME CODES, ISSUED AND APPROVED CODE MODIFICATIONS AND/OR CITY CODE AUTHORITY CONSTRUCTION BOARDS OF APPEALS RULINGS AND WHENEVER REQUIRED SHALL PROVIDE SHOP DRAWINGS AND SUBMITTALS CLEARLY DESCRIBING COMPLIANCE TO THE REGISTERED DESIGN PROFESSIONAL IN RESPONSIBLE CHARGE FOR REVIEW AND

SHEET INDEX - GENERAL

SHEET INDEX - LIFE SAFETY

SHEET INDEX - ARCHITECTURAL DEMOLITION

SHEET INDEX - ARCHITECTURAL

SHEET INDEX - FINISH

SHEET INDEX - ARCHITECTURAL EQUIPMENT

SHEET INDEX - MECHANICAL

SHEET INDEX - ELECTRICAL

STANDARD MOUNTING HEIGHTS, MATERIAL LEGEND, PARTITION ADDENDUM #1

CODE INFORMATION AND FLOOR LIFE SAFETY PLAN - EGRESS ADDENDUM #1

COVER SHEET, GENERAL INFORMATION, DRAWING INDEX

ARCHITECTURAL DEMOLITION REFLECTED CEILING PLAN

AND DOOR SCHEDULES AND DETAILS

ARCHITECTURAL DEMOLITION PLANS

FIRST LEVEL CONSTRUCTION PLAN

ENLARGED RECEPTION AREA PLAN

INTERIOR AND MILLWORK DETAILS

INTERIOR AND MILLWORK DETAILS

FINISH SCHEDULE AND LEGEND

FIRST LEVEL EQUIPMENT PLAN

FIRST LEVEL FURNITURE PLAN

FIRE PROTECTION PLAN- LEVEL 1

MECHANICAL SPECIFICATIONS

ELECTRICAL SPECIFICATION

LIGHTING PLAN - LEVEL 1

ED110 DEMOLITION LIGHTING PLAN - LEVEL 1

ED210 DEMOLITION POWER PLAN - LEVEL 1

POWER PLAN - LEVEL 1

ELECTRICAL PANEL SCHEDULES-1

HVAC PLAN- LEVEL 1

MD110 DEMOLITION HVAC PLAN- LEVEL 1

MECHANICAL SYMBOLS LIST INDEX AND NOTES

ELECTRICAL LEGEND, SHEET INDEX AND DETAILS

MECHANICAL SCHEDULES AND DETAILS

FIRST LEVEL FINISH PLAN

DRAWING NAME

FIRST LEVEL REFLECTED CEILING PLAN

DRAWINGS: 2

DRAWINGS: 1

DRAWINGS: 2

DRAWINGS: 7

DRAWINGS: 2

DRAWINGS: 6

DRAWINGS: 7

E003

E110

DWG# DRAWING NAME

F110

DWG# DRAWING NAME

AD200

DRAWING NAME

DRAWING NAME

DRAWING NAME

INTERIOR ELEVATIONS

INTERIOR ELEVATIONS

PROJECT ALTERNATE PRICING:

CONTRACTOR TO PRICE OUT REPLACING CARPET IN ALL NEW OFFICES TO MATCH CPT-1.

CONTRACTOR TO PRICE OUT CONFERENCE ROOM BUILD OUT. INCLUDES NEW WALLS, DOORS,

FURNITURE, AND FINISHES. <u>ALT #3:</u> — — — — —

LED FIXTURES TO MATCH NEW FIXTURES IN OFFICES.

CONTRACTOR TO PROVIDE PRICING ON REPLACING ALL 2X4 CEILING LIGHTS IN OPEN STUDY AREA WITH

CONTRACTOR TO PRICE OUT PROVIDING FINAL DESIGN, PRINT, AND INSTALL VINYL GRAPHIC ON THE RECEPTION GLASS WALL.

CONTRACTOR TO PROVIDE PRICING ON PAINTING EXISTING WALLS OF OPEN STUDY AREA.

ALT #6: — — — — — — CONTRACTOR TO PROVIDE PRICING TO REPLACE GYP. WALL AND PUNCHED WINDOW WITH ALL GLASS WALL FLOOR TO CEILING

SYMBOL LEGEND

DATE

DATE

DATE

09.28.23

09.28.23

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ADDENDUM #1

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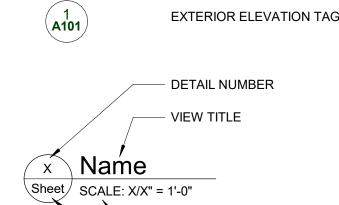
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INTERIOR ELEVATION TAG




ROOM NAME ROOM NAME 101

ROOM TAG


VIEW SCALE

SHEET NUMBER



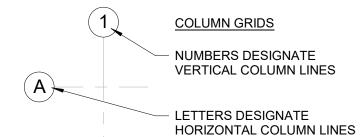




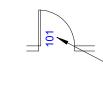

DOOR TAGS



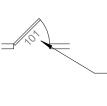

- EXISTING DOOR TAG **DESIGNATION (ONLY IF** EXISTING DOOR TO BE MODIFIED)




PARTITION TAG

KEYNOTE TAG



EQUIPMENT TAG

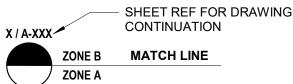

ABBREVIATION LEGEND

& L @	AND ANGLE AT	Ø DIA	NTERLINE METER JS OR MIN
•		1 120	50 OK WIIIV
ACCESS. ACOUS.	ACCESSIBILITY ACOUSTICAL	N NIC	NORTH NOT IN CONTRACT
ACCUS. ACT	ACOUSTICAL CEILING TILE	NOM.	NOMINAL
A.D.	AREA DRAIN	NTS	NOT TO SCALE
ADJ	ADJUSTABLE	O/C	ON CENTER
A.F.F. AL	ABOVE FINISH FLOOR ALUMINUM	OFC OPNG	OFFICE OPENING
ANOD.	ANODIZED	OPP	OPPOSITE
ARCH.	ARCHITECTURAL or ARCHITECT	OVFD	OVERFLOW DRAIN
ASPH. BD.	ASPHALT BOARD	PL PLAM	PLATE PLASTIC LAMINATE
BF	BARRIER FREE	PLAN	PLASTIC LAMINATE PLASTER
BLDG.	BUILDING	PNT	PAINT
BLK'G.	BLOCKING	PLYWD PREFAB	PLYWOOD
BOT. BR	BOTTOM BRICK	PFN	PREFABRICATED PREFINISH or PREFINISHED
CAB.	CABINET	PROJ	PROJECTION
CEM.	CEMENT	PT	POINT
C.J. CLG	CONTROL JOINT CEILING	R. RCP	RISER REFLECTED CEILING PLAN
C.F.M.F.	COLD FORMED METAL FRAMING	R.C.	ROOF CONDUCTOR
C.O.	CLEAN OUT	RD	ROOF DRAIN
CLO.	CLOSET	REINF	REINFORCING
CLR. COL.	CLEAR COLUMN	REQ'D RESIL	REQUIRED RESILIENT
CONC.	CONCRETE	RFG	ROOFING
C.G.	CORNER GUARD	RM	ROOM
CONST.	CONSTRUCTION	R.S.	ROOF SUMP
CONT. COR.	CONTINUOUS CORRIDOR	SAN SC	SANITARY SOLID CORE
COR. CORR.	CORRUGATED	SCHED	SCHEDULE
CPT	CARPET	SHT	SHEET
C.T.	CERAMIC TILE	SIM	SIMILAR
CTSK. CW	COUNTER SUNK CURTAIN WALL	SPEC SQ	SPECIFICATIONS SQUARE
D.F.	DRINKING FOUNTAIN	SU ST.STL.	STAINLESS STEEL
DET.	DETAIL	SS	SOLID SURFACE
DIA.	DIAMETER	ST	STONE
DIM. DN.	DIMENSION DOWN	STD STL	STANDARD STEEL
D.O.	DOOR OPENING	STN	STAIN
DR.	DOOR	STOR	STORAGE
D.S.	DOWN SPOUT	STRUCT	STRUCTURAL or STRUCTU
DWG. DWR.	DRAWING DRAWER	SUSP SYM	SUSPENDED SYMMETRICAL
EA	EACH	T.	TREAD
E.J.	EXPANSION JOINT	T&B	TOP AND BOTTOM
ELEC	ELEVATION	TERR.	TERRAZZO
ELEC. ELEV.	ELECTRICAL ELEVATOR	T.O.C. T&G	TOP OF CURB TONGUE AND GROOVE
E.O.S./EOS		THK	THICK
E.O.D./EOD		THRES.	THRESHOLD
EP EDV	ELECTRICAL PANEL	T.O.P.	TOP OF PARAPET
EPX EQ.	EPOXY EQUAL	TA TV	TOILET ACCESSORY TELEVISION
EQPM	EQUIPMENT	T.O.W.	TOP OF WALL
E.W.	EACH WAY	TOS / T.O.S.	TOP OF STEEL
EXIST. / EX		TYP.	TYPICAL
EXP. EXT.	EXPOSED EXTERIOR	U/C U.N.O.	UNDERCUT UNLESS NOTED OTHERWISE
FA	FIRE ALARM	U.SK.	UTILITY SINK
FD	FLOOR DRAIN	V.B.	VAPOR BARRIER
FON	FOUNDATION	VCT	VINYL COMPOSITION TILE
FE FEC	FIRE EXTINGUISHER FIRE EXTINGUISHER CABINET	VERT. VEST	VERTICAL VESTIBULE
FHC	FIRE HOSE CABINET	VEST	VINYL FLOORING
FIN	FINISH	V.I.F.	VERIFY IN FIELD
FL	FLOOR	W	WIDTH
F.O. F.O.S.	FACE OF FACE OF STUD	W/ WB	WITH WALL BASE
F.O.S. FPRF	FIREPROOF	W.C.	WATER CLOSET
FR	FRAME	WC	WALLCOVERING
FRP	FIBERGLASS REINFORCED PANEL	WD W/O	WOOD
FRT F.S.	FIRE RETARDANT TREATED FULL SIZE	W/O WR	WITHOUT WATER RESISTANT
FT.	FOOT or FEET	WSCT.	WAINSCOT
FTG.	FOOTING	WT.	WEIGHT
FUR	FURRING	W.W.F.	WELDED WIRE FABRIC
GA. GALV.	GAUGE GALVANIZED		
GALV. G.B.	GRAB BAR		
GFRC.	GLASS FIBER REINFORCED CONCRETE		
GL.	GLASS		
GYP. H.B.	GYPSUM HOSE BIBB		
H.C.	HOLLOW CORE		
HDWD	HARDWOOD		
HDWE	HARDWARE		
HM HORIZ.	HOLLOW METAL HORIZONTAL		
HR	HOUR		
HGT	HEIGHT		
INSUL	INSULATION		
IMP IMWP	INSULATED METAL PANEL INSULATED METAL WALL PANEL		
INT	INTERIOR		
J.C.	JANITOR'S CLOSET		
JT.	JOINT		
KIT.	KITCHEN LAVATORY		
LAV LG	LAVATORY LENGTH		
L.L.V.	LONG LEG VERTICAL		
LT	LIGHT		
LVT	LUXURY VINYL TILE		
MAX MECH	MAXIMUM MECHANICAL		
MTL	METAL		
MFR.	MANUFACTURER		
MIN.	MINIMUM		
MISC.	MISCELLANEOUS		

MASONRY OPENING



STUCKY VITALE ARCHITECTS 27172 WOODWARD AVENUE ROYAL OAK, MI 48067-0925 P. 248.546.6700

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UGL-W360 ACADEMIC ENGAGEMENT HUB

5155 GULLEN MALL

DETROIT, MI 48202

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09.15.23

09.19.23

09.28.23

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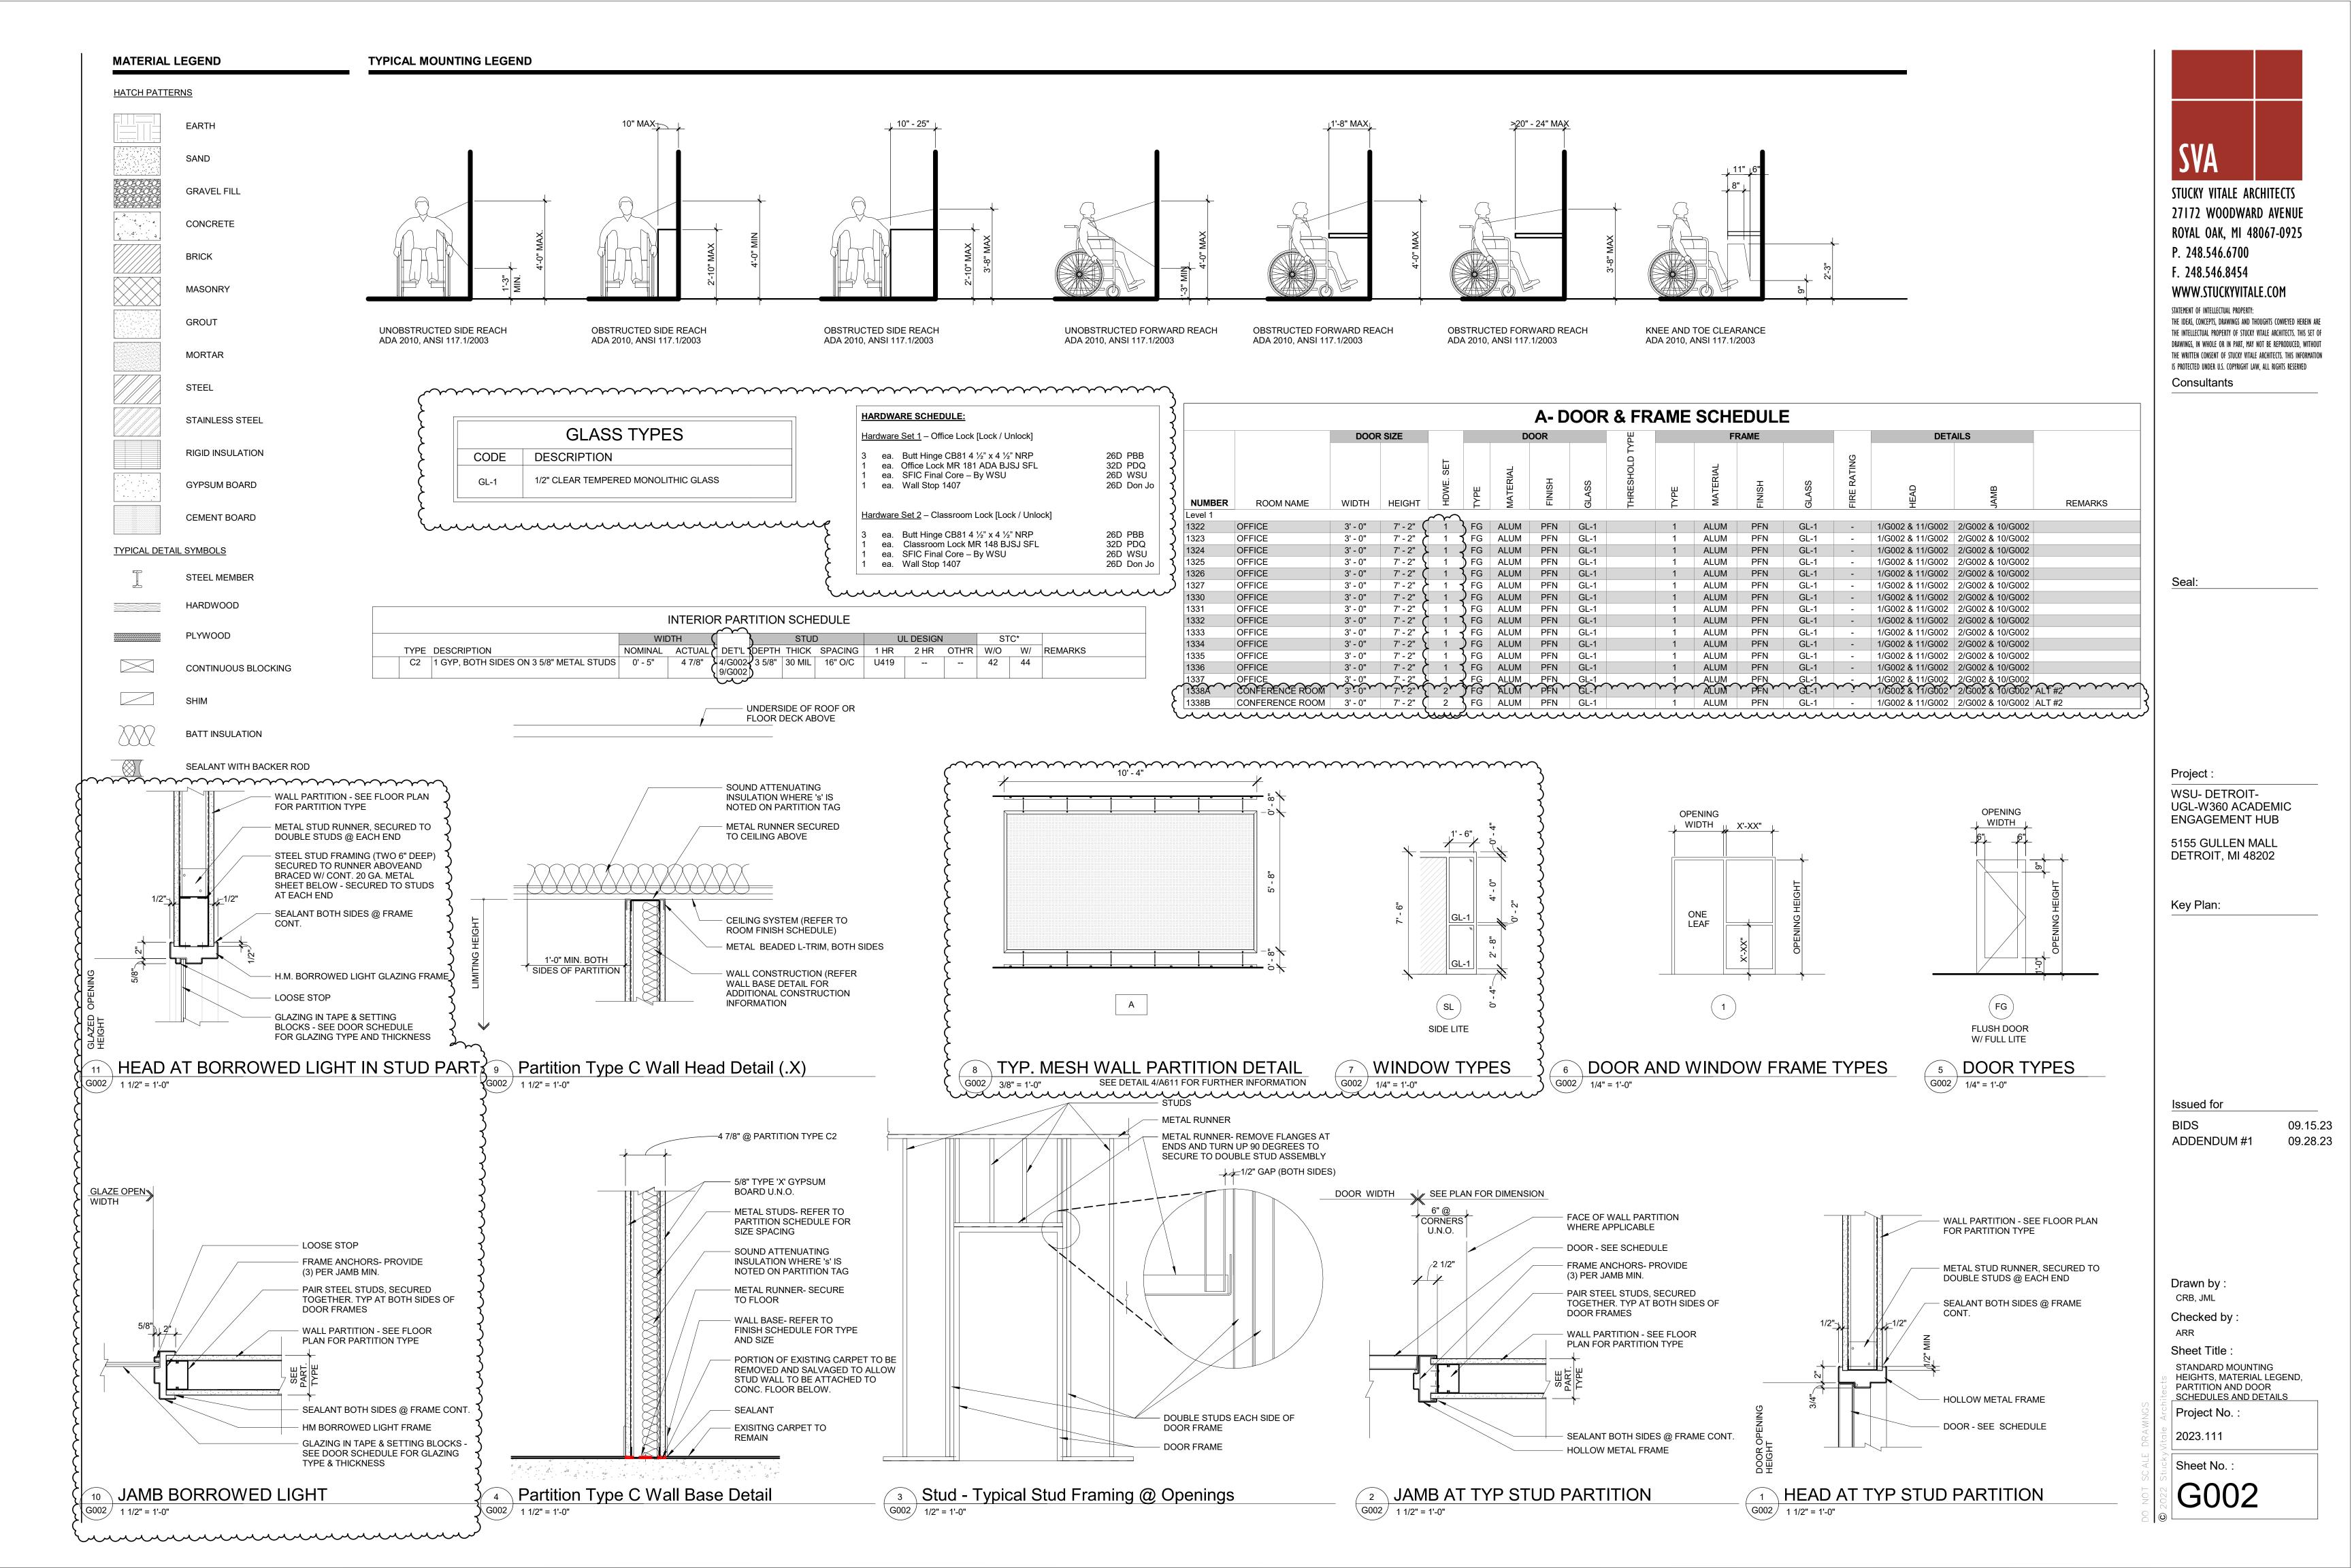
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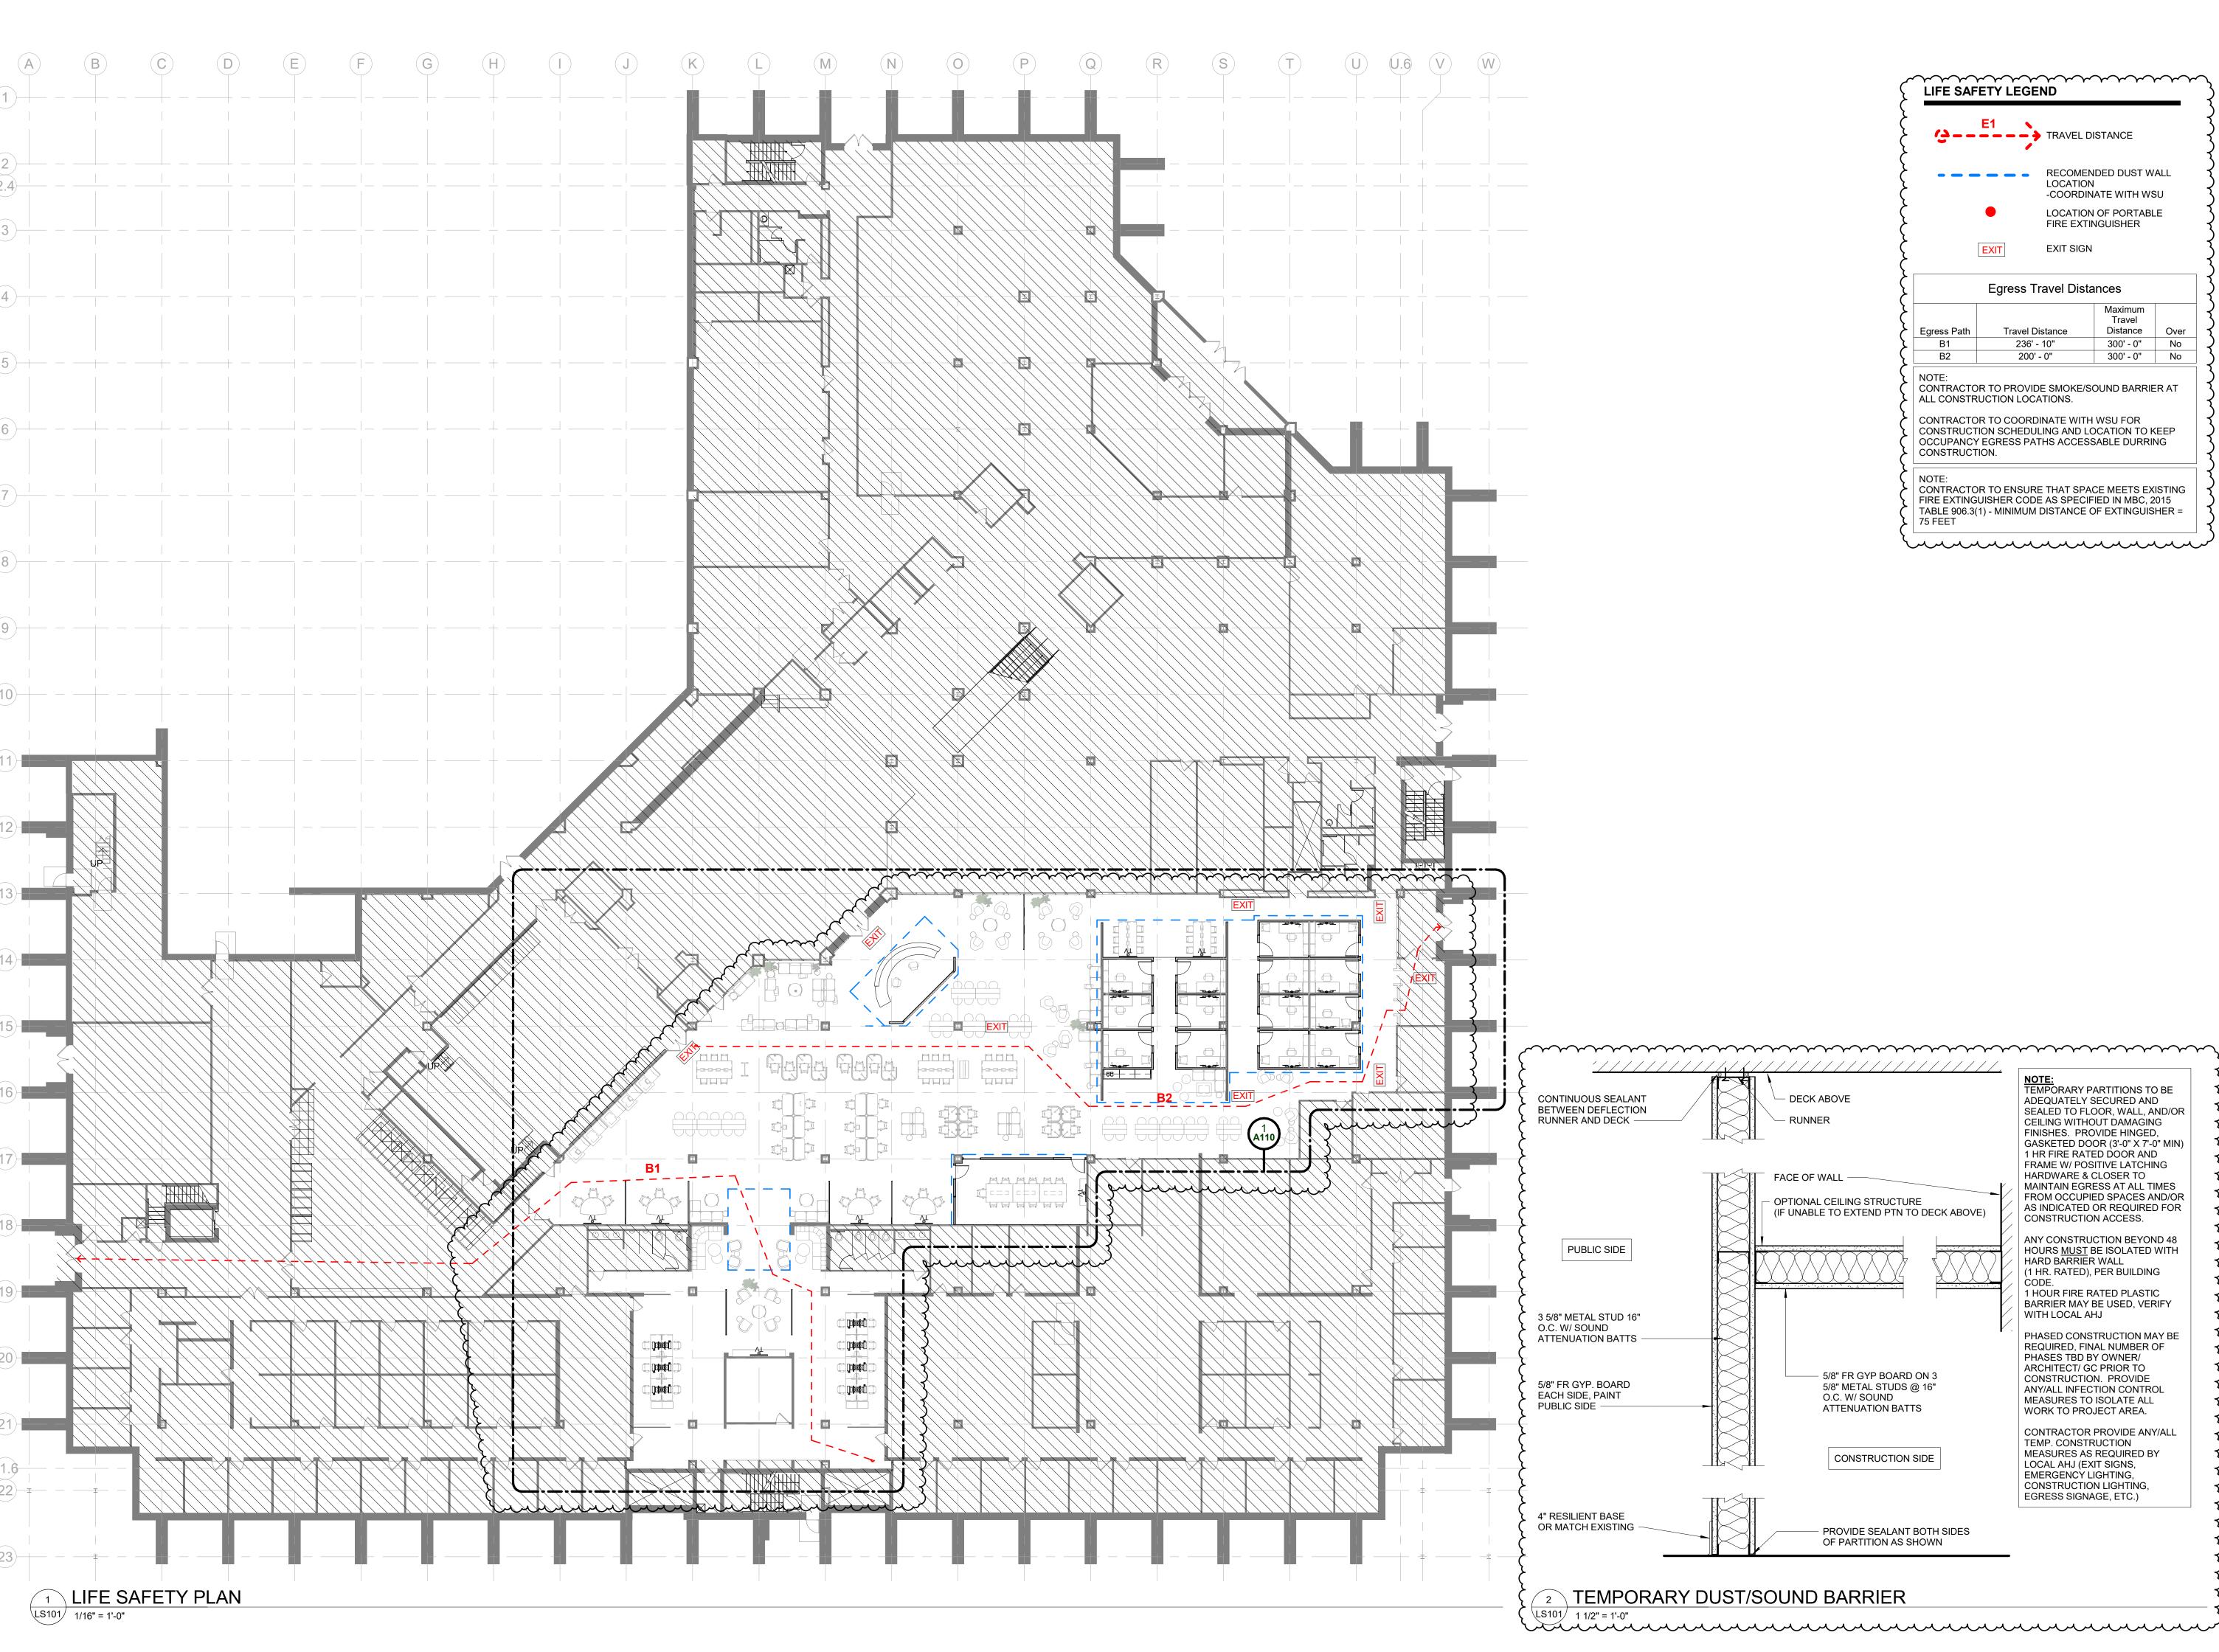
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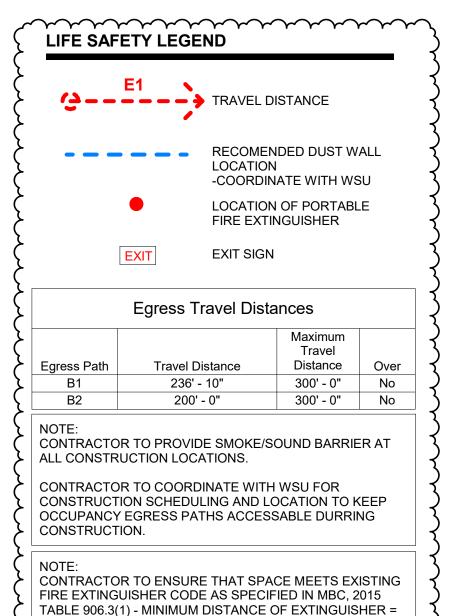
INFORMATION, DRAWING

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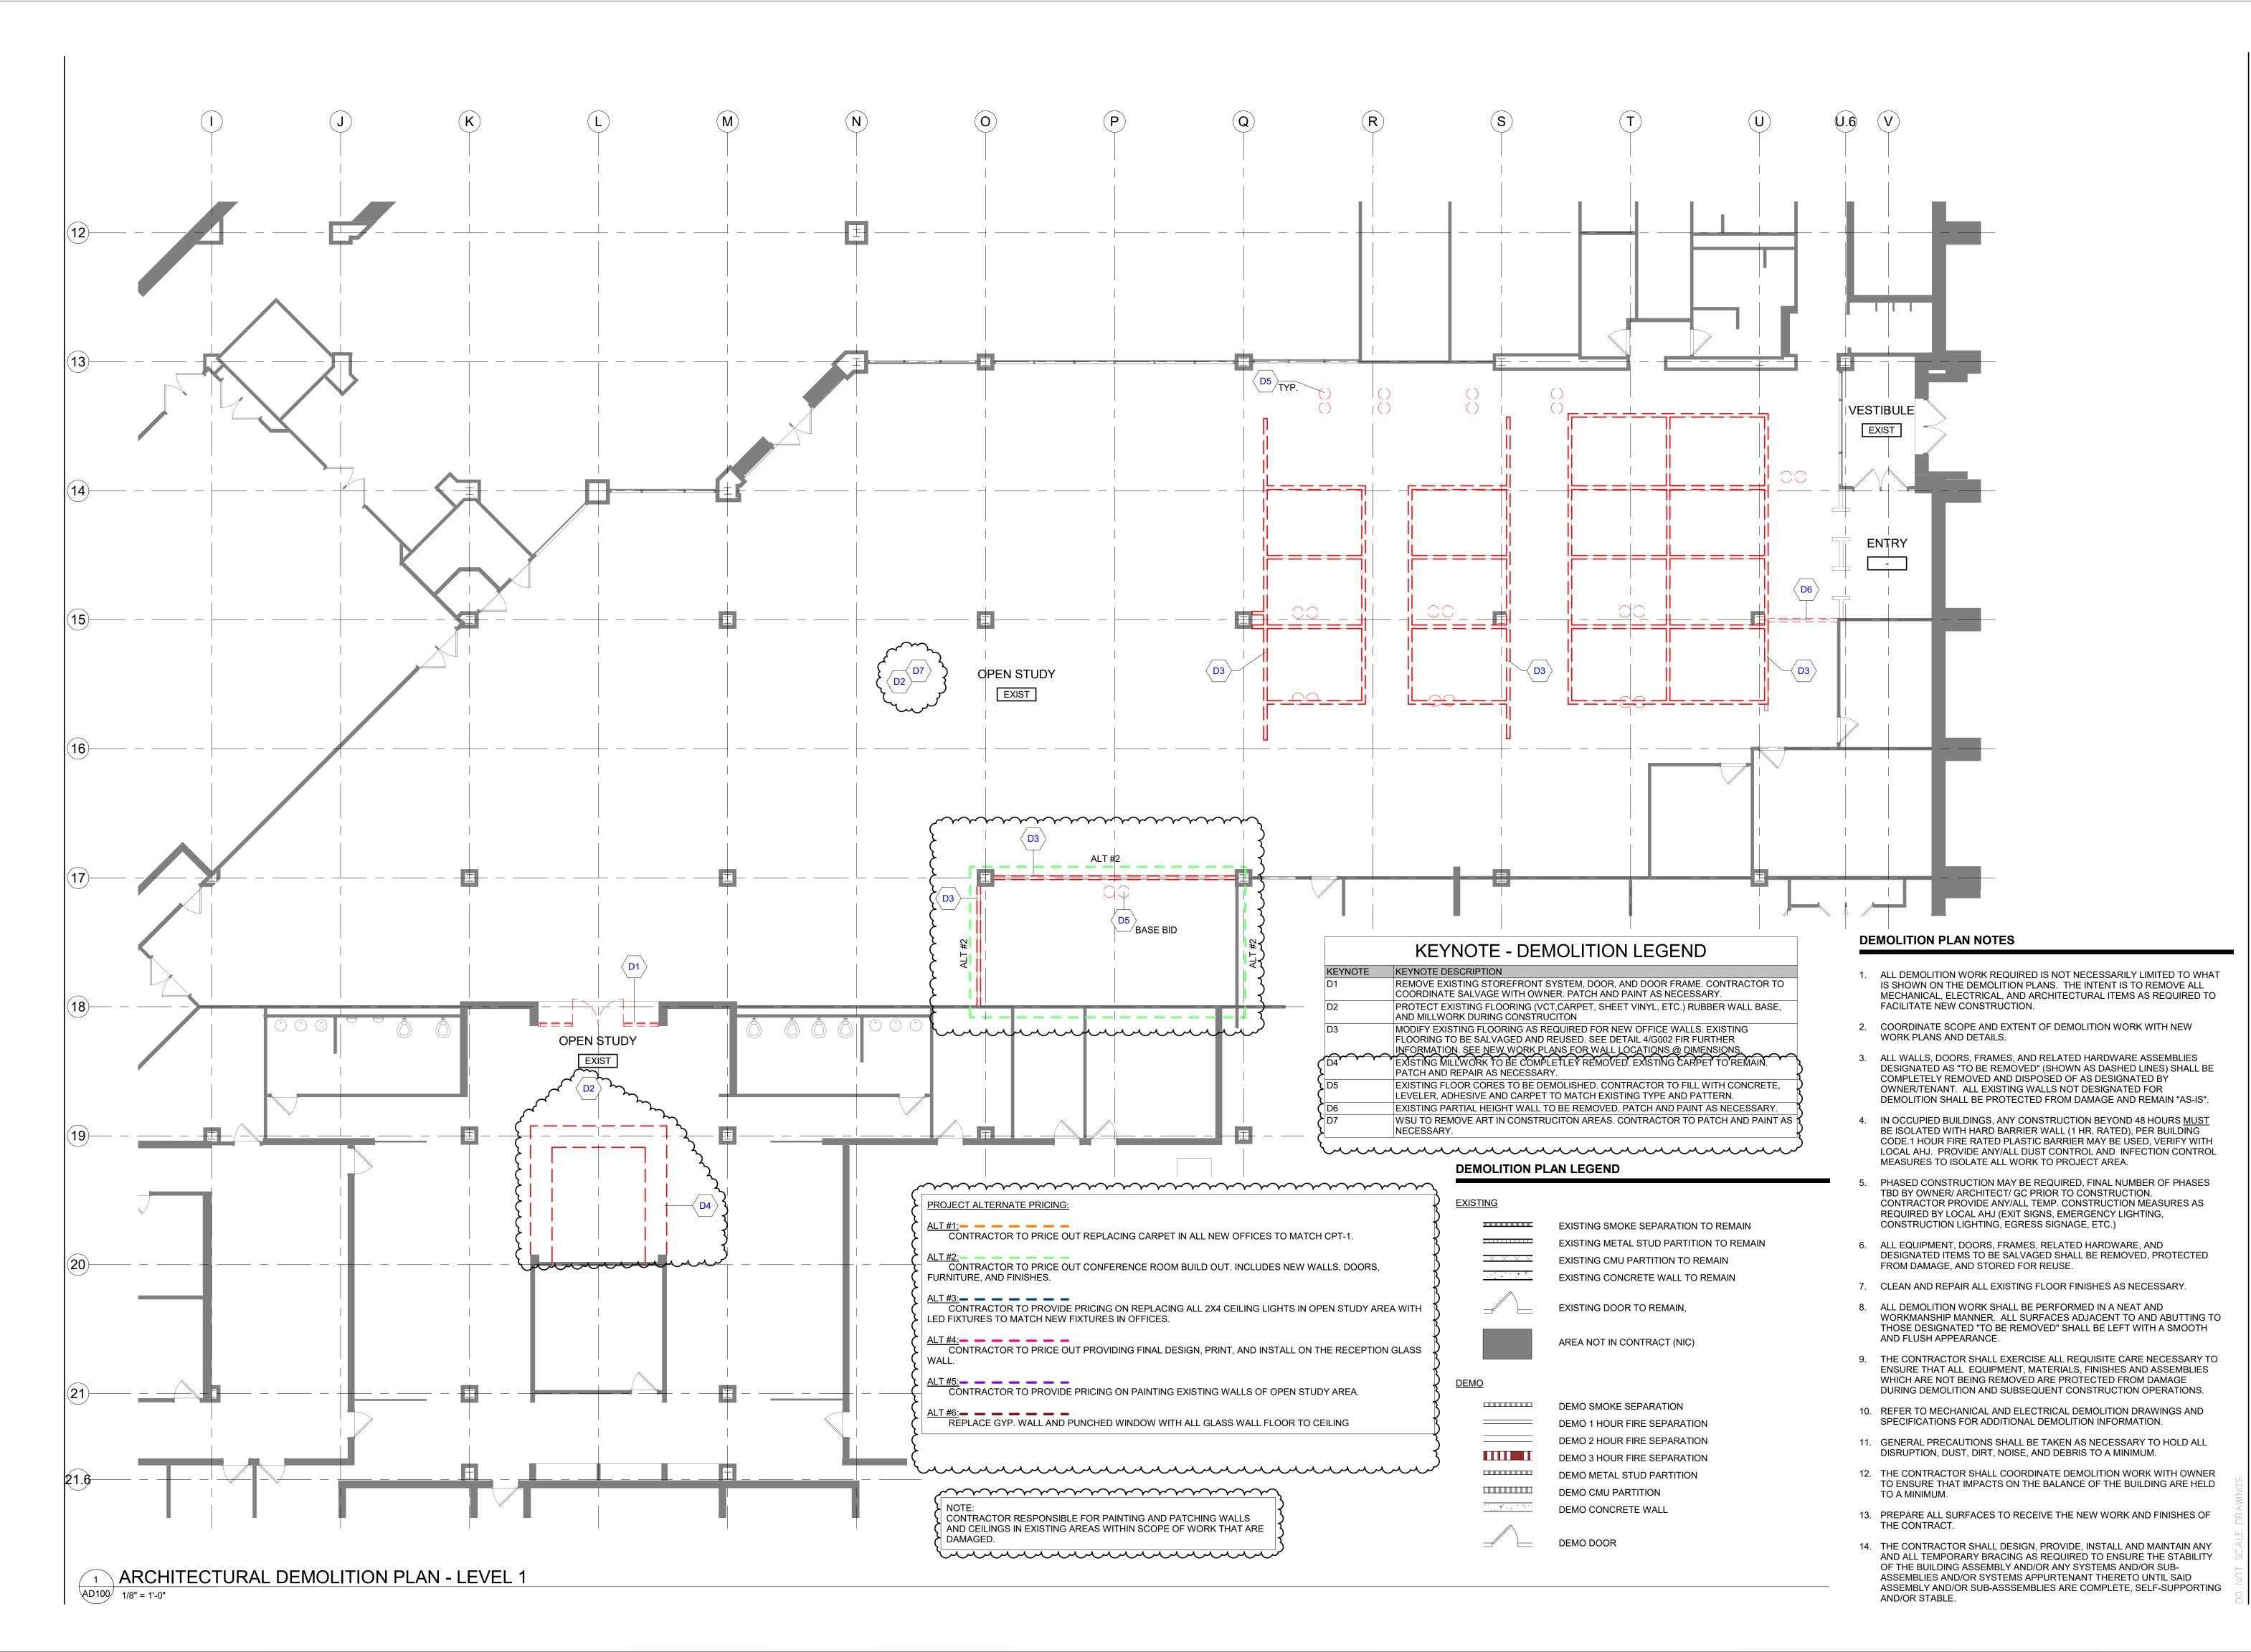
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Sheet Title: CODE INFORMATION AND FLOOR LIFE SAFETY PLAN -EGRESS PLANS

Project No.

2023.111

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09.28.23

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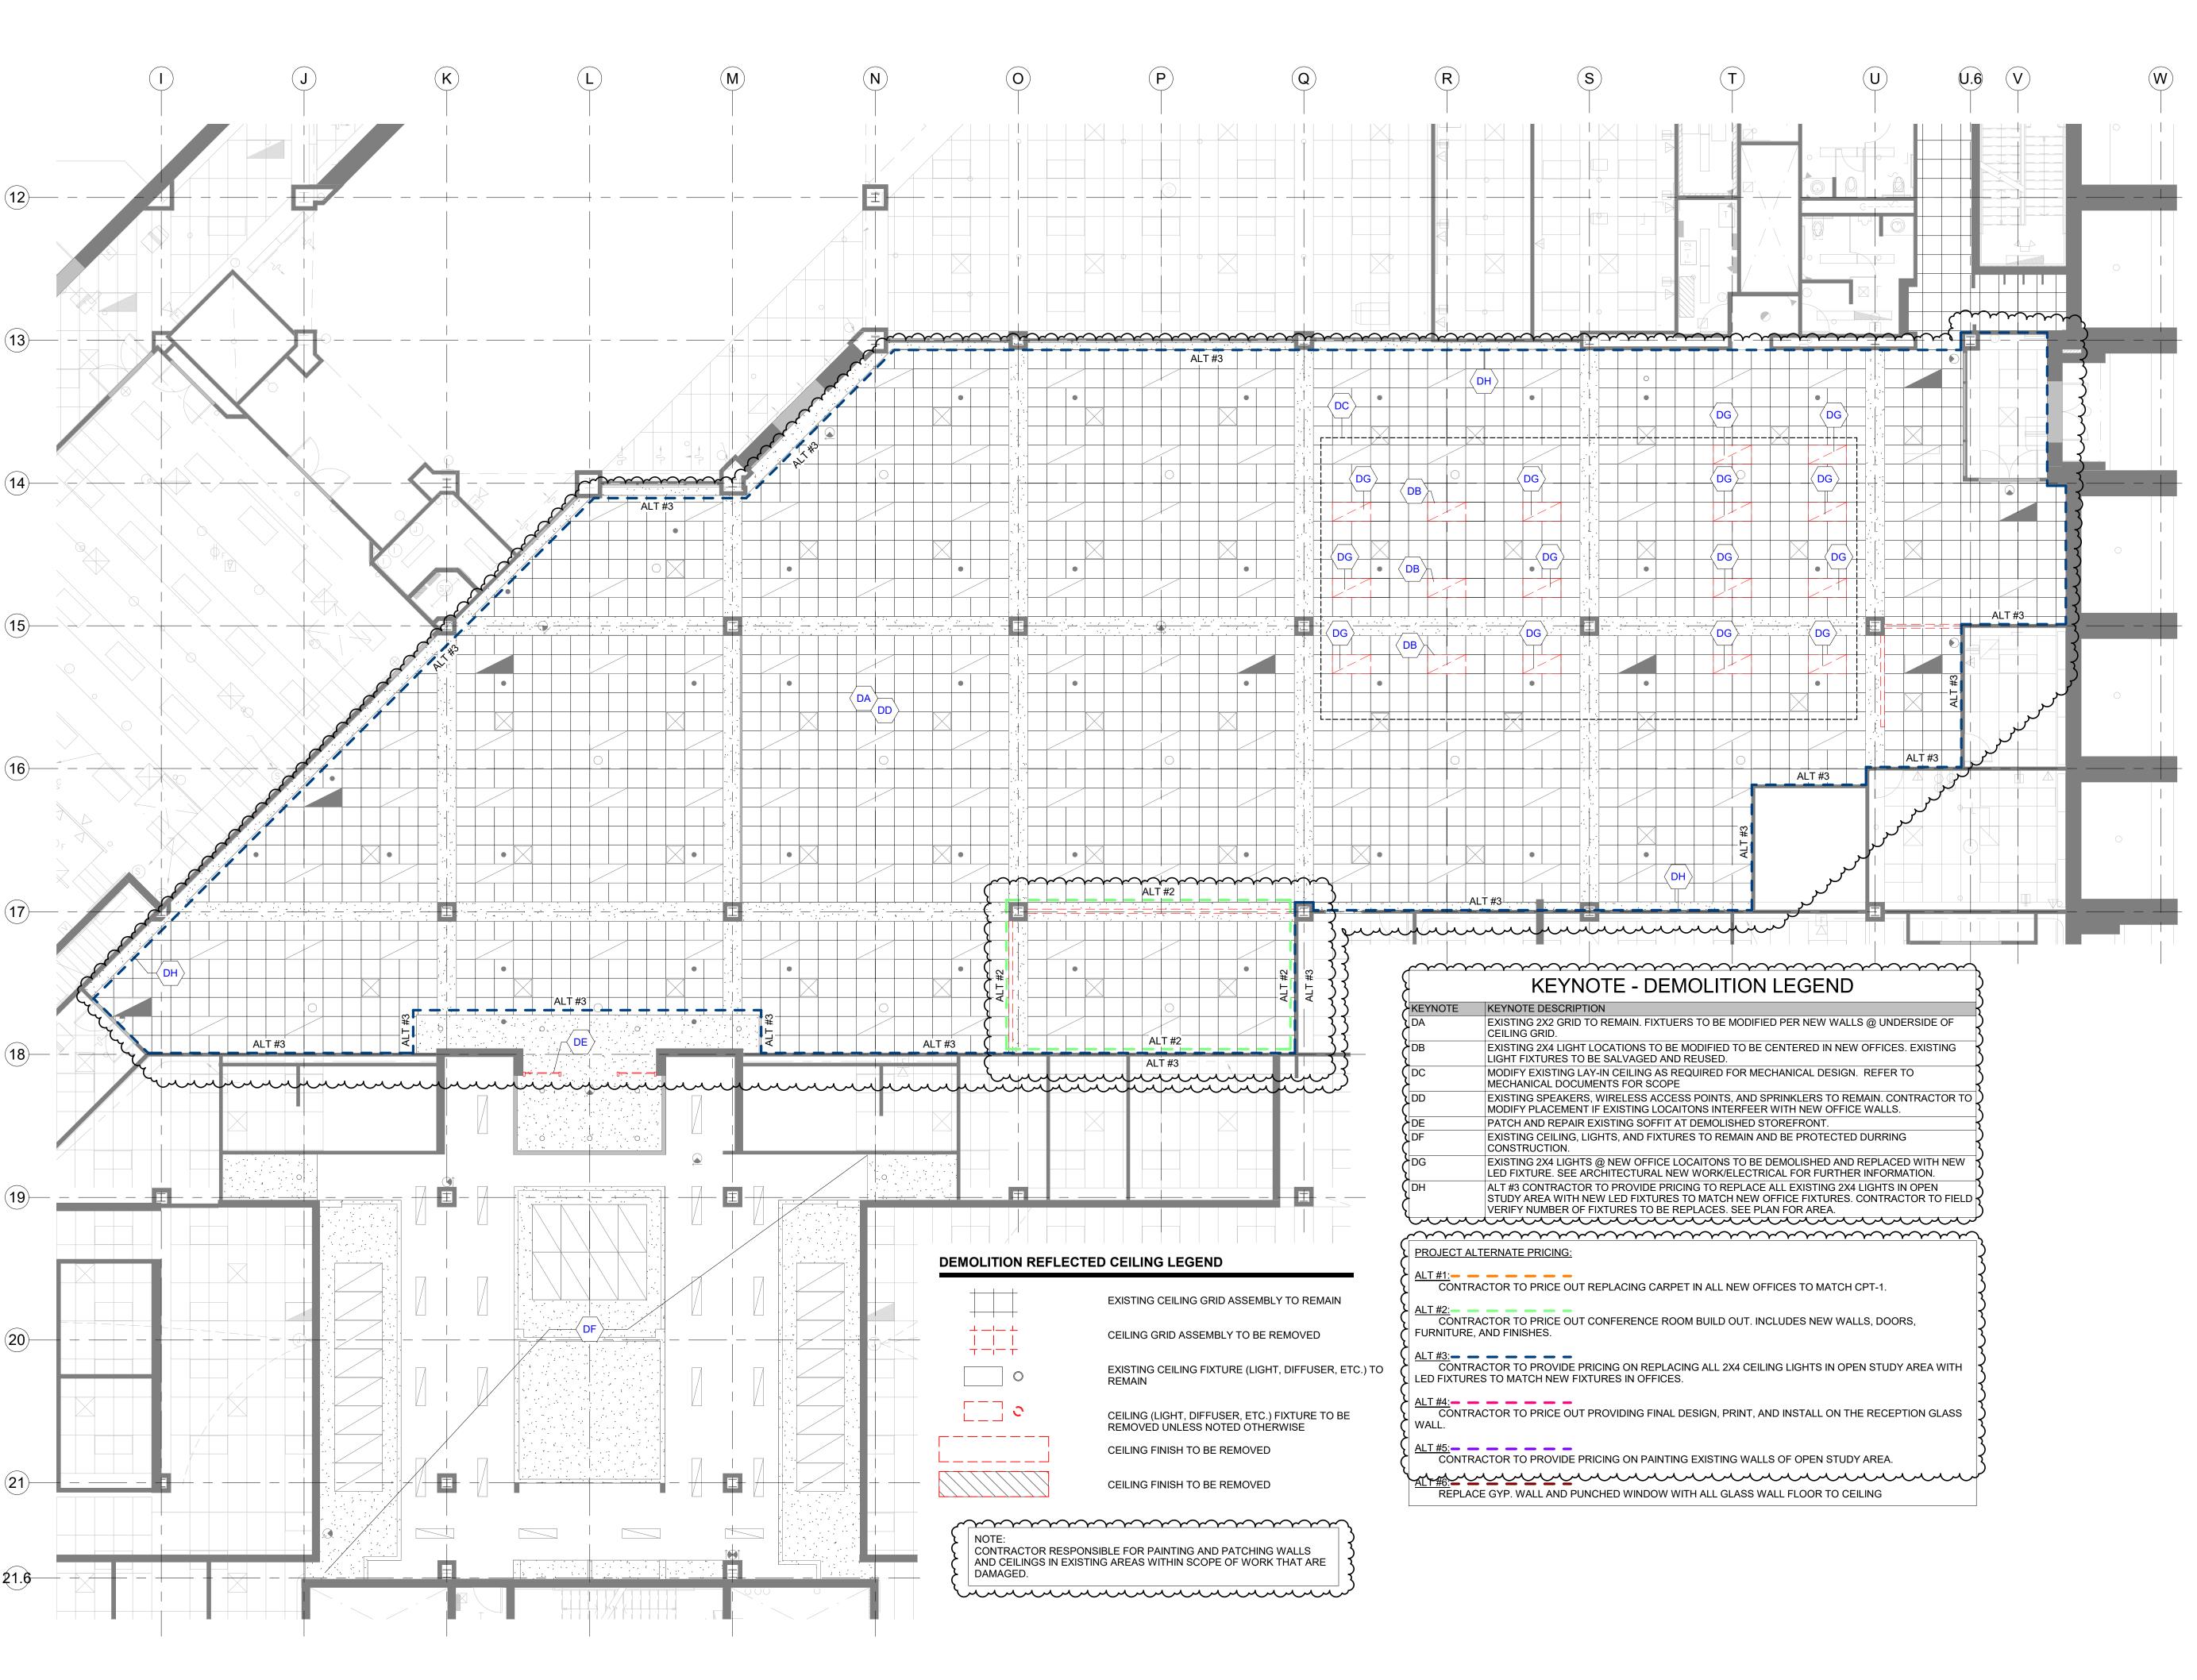
ARCHITECTURAL DEMOLITION
PLANS

Project No.

2023.111

Sheet No. :

AD100





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Sheet Title:

ARCHITECTURAL DEMOLITION
REFLECTED CEILING PLAN


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2023.111

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ARCHITECTURAL DEMOLITION REFLECTED CEILING PLAN - LEVEL 1

AD200 1/8" = 1'-0"



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Drawn by:

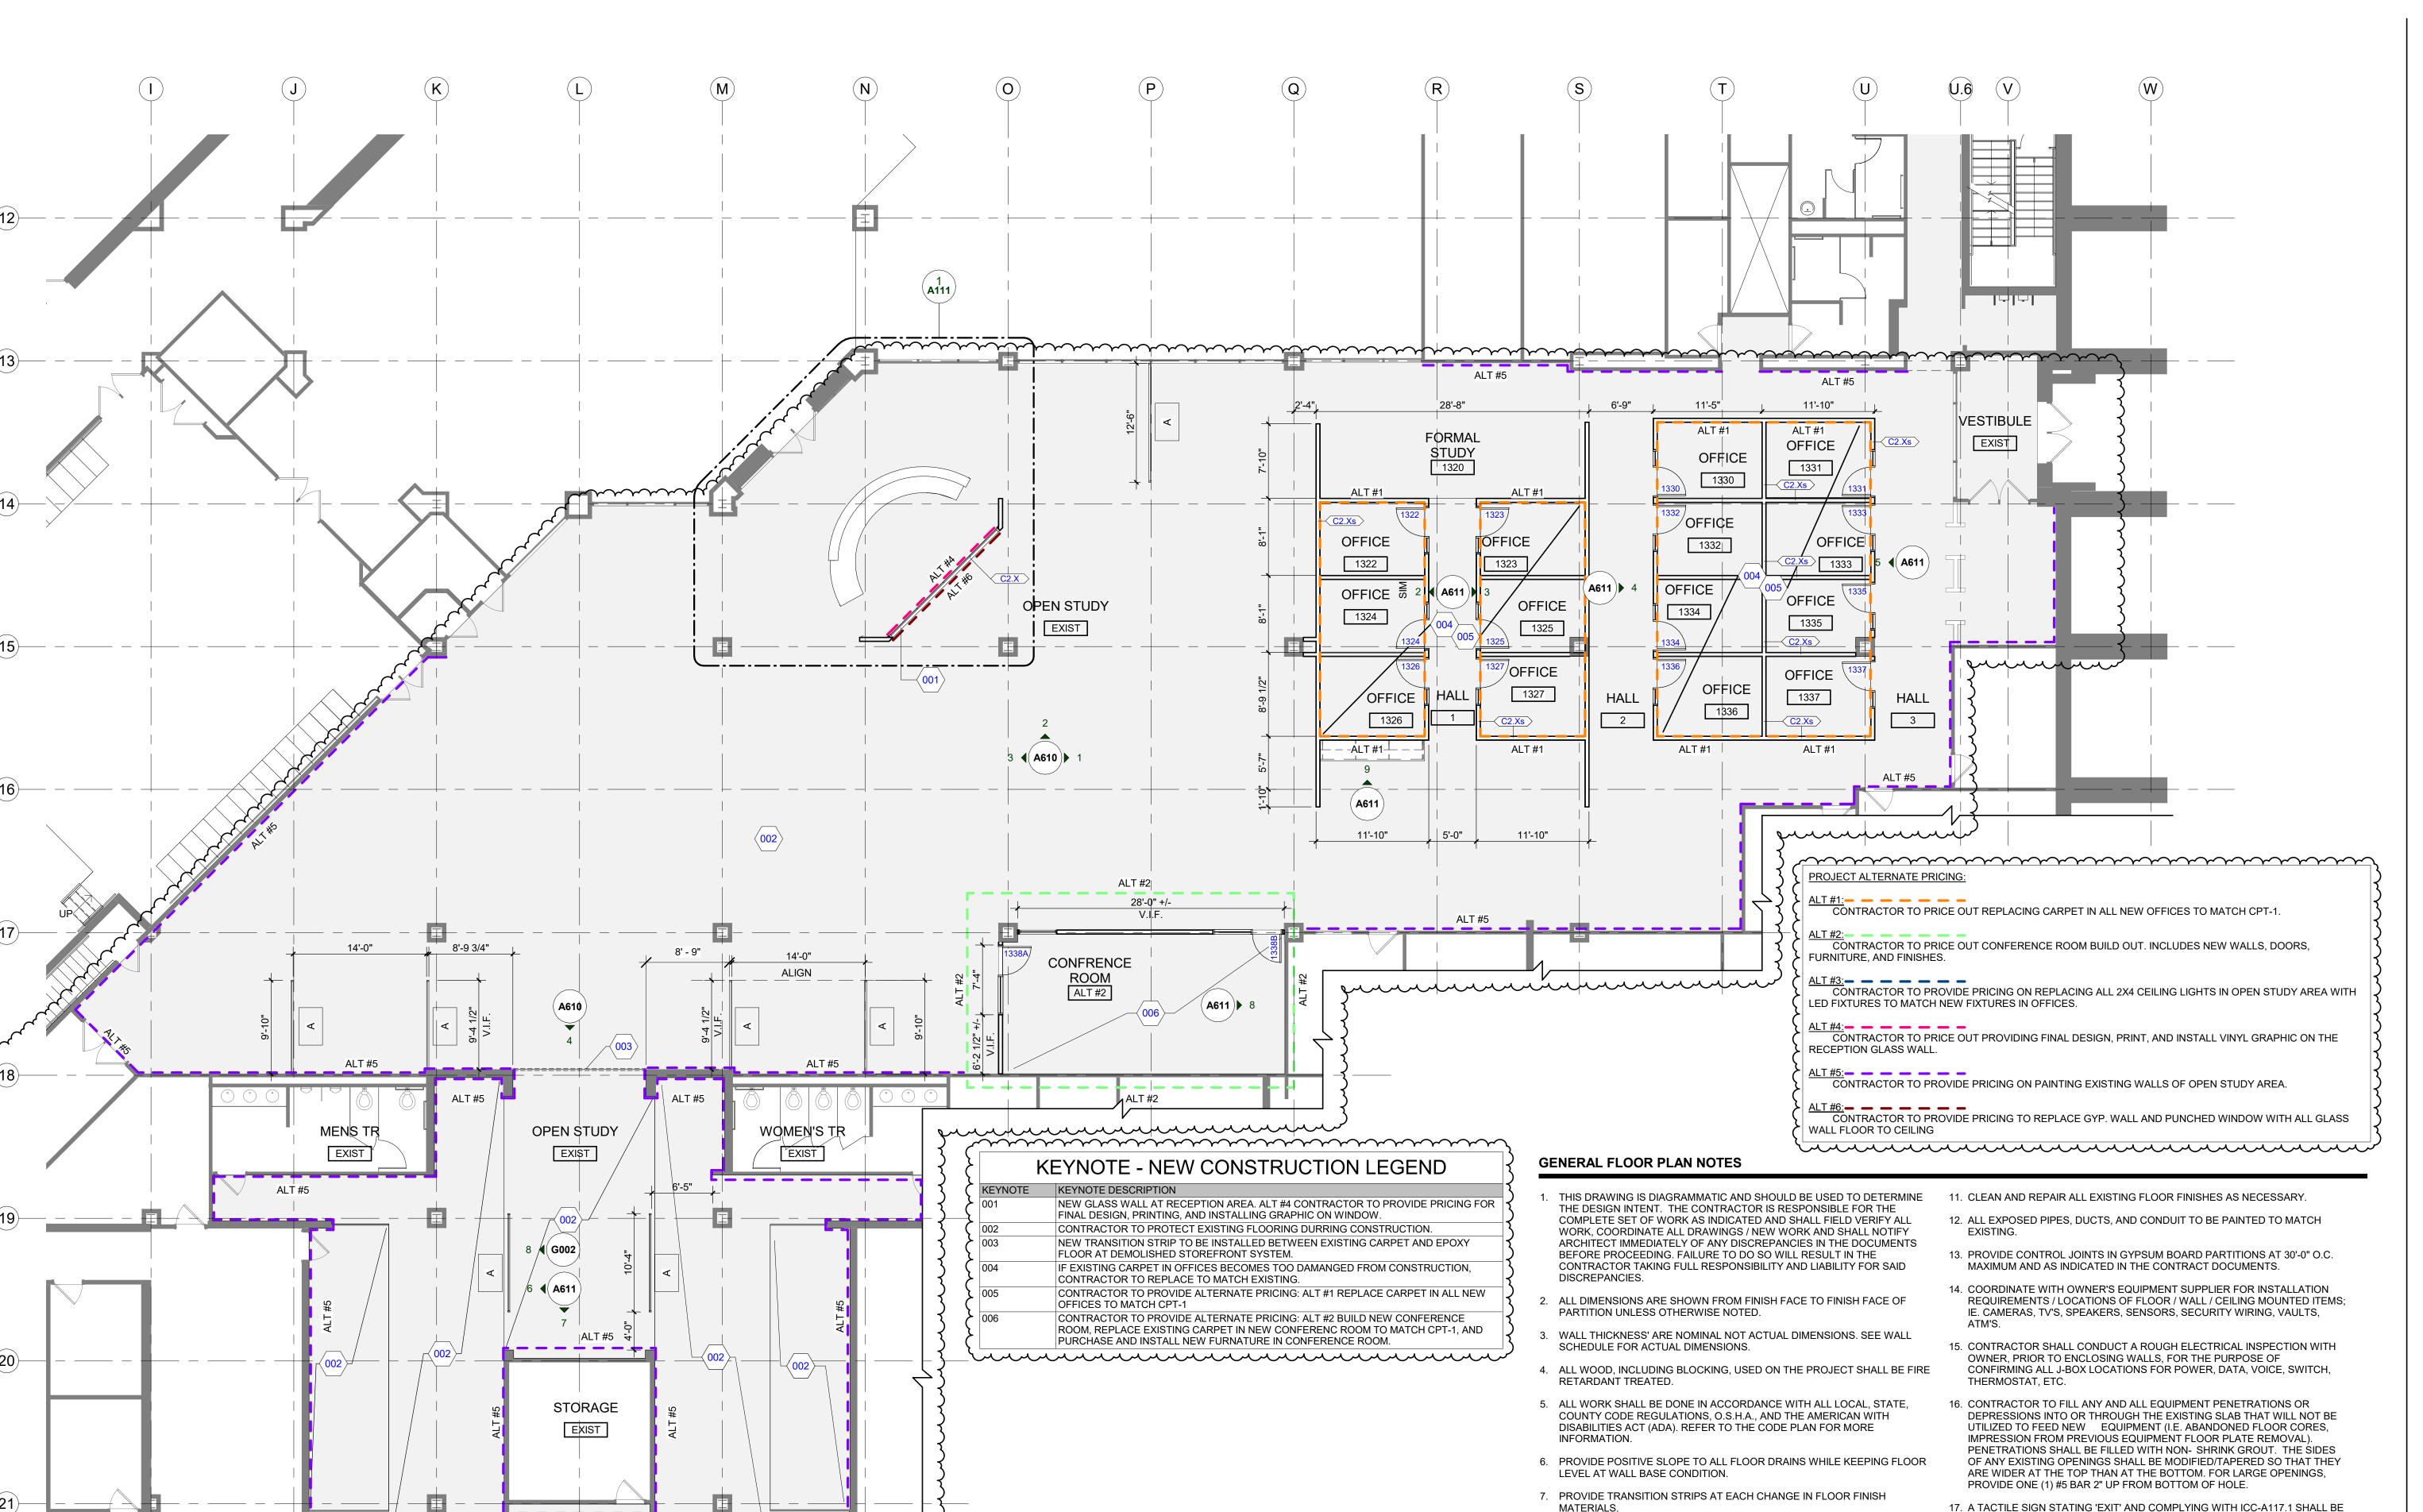JML

Checked by

PROVIDED ADJACENT TO EACH DOOR TO AN 'AREA OF REFUGE', AN

EXTERIOR AREA FOR ASSISTED RESCUE, AN EXIT STAIRWAY, AN EXIT

18. PROVIDE PERMANENT MIN 3-INCH HIGH CONTRASTING COLOR MARKING

PARTITIONS, SMOKE BARRIERS, SMOKE PARTITIONS OR ANY OTHER WALL

REQUIRED TO HAVE PROTECTED OPENINGS OR PENETRATIONS WITHIN 15

FEET AT THE END OF EACH WALL, AND NOT EXCEEDING 30 FEET MAXIMUM

HORIZONTAL INTERVALS, MINIMUM 2 LOCATIONS EACH WALL, TYPICAL FOR

ACCESSIBLE CONCEALED FLOOR, FLOOR-CEILING, OR ATTIC SPACES PER

AND IDENTIFICATION AT ALL FIRE WALLS, FIRE BARRIERS, FIRE

RAMP, AN EXIT PASSAGEWAY, AND THE EXIT DISCHARGE.

CODE (MBC 703.7)

8. PAINT, PATCH AND REPAIR THE FOLLOWING TO MATCH EXISTING

DRAWINGS FOR MORE INFORMATION.

WALL CABINETS AND COUNTERTOPS.

CASEWORK, AND OTHER WALL MOUNTED ITEMS.

MATERIALS: FLOOR, WALL, AND CEILING SURFACES AS REQUIRED

ADJACENT TO AREAS BEING DEMOLISHED. REFER TO DEMOLITION

9. REINFORCE WALL AND PROVIDE BLOCKING AS REQUIRED TO SUPPORT

INSTALLATION OF ACCESSORIES, COAT RACKS, CHART RACKS,

10. THE CONTRACTOR SHALL PROVIDE AND INSTALL WALL REINFORCING FOR

Sheet Title: FIRST LEVEL CONSTRUCTION

Project No. 2023.111

Sheet No.


ARCHITECTURAL FLOOR PLAN - LEVEL 1 A110 / 1/8" = 1'-0"

ALT #5


minument of the second second

ALT #5

ALT #5

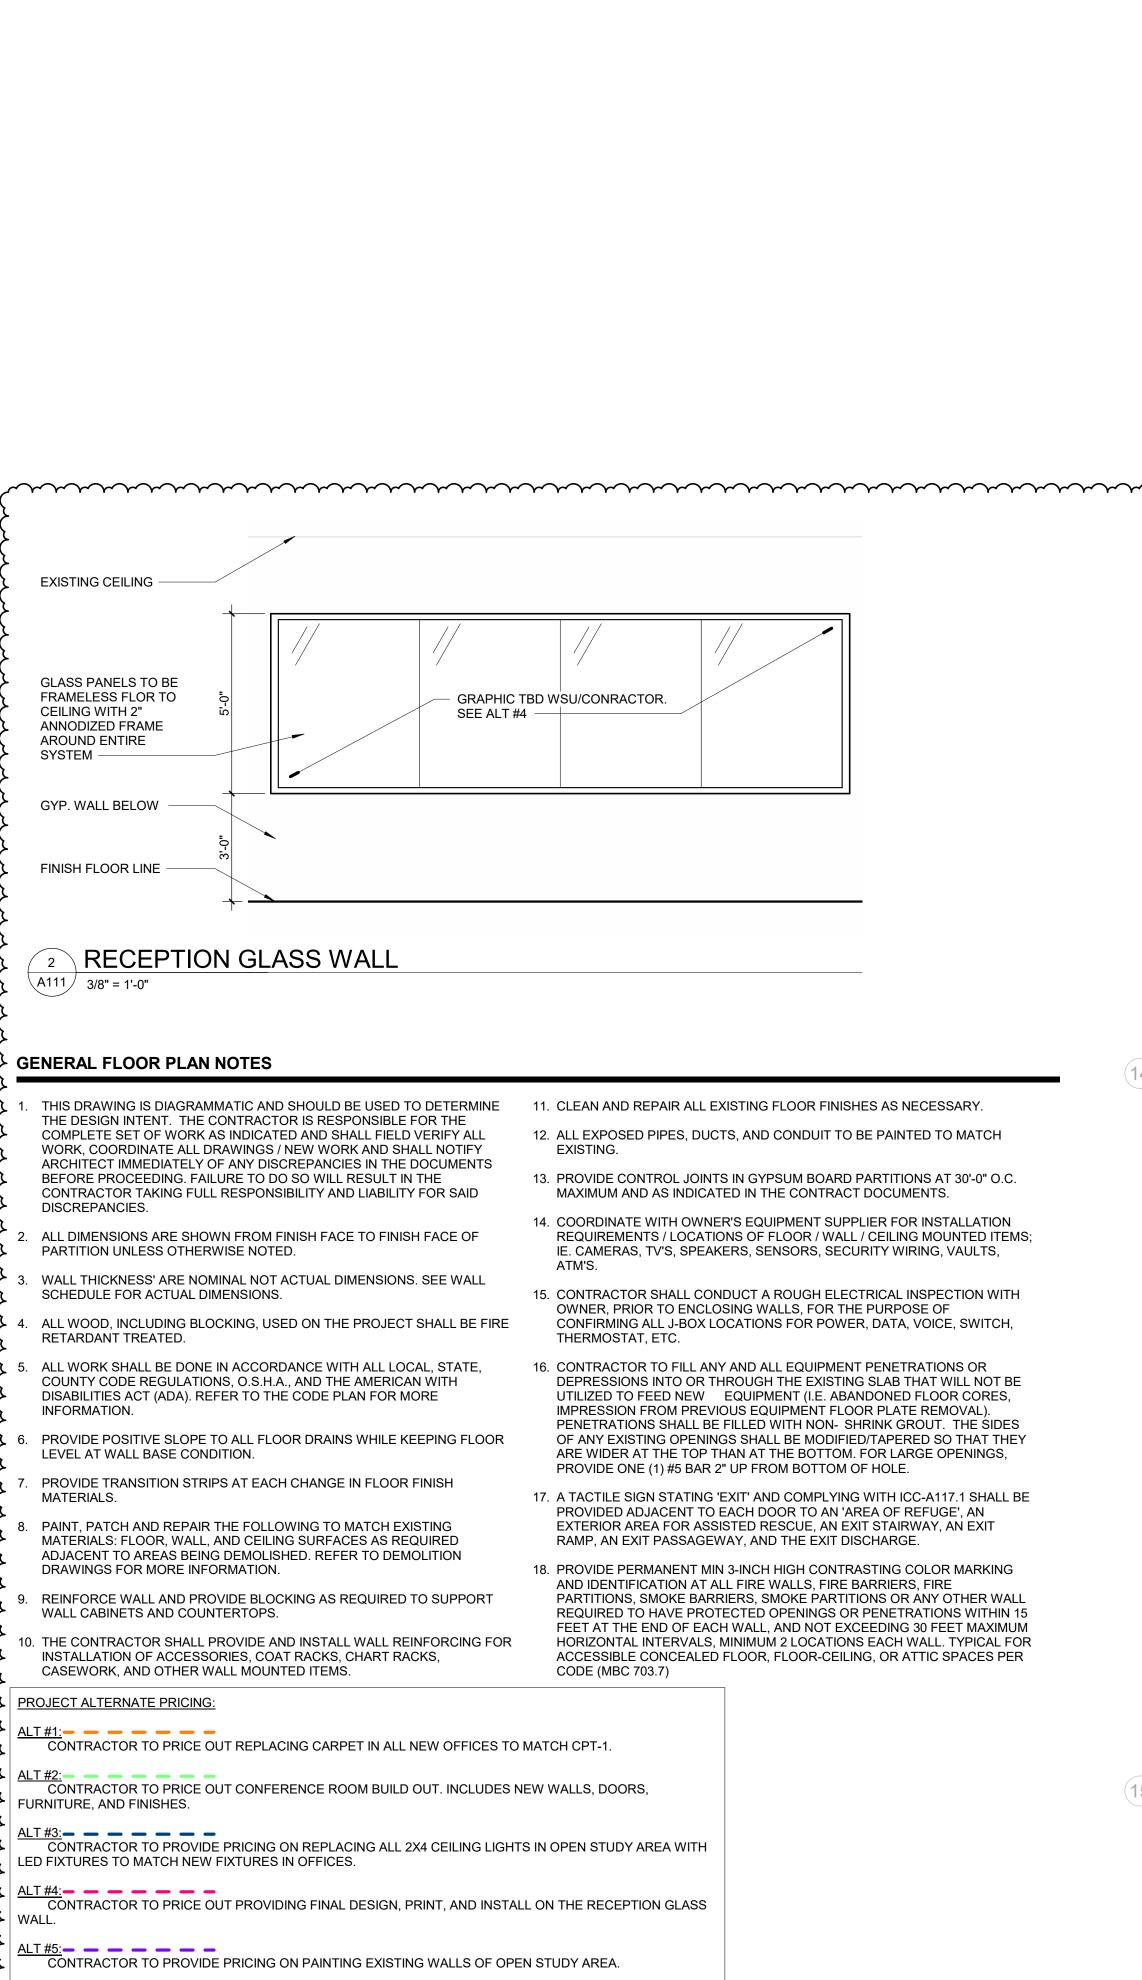

REPLACE GYP. WALL AND PUNCHED WINDOW WITH ALL GLASS WALL FLOOR TO CEILING

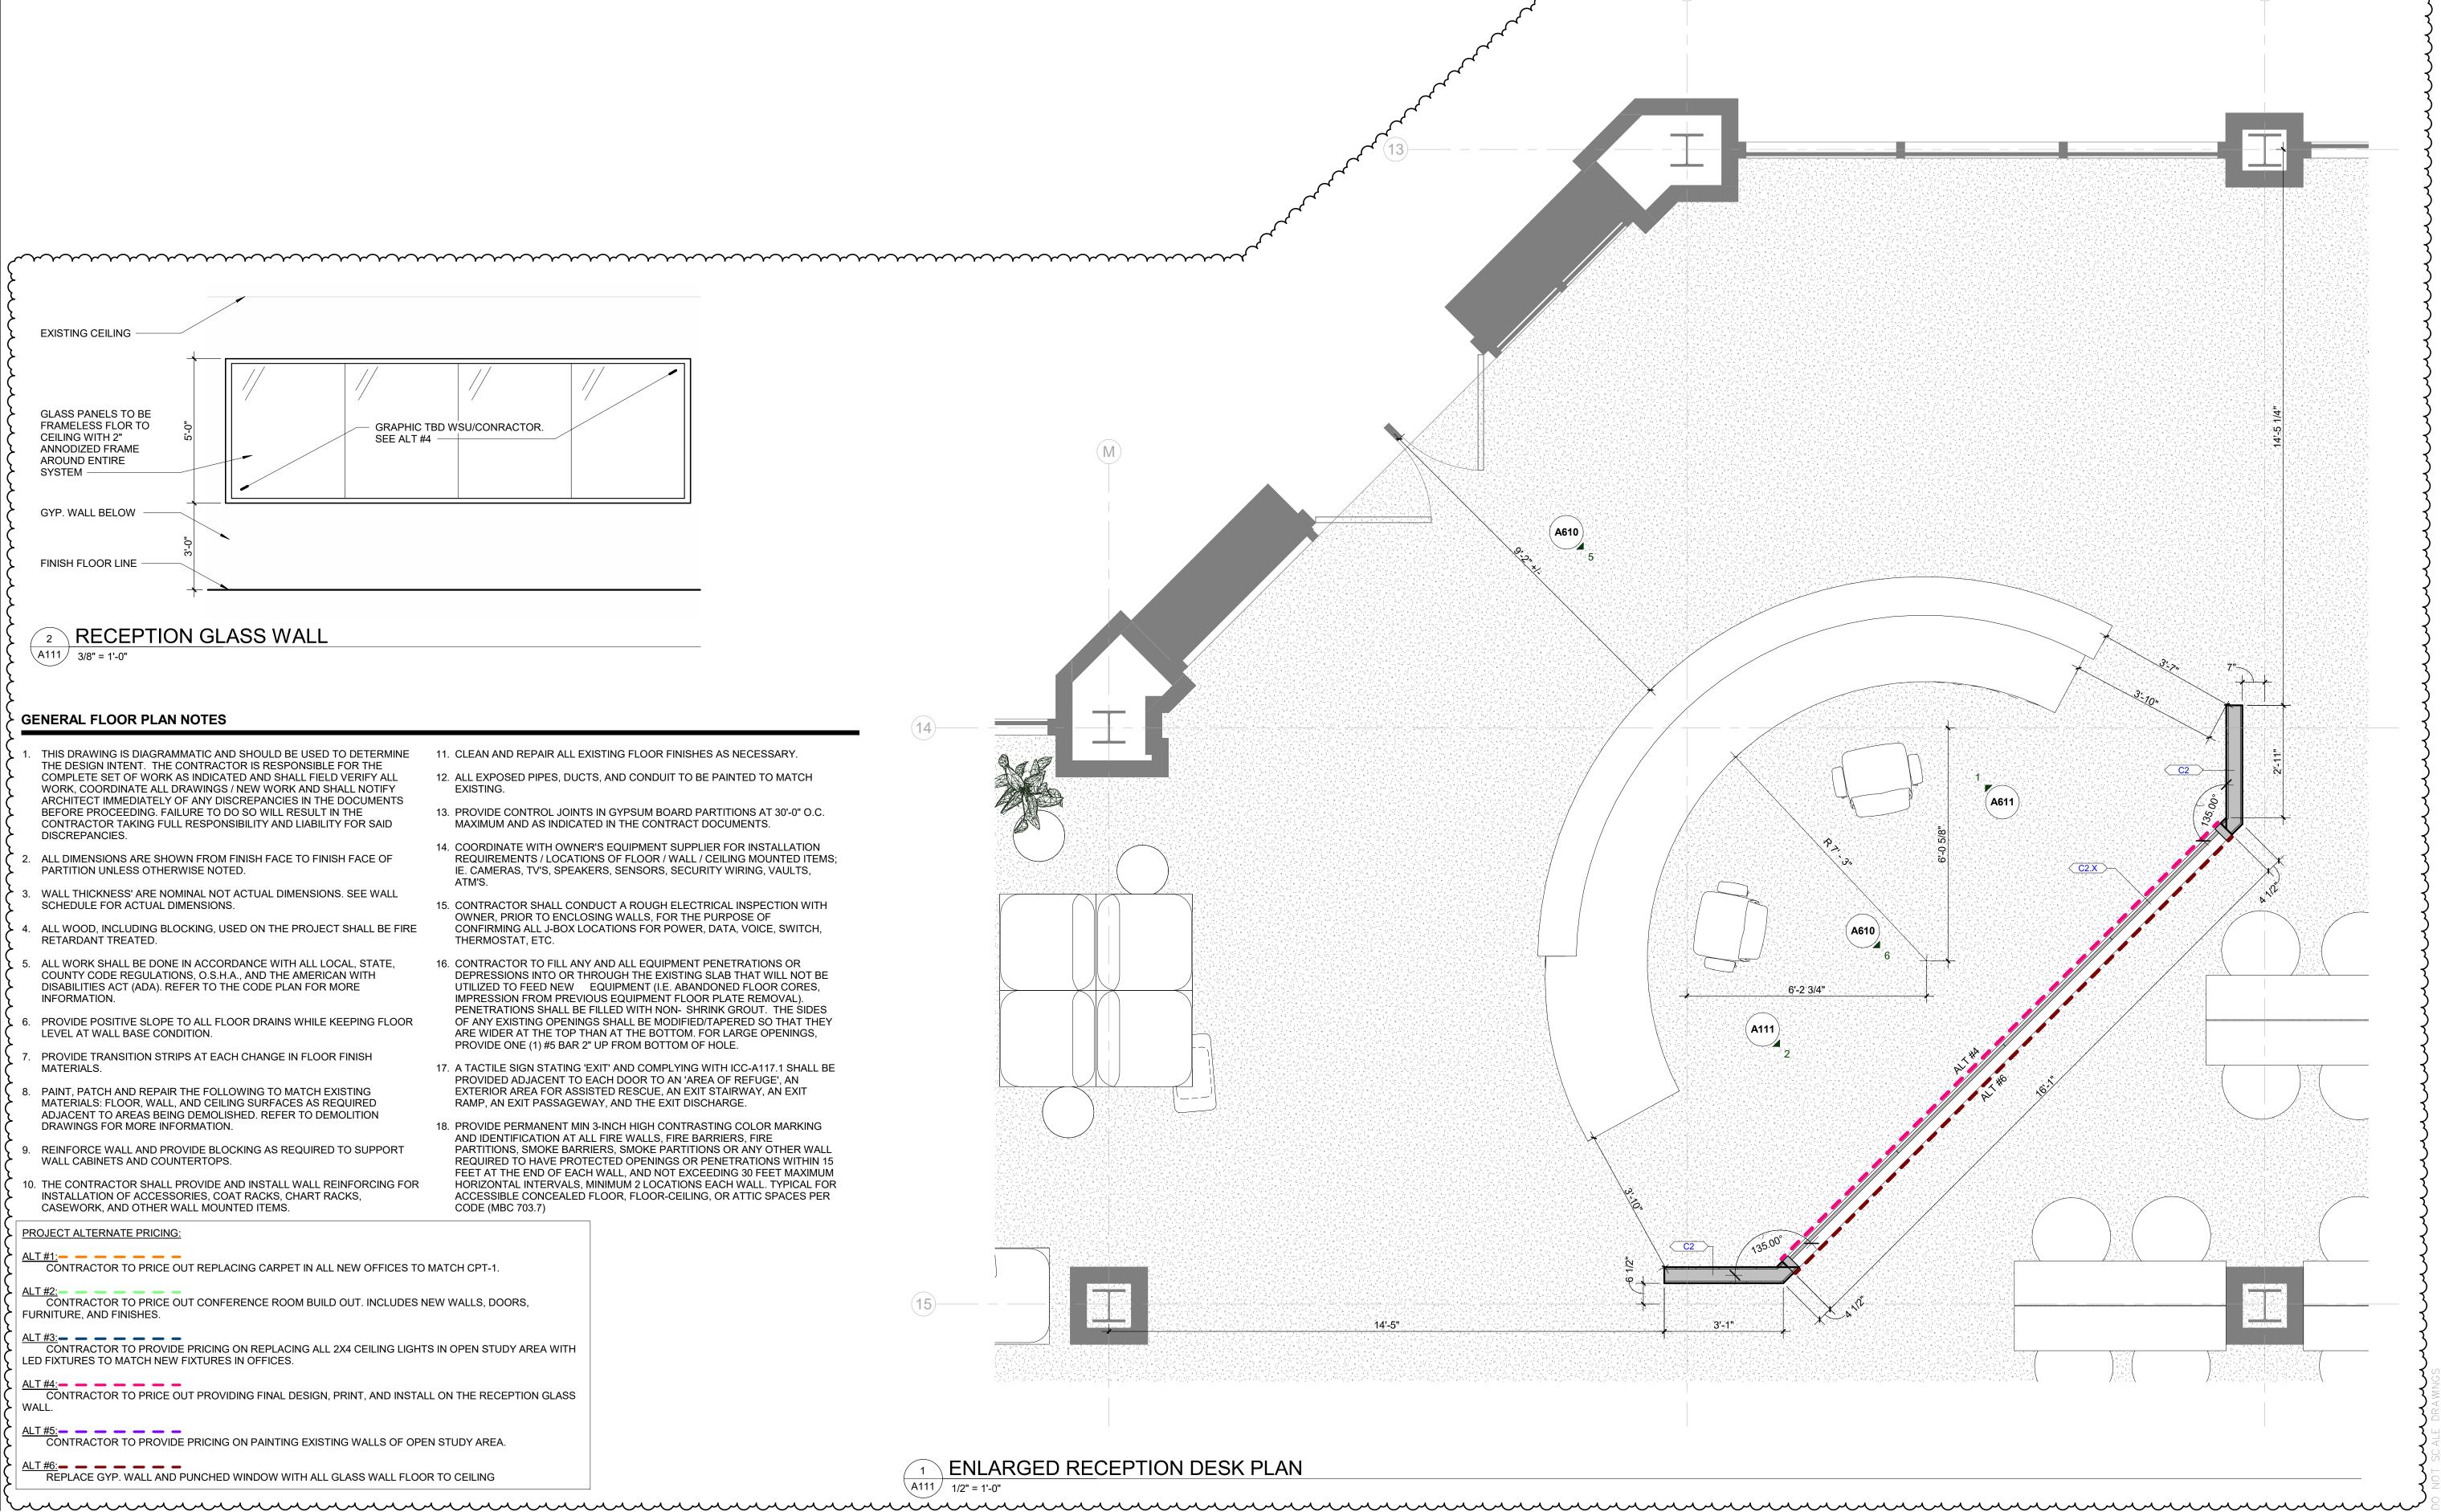



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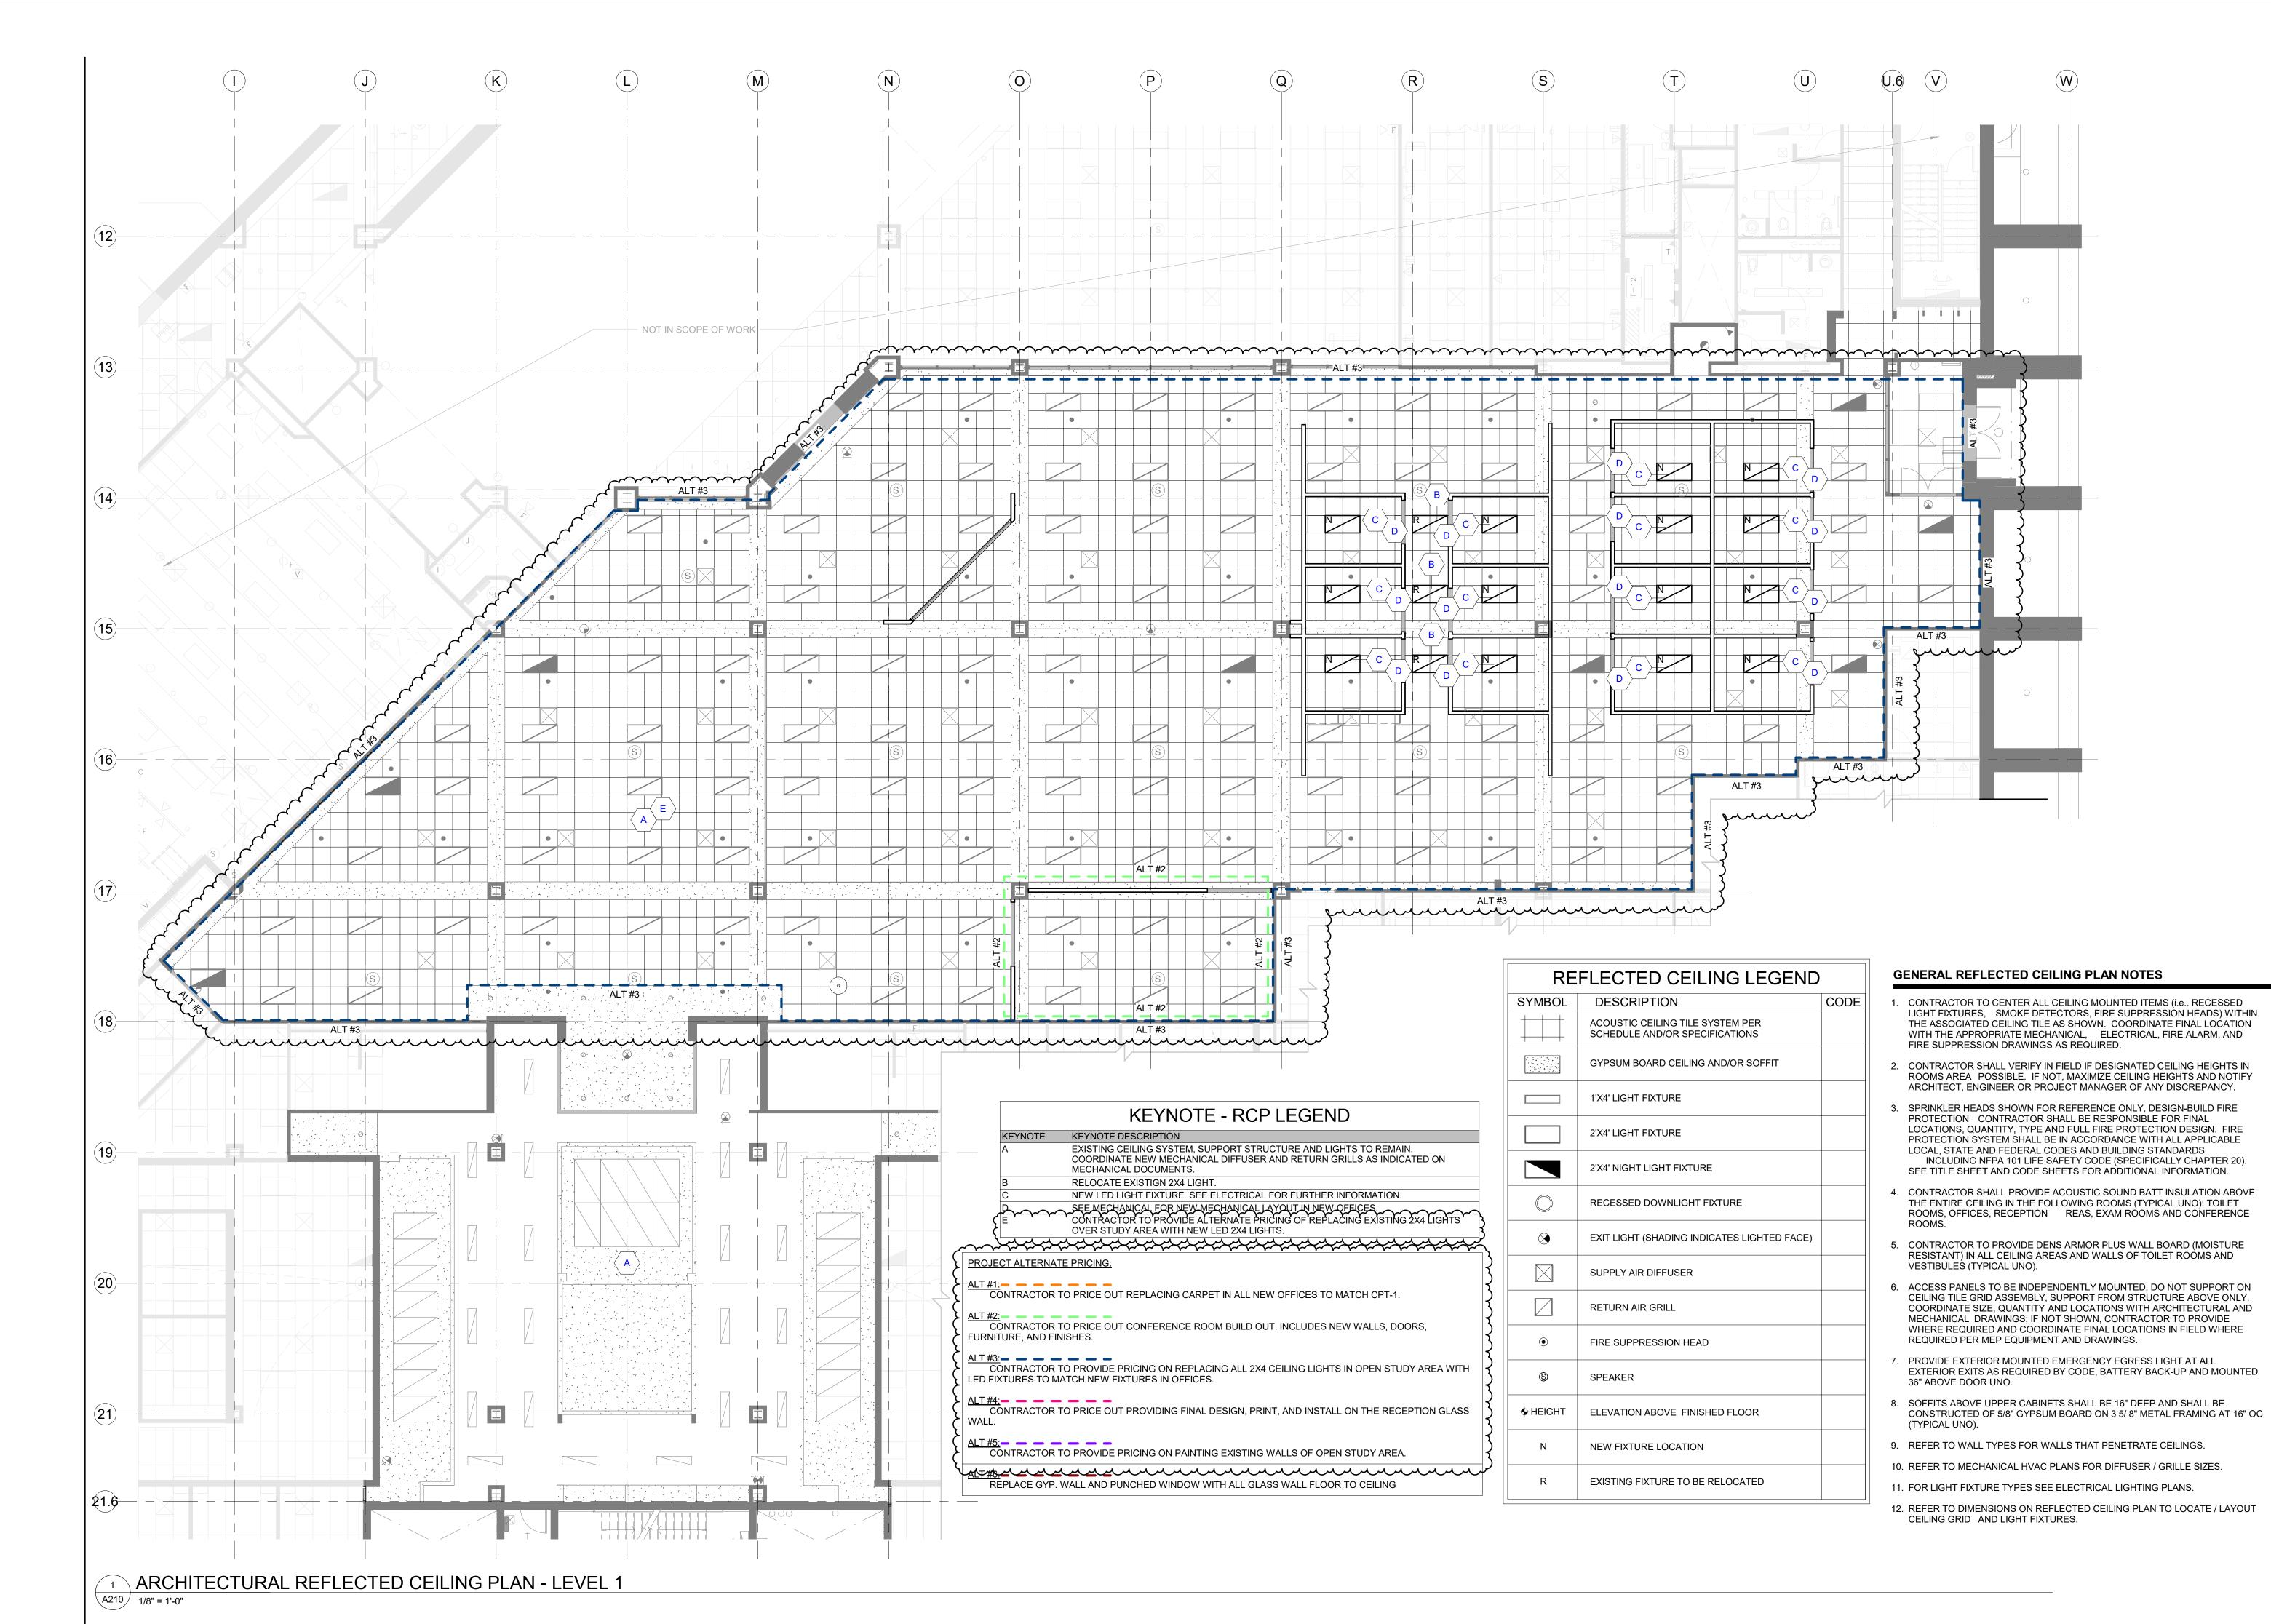
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ENLARGED RECEPTION AREA

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CEILING PLAN

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ADDENDUM # I

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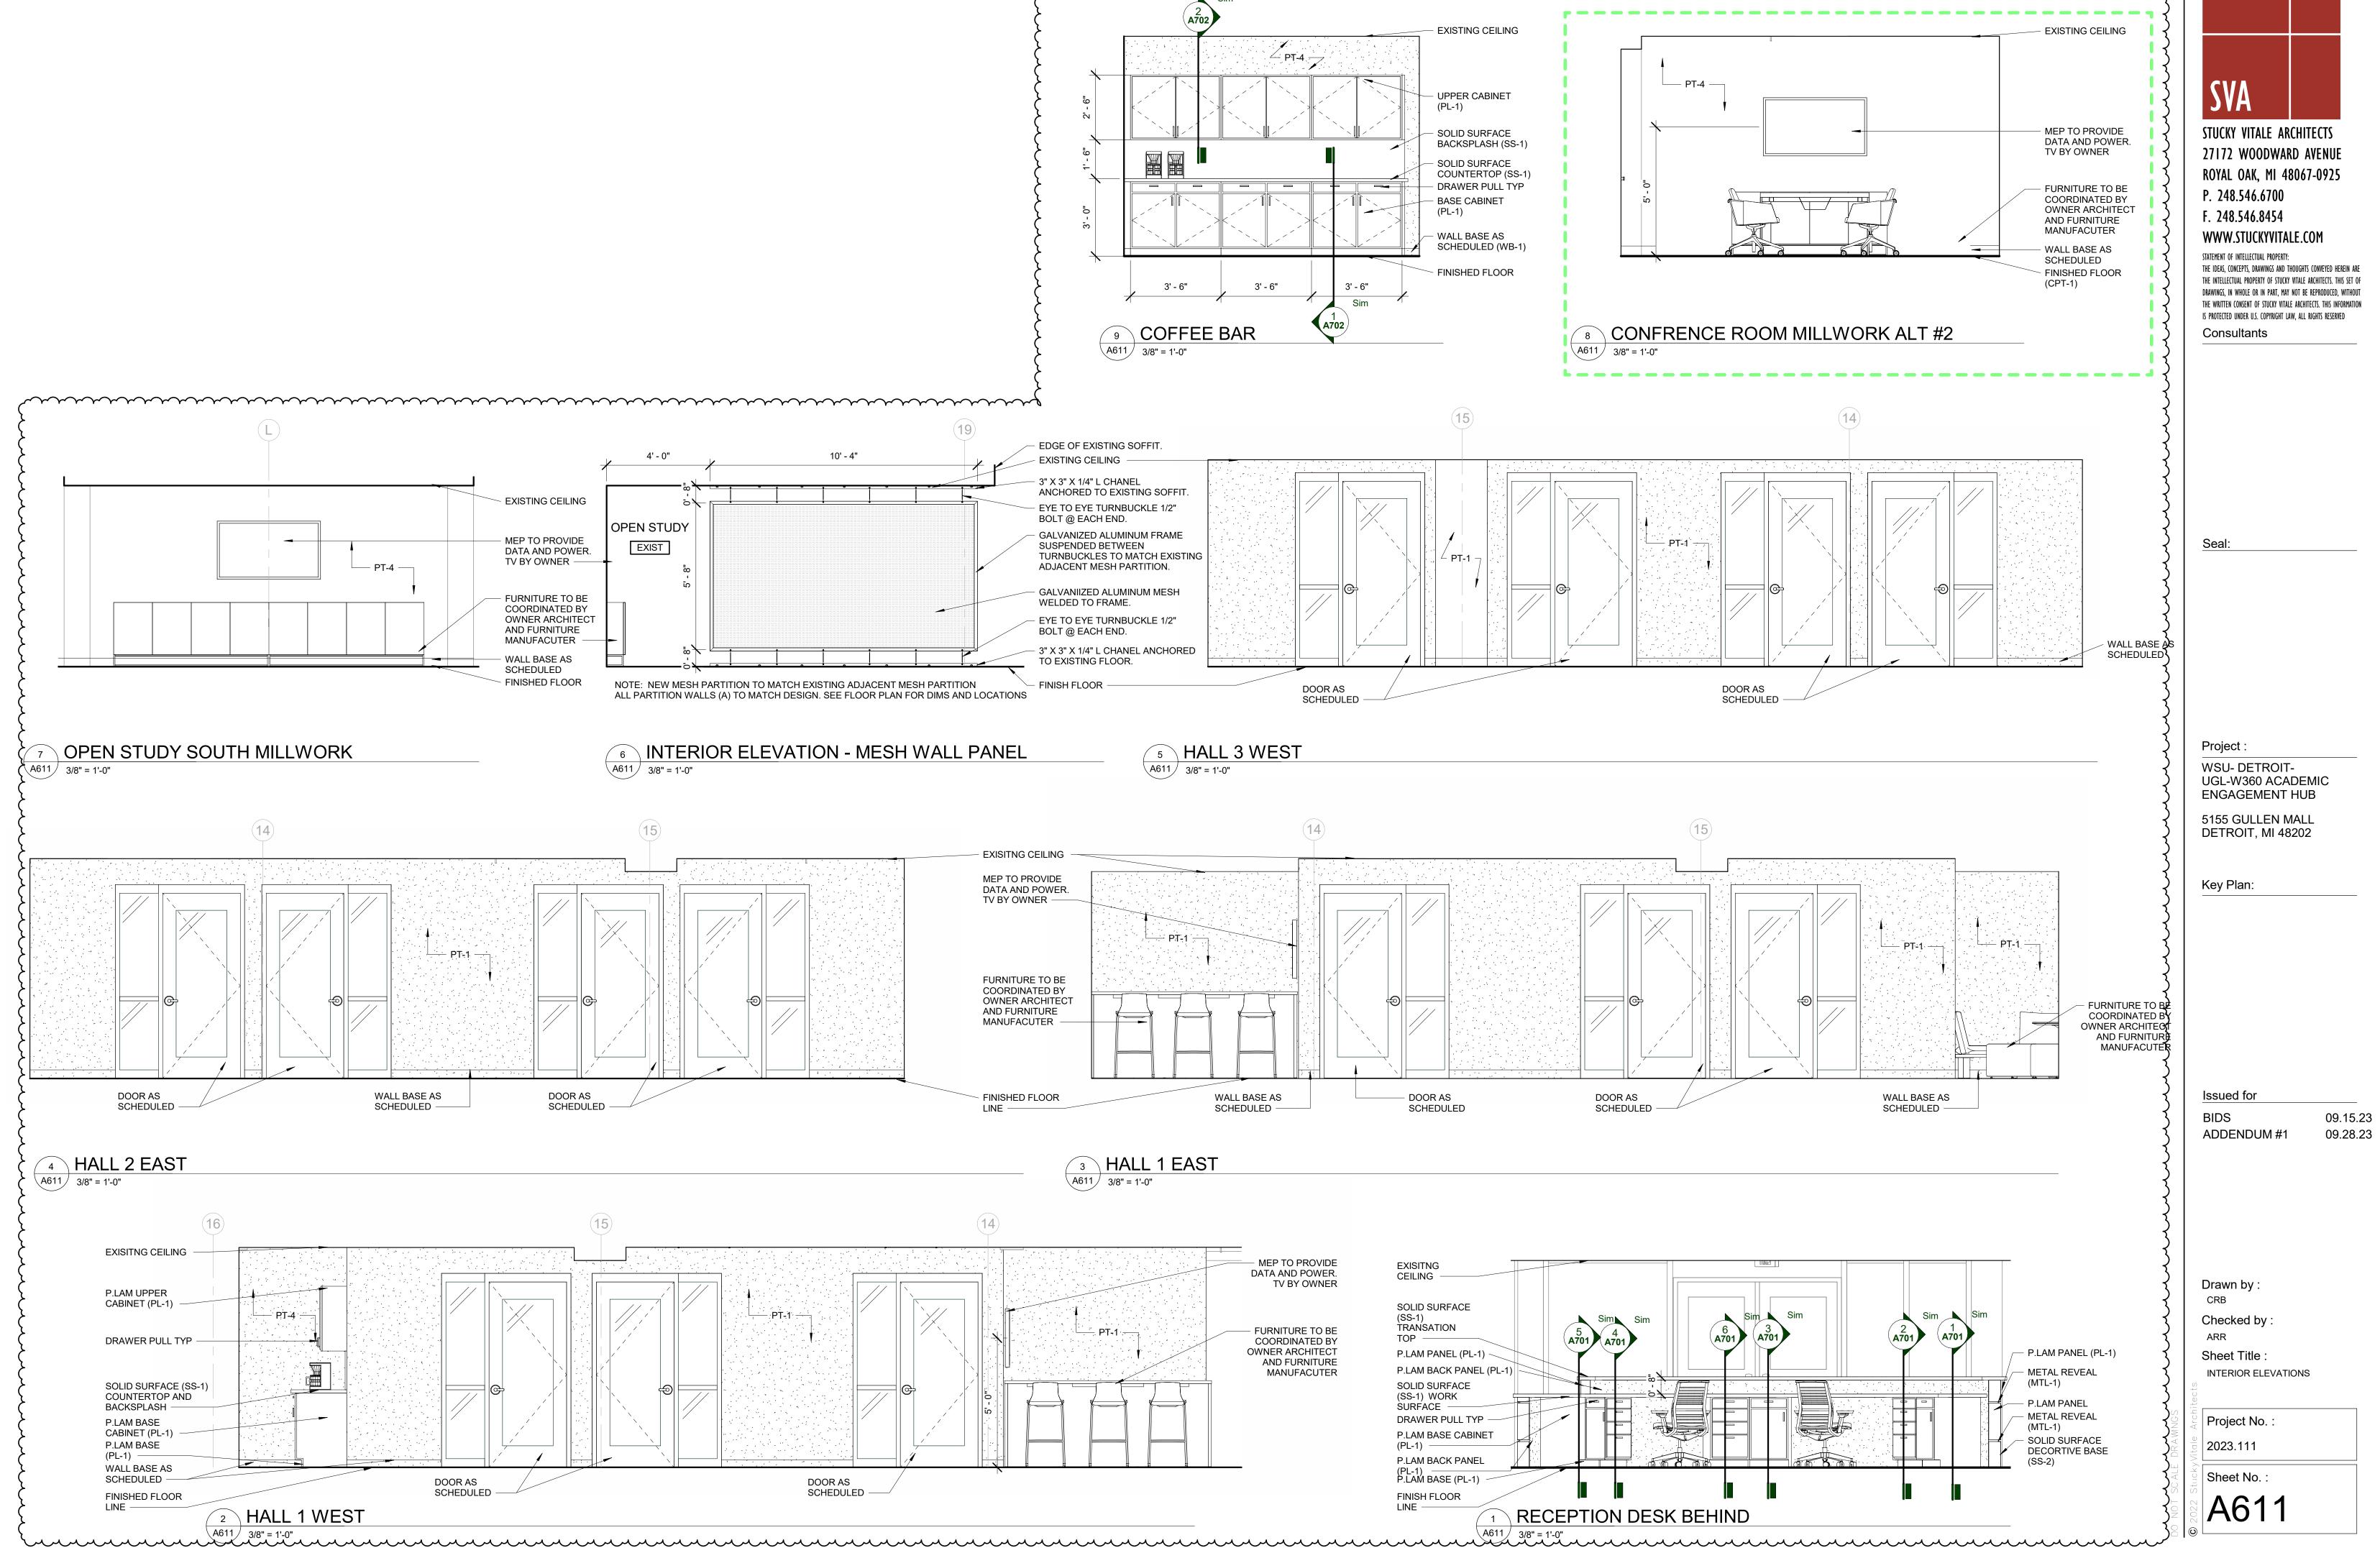
Sheet Title :
INTERIOR ELEVATIONS

Project No. :

2023.111


Sheet No. :

A610







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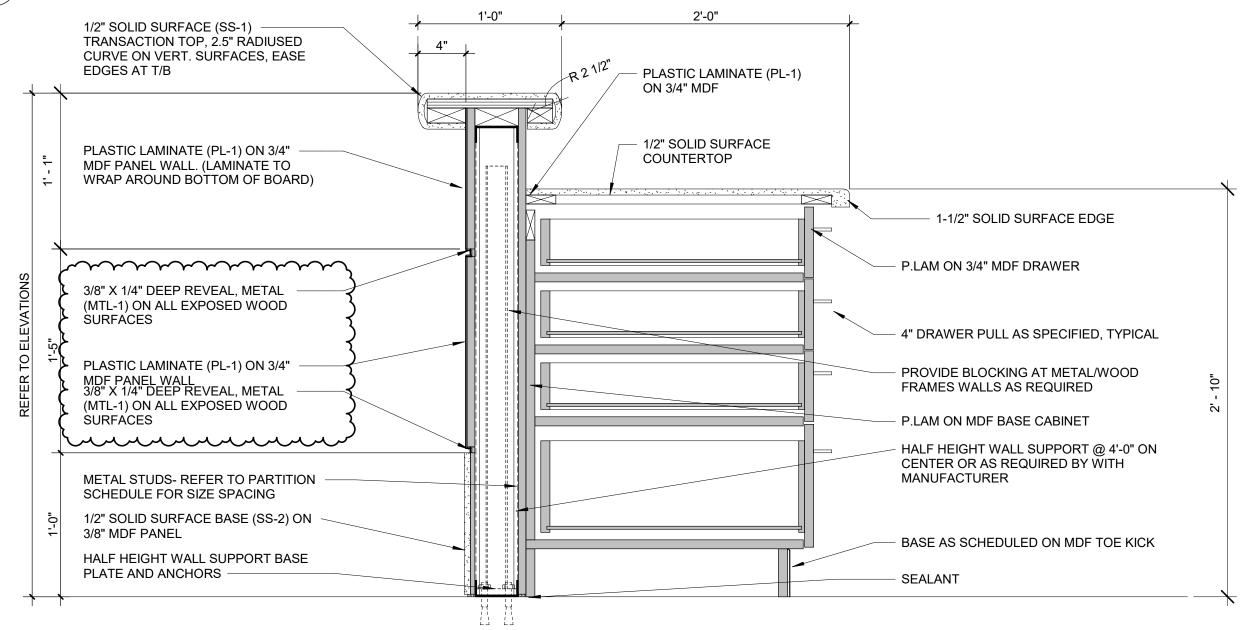
6 WORK SURFACE / ADA COUNTER - SOLID SURFACE A701 1 1/2" = 1'-0"

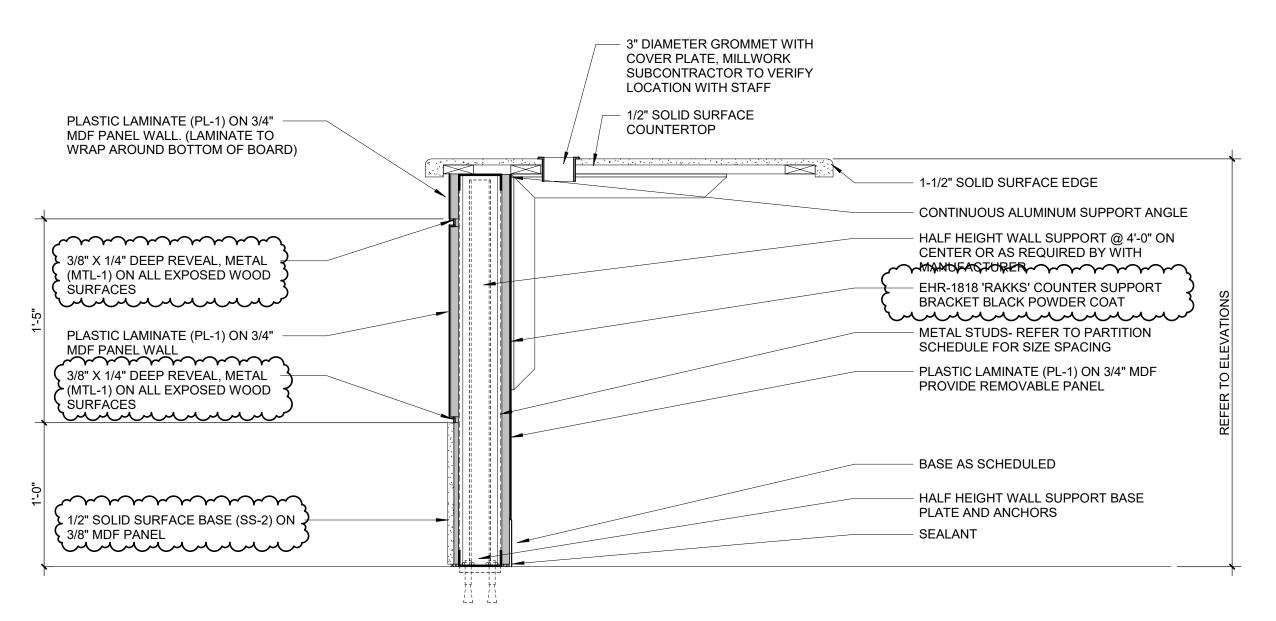A701 1 1/2" = 1'-0"




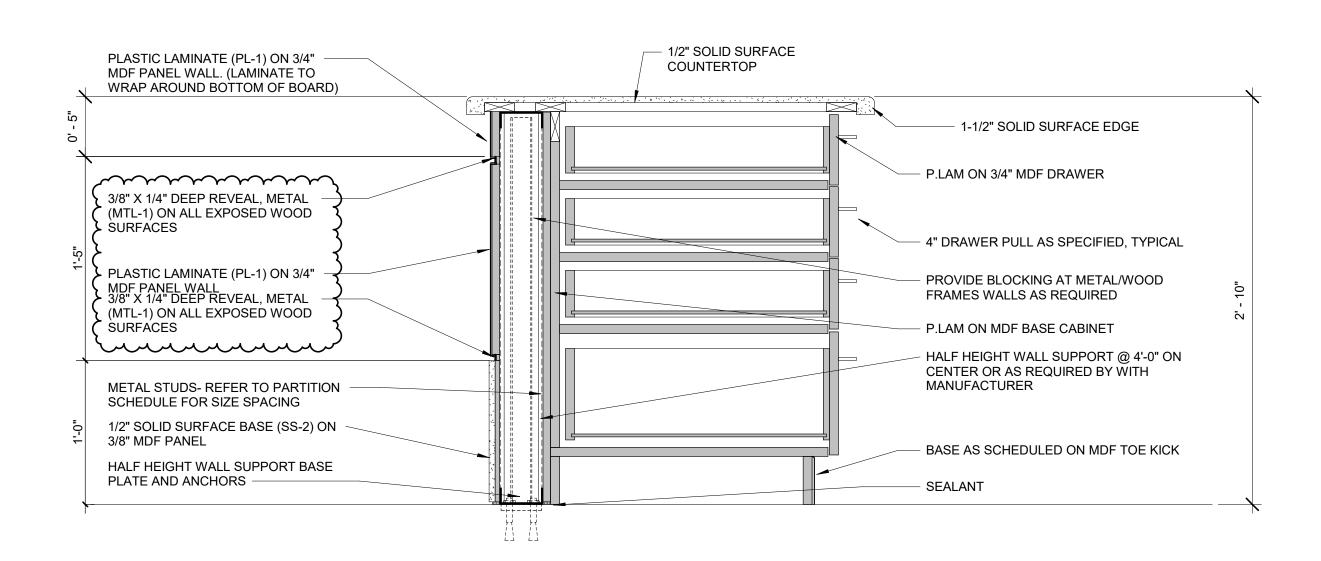

2' - 10" 1/2" SOLID SURFACE PLASTIC LAMINATE (PL-1) ON 3/4" COUNTERTOP MDF PANEL WALL. (LAMINATE TO WRAP AROUND BOTTOM OF BOARD) - 1-1/2" SOLID SURFACE EDGE - 4" DRAWER PULL AS SPECIFIED, TYPICAL 3/8" X 1/4" DEEP REVEAL, METAL - P.LAM ON 3/4" MDF DRAWER (MTL-1) ON ALL EXPOSED WOOD - 4" DOOR PULL AS SPECIFIED, TYPICAL PLASTIC LAMINATE (PL-1) ON 3/4" PROVIDE BLOCKING AT METAL/WOOD MDF PANEL WALL 3/8" X 1/4" DEEP REVEAL, METAL FRAMES WALLS AS REQUIRED (MTL-1) ON ALL EXPOSED WOOD SURFÁCES - P.LAM ON MDF BASE CABINET P.LAM ON 3/4" ADJUSTABLE MDF SHELF METAL STUDS- REFER TO PARTITION P.LAM ON 3/4" MDF DOOR SCHEDULE FOR SIZE SPACING 1/2" SOLID SURFACE BASE (SS-2) ON 3/8" MDF PANEL BASE AS SCHEDULED ON MDF TOE KICK HALF HEIGHT WALL SUPPORT BASE PLATE AND ANCHORS -HALF HEIGHT WALL SUPPORT @ 4'-0" ON CENTER OR AS REQUIRED BY WITH MANUFACTURER BASE CABINET / ADA COUNTER - SOLID SURFACE **SEALANT** A701 1 1/2" = 1'-0" 1/2" SOLID SURFACE (SS-1) TRANSACTION TOP. 2.5" RÁDIUSED

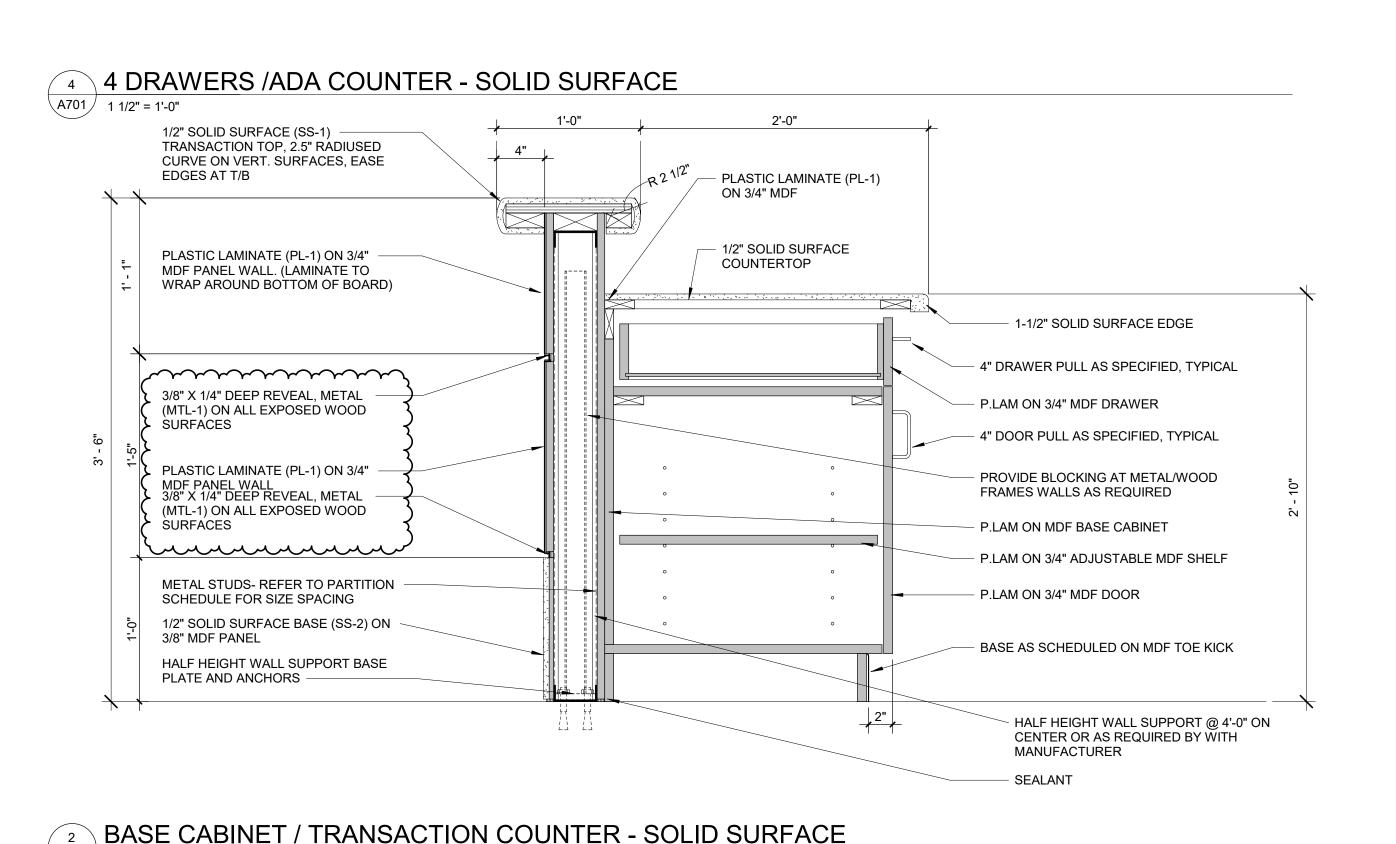

3 4 DRAWERS / TRANSACTION COUNTER - SOLID SURFACE

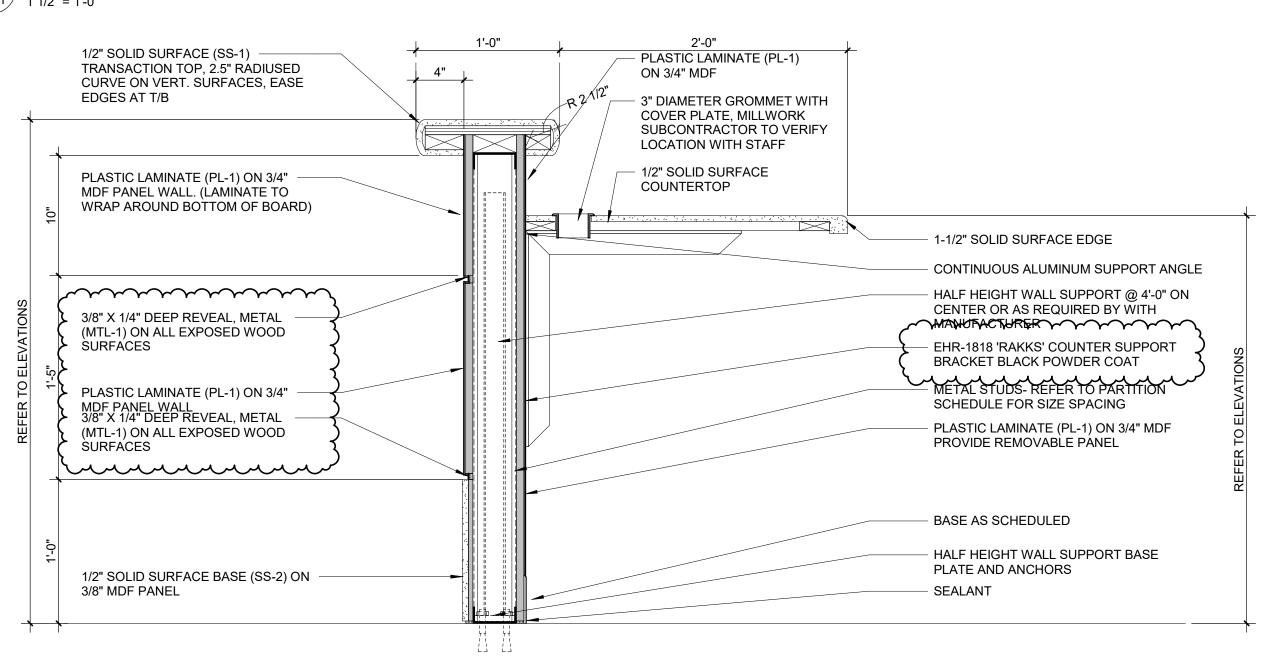

WORK SURFACE / TRANSACTION COUNTER - SOLID SURFACE

A701 1 1/2" = 1'-0"



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Key Plan:

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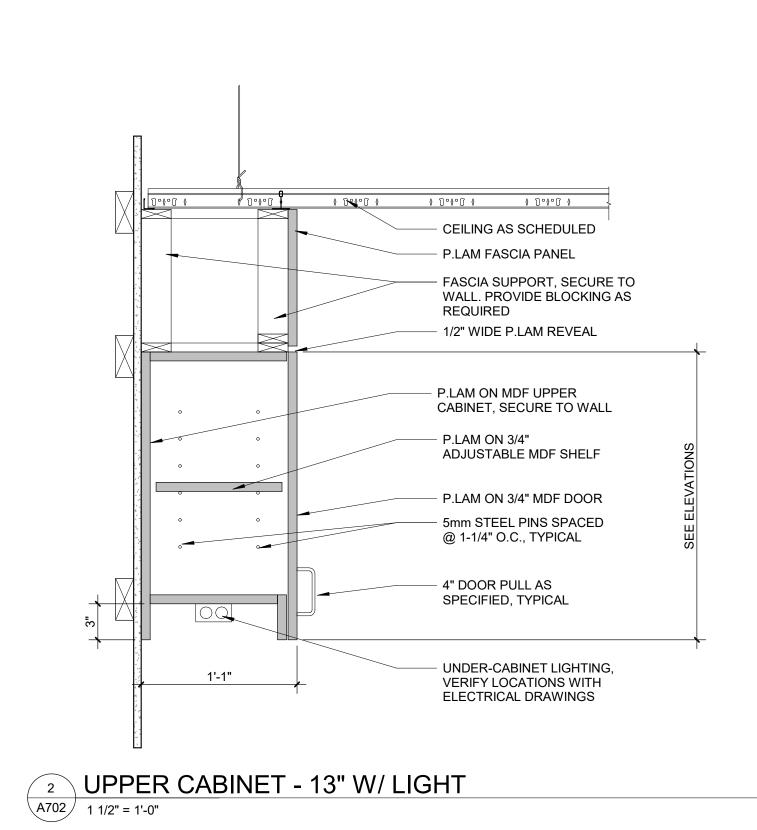
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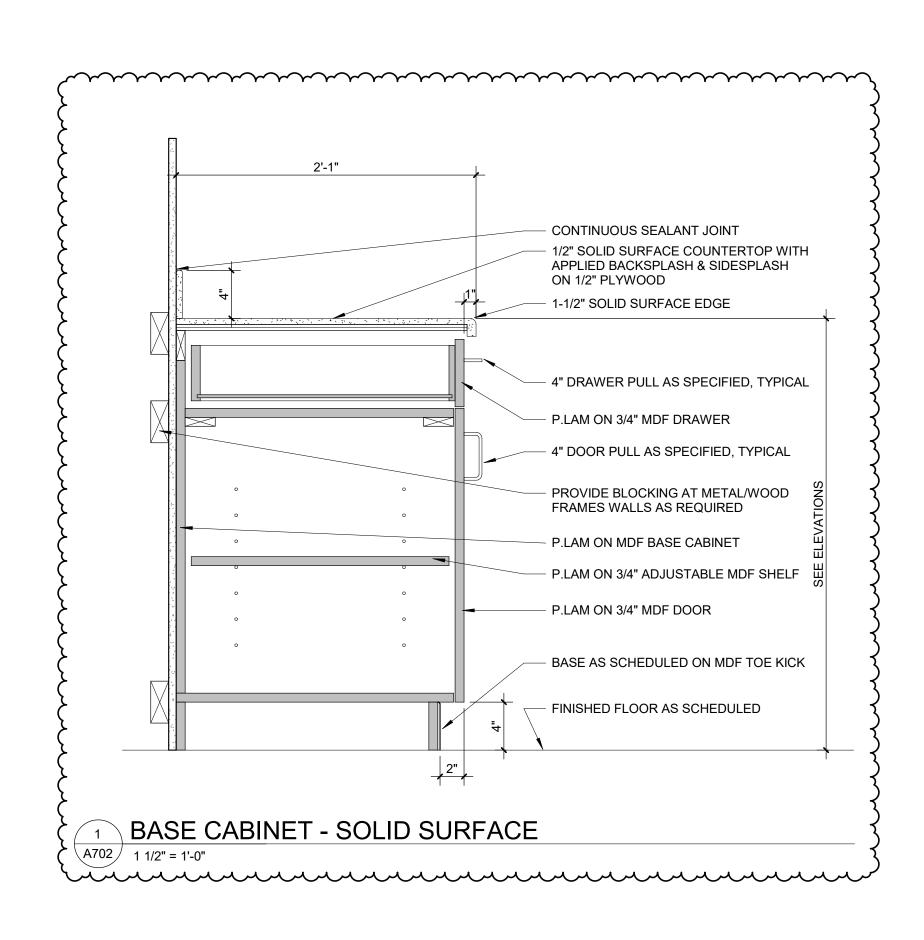
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A701





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A702

				LIMIO	I SCHEDULI			
WALL PAINT								
ROOM NAME	FLOOR FINISH	BASE FINISH	NORTH WALL	EAST WALL	SOUTH WALL	WEST WALL	CEILING FINISH	REMARKS
ENTRY	EXISTING	EXISTING	EXISTING	EXISTING	EXISTING	EXISTING	ACT-1 PT-3	
HALL	EXISTING	WB-1	PT-4 SS-1	PT-4	PT-1	PT-4	ACT-1 PT-3	
HALL	EXISTING	WB-1	PT-1	PT-1	PT-1	PT-1	ACT-1 PT-3	
HALL	EXISTING	WB-1	PT-1	PT-1	PT-1	PT-1	ACT-1 PT-3	
FORMAL STUDY	EXISTING	WB-1	PT-1	PT-1	PT-4	PT-1	ACT-1 PT-3	
OFFICE	CPT-1	WB-1	PT-1	PT-1	PT-1	PT-5	ACT-1	
OFFICE	CPT-1	WB-1	PT-1	PT-5	PT-1	PT-1	ACT-1	
OFFICE	CPT-1	WB-1	PT-1	PT-1	PT-1	PT-5	ACT-1 PT-3	
OFFICE	CPT-1	WB-1	PT-1	PT-5	PT-1	PT-1	ACT-1 PT-3	
OFFICE	CPT-1	WB-1	PT-1	PT-1	PT-1	PT-5	ACT-1	
OFFICE	CPT-1	WB-1	PT-1	PT-5	PT-1	PT-1	ACT-1	
OFFICE	CPT-1	WB-1	PT-1	PT-1	PT-1	PT-5	ACT-1	
OFFICE	CPT-1	WB-1	PT-1	PT-5	PT-1	PT-1	ACT-1	
OFFICE	CPT-1	WB-1	PT-1	PT-1	PT-1	PT-5	ACT-1	
OFFICE	CPT-1	WB-1	PT-1	PT-5	PT-1	PT-1	ACT-1	
OFFICE	CPT-1	WB-1	PT-1	PT-1	PT-1	PT-5	ACT-1 PT-3	
OFFICE	CPT-1	WB-1	PT-1	PT-5	PT-1	PT-1	ACT-1 PT-3	
OFFICE	CPT-1	WB-1	PT-1	PT-1	PT-1	PT-5	ACT-1	
OFFICE	CPT-1	WB-1	PT-1	PT-5	PT-1	PT-1	ACT-1	
CONFRENCE ROOM	CPT-1	WB-1	PT-1	PT-4	PT-1	PT-1	ACT-1 PT-3	
OPEN STUDY	EXISTING	EXISTING	PT-1	PT-1	PT-1	PT-1	ACT-1 PT-3	PT-1 ONLY NEW WALLS UNLESS EXISTING WALLS NEED TO BE CLEANED OR REPAIRED
OPEN STUDY	EXISTING	EXISTING	EXISTING	EXISTING	EXISTING	EXISTING	ACT-1 PT-3	
VESTIBULE	EXISTING	WB-1	PT-1	PT-1	PT-1	PT-1	ACT-1 PT-3	
STORAGE	EXISTING	EXISTING	EXISTING	EXISTING	EXISTING	EXISTING	EXISTING	
MENS TR	EXISTING	EXISTING	EXISTING	EXISTING	EXISTING	EXISTING	EXISTING	
WOMEN'S TR	EXISTING	EXISTING	EXISTING	EXISTING	EXISTING	EXISTING	EXISTING	
	HALL HALL HALL FORMAL STUDY OFFICE	HALL EXISTING HALL EXISTING HALL EXISTING FORMAL STUDY EXISTING OFFICE CPT-1 CONFRENCE ROOM CPT-1 OPEN STUDY EXISTING VESTIBULE EXISTING STORAGE EXISTING MENS TR EXISTING	HALL EXISTING WB-1 HALL EXISTING WB-1 HALL EXISTING WB-1 FORMAL STUDY EXISTING WB-1 OFFICE CPT-1 WB-1	HALL EXISTING WB-1 PT-4 SS-1 HALL EXISTING WB-1 PT-1 HALL EXISTING WB-1 PT-1 FORMAL STUDY EXISTING WB-1 PT-1 OFFICE CPT-1 WB-1 PT-1 OFFICE CP	HALL EXISTING WB-1 PT-4 SS-1 PT-4 HALL EXISTING WB-1 PT-1 PT-1 HALL EXISTING WB-1 PT-1 PT-1 FORMAL STUDY EXISTING WB-1 PT-1 PT-1 FORMAL STUDY EXISTING WB-1 PT-1 PT-1 OFFICE CPT-1 WB-1 PT-1 PT-1 OFFICE CPT-1 WB-1 PT-1 PT-5 OFFICE CPT-1 WB-1 PT-1 PT-1 OFFICE CPT-1 WB-1 PT-1 PT-1 OFFICE CPT-1 WB-1 PT-1 PT-1 OFFICE CPT-1 WB-1 PT-1 PT-5 OFFICE CPT-1 WB-1 PT-1 PT-1 OFFICE CPT-1 WB-1 PT-1 PT-5 OFFICE CPT-1 WB-1 PT-1 PT-5 OFFICE CPT-1 WB-1 PT-1 PT-1 OFFICE	HALL EXISTING WB-1 PT-4 SS-1 PT-4 PT-1 HALL EXISTING WB-1 PT-1 PT-1 PT-1 HALL EXISTING WB-1 PT-1 PT-1 PT-1 FORMAL STUDY EXISTING WB-1 PT-1 PT-1 PT-1 OFFICE CPT-1 WB-1 PT-1 PT-1 PT-1 OFFICE CPT-1 WB-1 PT-1 PT-5 PT-1 OFFICE CPT-1 WB-1 PT-1 PT-5 PT-1 OFFICE CPT-1 WB-1 PT-1 PT-1 PT-1 PT-1 OFFICE CPT-1 WB-1 PT-1 P	HALL EXISTING WB-1 PT-4 SS-1 PT-4 PT-1 PT-1 HALL EXISTING WB-1 PT-1 PT-1	HALL EXISTING WB-1 PT-4 SS-1 PT-4 PT-1 PT-4 ACT-1 PT-3 HALL EXISTING WB-1 PT-1 PT-1<

 \mathcal{A}

TOTAL ROOMS: 26

LIST OF I	MAT	ERIALS
064100 - ARCHITECTURAL CASEWORK	099	100 - PAINT
PL-1 PLASTIC LAMINATE MANUFACTURER: WILSONART COLOR: FISHER OAK TEXTURE: ALIGNED LOCATION: RECEPTION DESK AND CABINETS CONTACT: NOTE: AEON SCRATCH RESISTANCE ANTIMICROBIAL PROTECTION	PT-1	INTERIOR FIELD PAINT MANUFACTURER: SHERWIN WILLIAMS COLOR: MATCH EXISITNG FINISH: EGG-SHELL LOCATION: THROUGHT OUT SCOPE UNLESS NOTED OTHERWISE ON FINISH SCHEDULED NOTE: CLEAN, REPAIR AND REPAINT
METAL SHEET MANUFACTURER: FORMICA PATTERN: M9420-99 LIGHT ROLLED SHEET COLOR: ACIER LAMINE CLAIR LOCATION: RECEPTION DESK REVEALS	PT-2	DOOR FRAME PAINT & DOOR MANUFACTURER: SHERWIN WILLIAMS COLOR: MATCH EXISITING FINISH: SEMI-GLOSS LOCATION: ONLY WHERE NEEDED, REPAIR, CLEAN AND REPAINT
CONTACT: NOTE: SS-2 SOLID SSURFACE	PT-3	CEILING PAINT MANUFACTURER: SHERWIN WILLIAMS COLOR: MATCH EXISTING FINISH: FLAT LOCATION: SOFFITS
MANUFACTURER: AVONITE COLOR: CANARY F1-7554 FINISH: SATIN LOCATION: RECEPTION BASE CONTACT:	PT-4	NOTE: CLEAN, REPAIR AND REPAINT ACCENT PAINT- WSU GREEN MANUFACTURER: SHERWIN WILLIAMS
- PULLS MANUFACTURER: RICHELIEU		PANTON: 561 C RGB- 12 84 73 FINISH: EGG-SHELL LOCATION: REFER TO FINISH PLAN FOR EXACT LOCATION
STYLE: CONTEMPORARY METAL EDGE PULL PRODUCT NUMBER: BP9696128170 FINISH: STAINLESS STEEL LENGTH: 5 13/16" OVERALL LOCATION: CABINETS AND DRAWERS	PT-5	ACCENT PAINT- WSU GOLD MANUFACTURER: SHERWIN WILLIAMS PANTON: 1225 C RGB- 255 204 51 FINISH: EGG-SHELL
095100 - SUSPENDED ACOUSTICAL CEILING		LOCATION: REFER TO FINISH PLAN FOR EXACT LOCATION
ACOUSTIC CEILING TILE MANUFACTURER: MATCH EXISITNG COLLECTION: COLOR: WHITE SIZE: 2 X 2 EDGE: MATCH EXISITNG GRID PROFILE: KEEP EXISTING LOCATION: SEE RCP FOR MORE DETAIL	123 SS-1	SOLID SSURFACE MANUFACTURER: WILSONART COLOR: MORNING ICE 9204CE LOCATION: RECEPTION AND CABINETS CONTACT:
NOTE: WHEN EXISTING GRID IS PRESENT, MATCH WHEN POSSIBLE. CEILING TILE SHOULD BE SAVED AND MATCH EXISING WHERE DAMAGED. CLEAN AND REPAIR WHERE	2600	00 - ELECTRICAL
POSSIBLE	-	FACE PLATES
096000 - CONTRACT FLOORING	-	DEVICES COLOR: WHITE
CARPET TILE MANUFACTURER: PATCRAFT COLLECTION:RISE STYLE: 10465 COLOR: PATH SIZE: 12 X 45 LOCATION: OFFICES AND CONFRENCE ROOM ONLY CONTACT: NOTE: ALT OPTION		
TRANSITION STRIP MANUFACTURER: PATCRAFT STYLE: S142V COLOR: 00066 SLATE LOCATION: WHERE NEW CARPET AND EXISTING CARPET MEET		
VB-1 RUBBER WALL BASE MANUFACTURER: MATCH EXISTING COLOR: MATCH EXISTING SIZE: 4 1/4"h, 1/4" THICK (USE 8' LENGTHS, NOT COIL) LOCATION: WHERE NEW CARPET NOTED CONTACT: NOTE: CLEAN, REPAIR OR REPLACE EXISITNG WHERE NEEDED		

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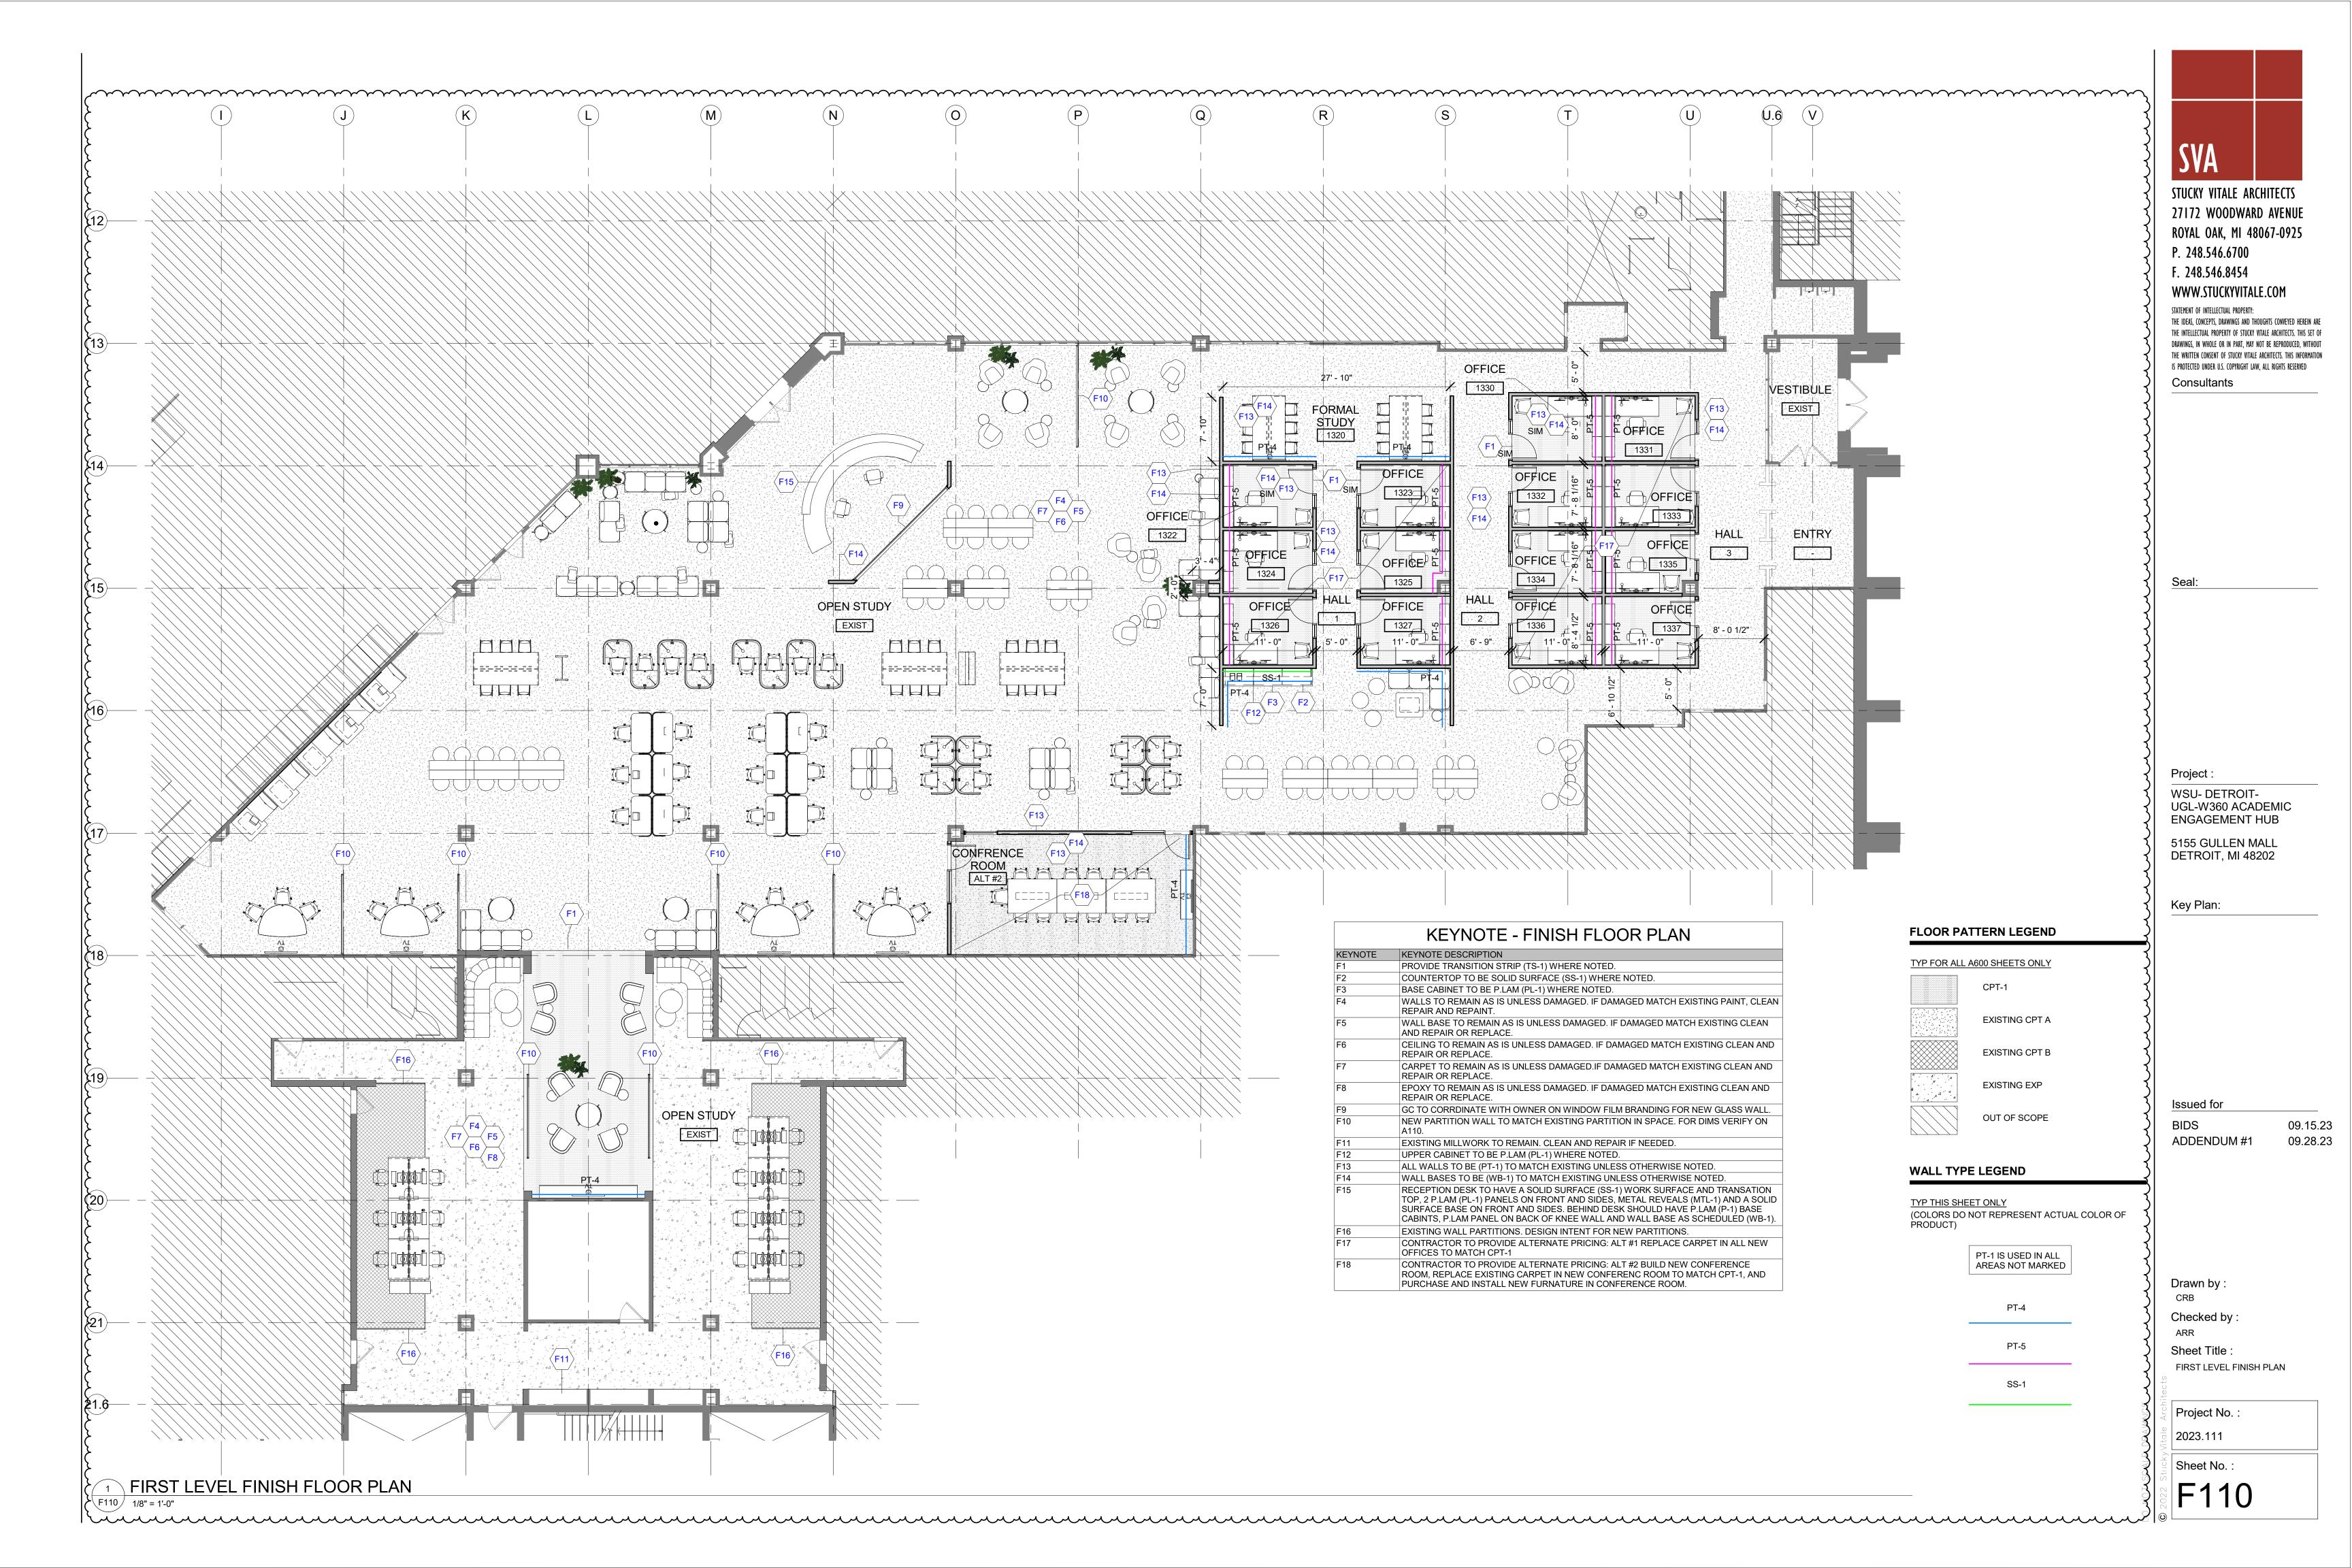
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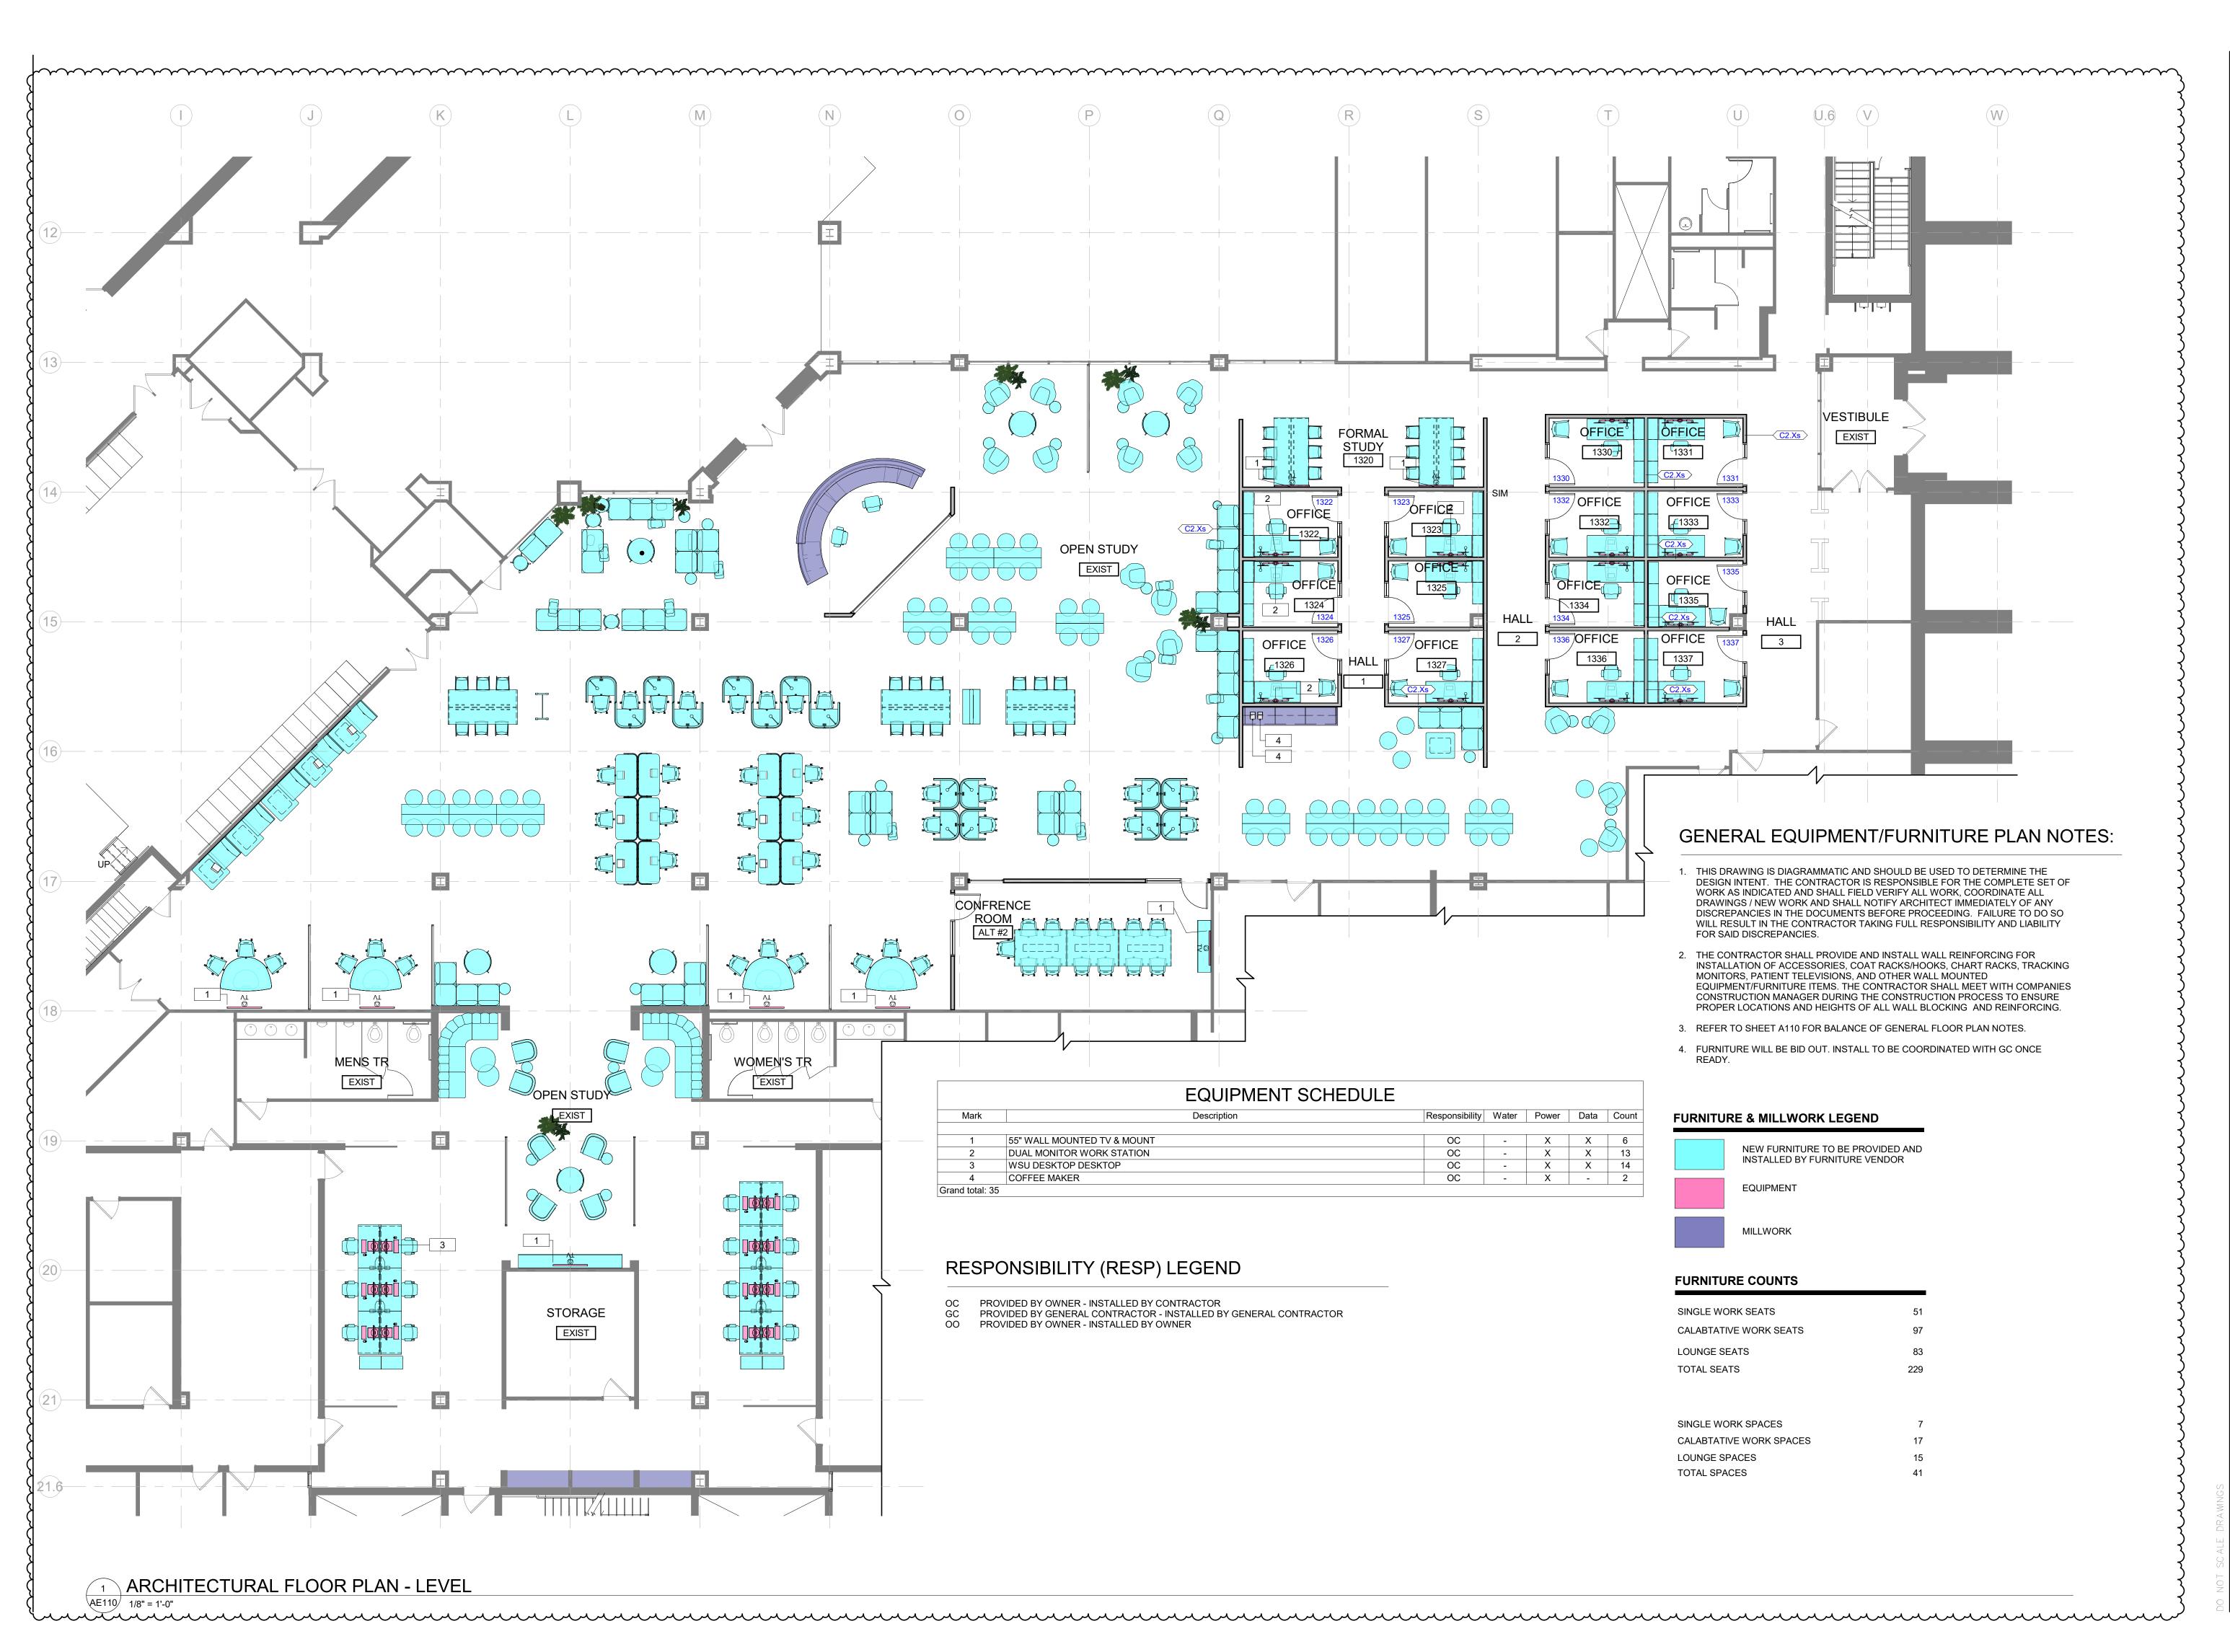
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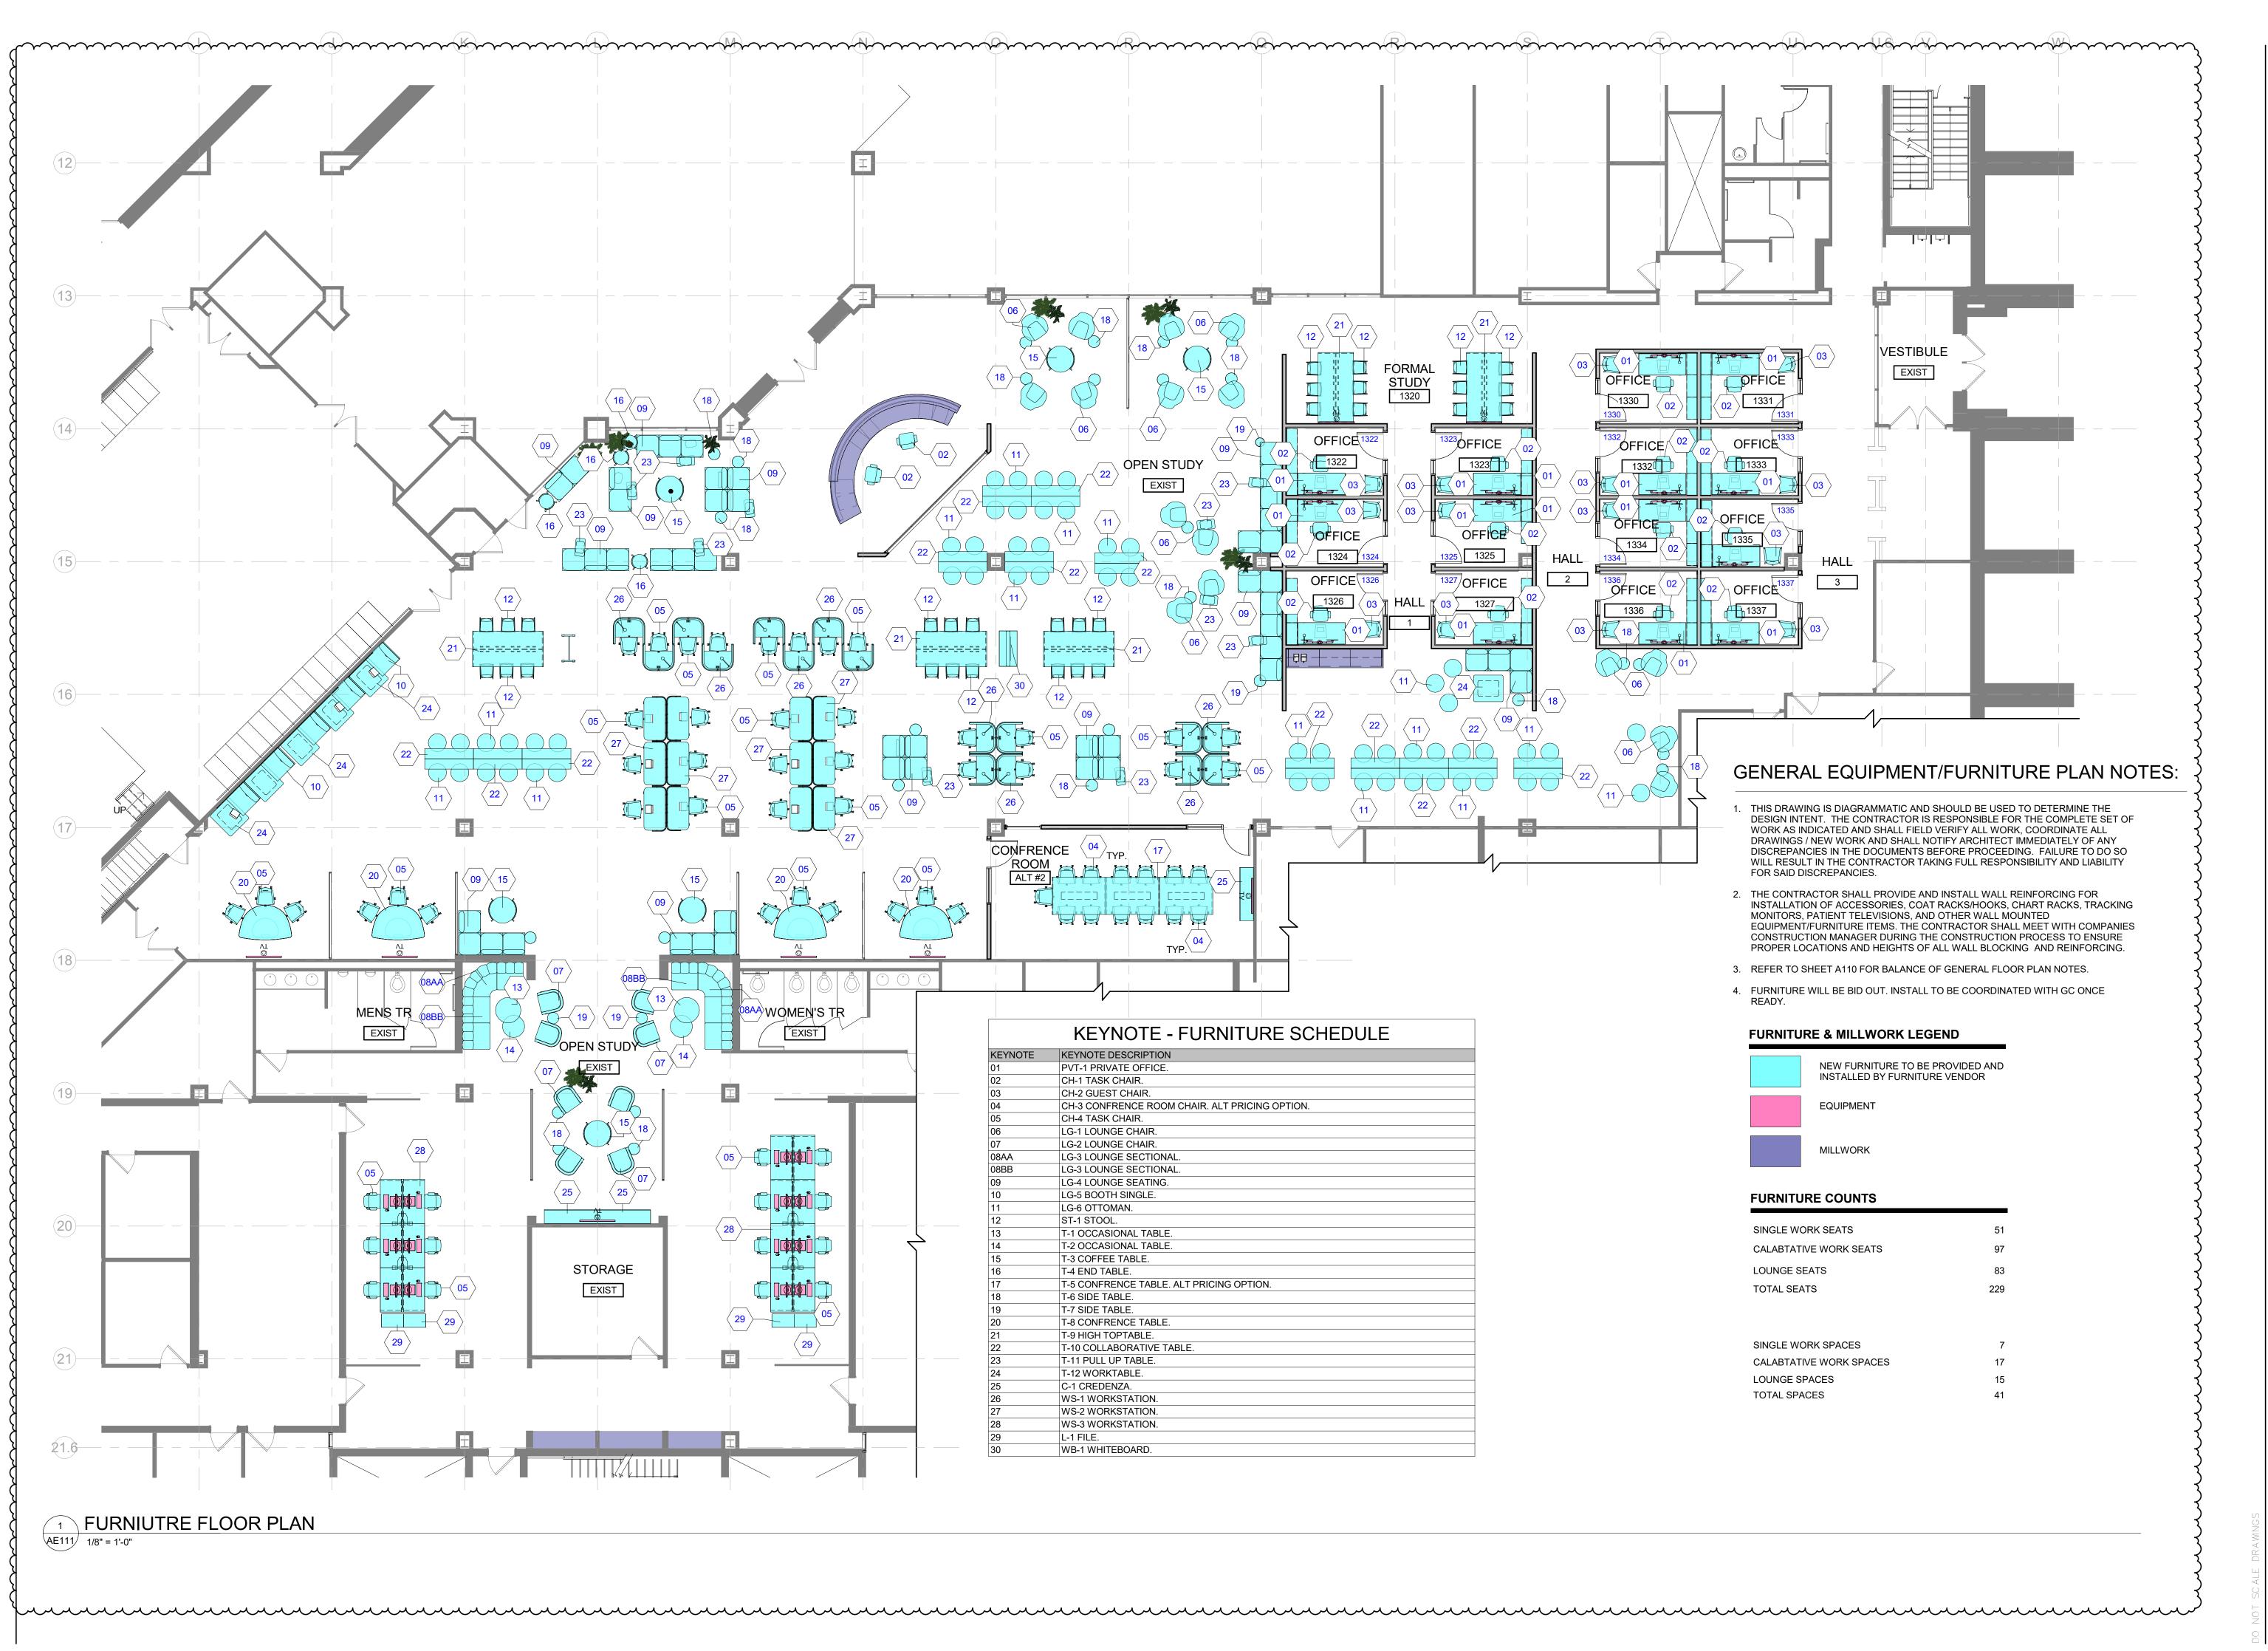
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Sheet Title:

FIRST LEVEL EQUIPMENT PLAN

2023.111

Sheet No. : **AE11**(





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 FURNITURE BIDS
 09.19.23

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Drawn by : CRB
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Sheet Title:
FIRST LEVEL FURNITURE PLAN

Project No. :

Project No 2023.111

Sheet No. :

<u>ABBREVIATIONS</u>

		F	FAHRENHEIT
ACCU	AIR CONDITIONING CONDENSING UNIT	, FD	FLOOR DRAIN
AD	ACCESS DOOR ABOVE FINISHED FLOOR	FLR	FLOOR
AFF AHU	AIR HANDLING UNIT	FPM	FEET PER MINUTE
AP	ACCESS PANEL	FSW	FLOW SWITCH
ASR	AUTOMATIC SPRINKLER RISER	FS	FLOOR SINK
A3N	ACTOMATIC SI KINKEEK KISEK	FT.	FEET
BTU	BRITISH THERMAL UNIT	GPM	GALLONS PER MINUTE
СС	COOLING COIL		
CF	CENTRIFUGAL FAN	НВ	HOSE BIBB
CFM	CUBIC FEET PER MINUTE	НО	HUB OUTLET
CI	CAST IRON	HP	HORSEPOWER
CO	CLEAN OUT	HW	HOT WATER (POTABLE)
COND	CONDENSATE	HWR	HOT WATER RETURN (POTABLE)
CONT	CONTINUATION	IN	INCHES
CUH	CABINET UNIT HEATER	INL	INLET
CW	COLD WATER	INV	INVERT
CWS	CHILLED WATER SUPPLY		IIIV LIXI
CWR	CHILLED WATER RETURN	LAT	LEAVING AIR TEMPERATURE
		LAV	LAVATORY
Db	DRY BULB TEMPERATURE, °F	LBS/HR	POUNDS PER HOUR
dB	DECIBELS	LWT	LEAVING WATER TEMPERATURE
DDC	DIRECT DIGITAL CONTROL		
DET	DETAIL	MAX.	MAXIMUM
DIA	DIAMETER	мвн	1000 BTU/HR
DN.	DOWN	MECH	MECHANICAL
DS	DOWNSPOUT	MIN.	MINIMUM
DWG.	DRAWING	MISC	MISCELLANEOUS
EA	EXHAUST AIR	NC	NORMALLY CLOSED
ECUH	ELECTRIC CABINET UNIT HEATER	NIC	NOT IN CONTRACT
EF	EXHAUST FAN	NO	NORMALLY OPEN
ELEV.	ELEVATION	NOM.	NOMINAL
ESP EUH	EXTERNAL STATIC PRESSURE ELECTRIC UNIT HEATER	NFWH	NON FREEZE WALL HYDRANT
EX.	EXISTING	OA	OUTSIDE AIR
		0.5	OVEDEL OW

NFWH	NON FREEZE WALL HYDRANT	v
OA	OUTSIDE AIR	, VTR
OF	OVERFLOW	
OFD	OVERFLOW DRAIN	W
		WG
		WH

PRESSURE DROP (FEET OF WATER)

POUNDS PER SQUARE INCH

PRESSURE REDUCING VALVE

ROOF DRAIN/STAND PIPE

RETURN AIR

REHEAT COIL

ROOF SUMP

REBALANCE

SUPPLY AIR SANITARY WASTE SMOKE DETECTOR SUPPLY FAN SPECIFIC GRAVITY

STAND PIPE SPRINKLER

STACK

TYPICAL

VALVE

WASTE WATER GAUGE

SPRINKLER STANDPIPE STATIC PRESSURE SENSOR

TOTAL PRESSURE

UNIT HEATER

VENT THRU ROOF

WALL HYDRANT

UNLESS OTHERWISE NOTED

RAIN CONDUCTOR RELOCATED

RELATIVE HUMIDITY

REVOLUTIONS PER MINUTE

STATIC PRESSURE (INCHES OF WATER)

BALANCE

RETURN RETURN FAN

RD/SP

STK

GENERAL HVAC NOTES:

EXHAUST

EXISTING

EXH

EXIST

THE FOLLOWING NOTES APPLY TO ALL HVAC DRAWINGS, EXCEPT WHERE OTHERWISE

WHEREVER VOLUME DAMPERS OCCUR ABOVE CEILINGS WITHOUT REMOVABLE TILE AND AN ACCESS PANEL IS NOT FURNISHED, PROVIDE AN EXPOSED DAMPER REGULATOR TO ALLOW DAMPER ADJUSTMENT FROM BELOW CEILING.

UNIT TO BE EQUAL TO VENTLOCK No. 666 IN 1/2"x3/8" SIZE.

- 2. ALL DIMENSION SHOWN FOR DUCTWORK ARE NET INSIDE DIMENSIONS.
- 3. DIFFUSER AND REGISTER LOCATIONS SHALL BE COORDINATED WITH ARCHITECTURAL REFLECTED CEILING PLAN.
- 4. THOUGH SOME OFFSETS & TRANSITIONS ARE SHOWN IN PIPING AND SHEET METAL TO HELP INDICATE THE PHYSICAL RELATIONSHIP BETWEEN THEM. IT IS NOT THE INTENT OF THE DRAWINGS TO SHOW ALL PIPING AND SHEET METAL OFFSET & TRANSITIONS REQUIRED. THE CONTRACTOR SHALL FULLY COORDINATE THE MECHANICAL WORK WITHIN ITSELF AND WITH THE WORK OF ALL TRADES TO PROVIDE COMPLETE AND OPERABLE SYSTEMS WITHOUT INTERFERENCES.
- 5. DUCT PRESSURE CONSTRUCTION CLASSIFICATION SHALL BE AS SPECIFIED.
- 6. ALL ROUND RUNOUTS AND DROPS TO DIFFUSERS SHALL BE SAME NOMINAL SIZE AS INDICATED ON THE DRAWINGS.
- 7. ALL PIPING AND DUCTS IN FINISHED ROOMS OR SPACES SHALL BE CONCEALED IN FURRED CHASE OR SUSPENDED CEILING.
- 8. ACCESS PANELS AND DOORS ARE REQUIRED THROUGH BUILDING CONSTRUCTION ASSEMBLIES SUCH AS WALLS, CEILING, PARTITONS AND FLOORS TO SERVICE AND MAINTAIN DAMPERS, CONTROL MOTORS, REGULATORS, VALVES, FLEXIBLE DUCT CONNECTIONS AND OTHER ITEMS OR DEVICES INCORPORATED IN MECHANICAL WORK. SUCH PANELS AND DOORS SHALL BE PROVIDED AND INSTALLED UNDER THE ARCHITECTURAL SPECIFICATIONS. MECHANICAL CONTRACTOR SHALL COORDINATE LOCATION OF ACESS DOORS AND PANELS AND VERIFY THE EXACT QUANTITY, SIZE, FIRE-RATING AND LOCATION AFTER THE SYSTEMS AND EQUIPMENT REQUIRING ACCESS HAVE BEEN INSTALLED AND PRIOR TO THE CLOSURE OF THE AFFECTED CEILING AND BUILDING ASSEMBLIES. MINIMUM ACCESS PANEL AND DOOR SIZE SHALL BE 24 INCHES BY 18 INCHES UNLESS OTHERWISE NOTED.
- 9. ALL DUCTWORK PENETRATIONS THROUGH FIRE—RATED WALLS AND FLOORS SHALL BE PROVIDED WITH FIRE DAMPERS AND ACCESS DOOR.

PLUMBING, PIPING & FIRE PROTECTION

EXISTING WORK NEW WORK ISOLATION VALVE CHECK VALVE WATER FLOW SWITCH VALVE IN RISER VENT PIPING STRAINER ALIGNMENT GUIDE ALIGNMENT GUIDE SPRINKLER HEAD (PENDANT) SPRINKLER HEAD (UPRIGHT) SPRINKLER HEAD (UPRIGHT) WCC CLEANOUT FLOOR FCO CLEANOUT FLOOR WCC CLEANOUT GRADE WCC CLEANOUT GRADE FLOOR DRAIN (FD) FLOOR DRAIN (FD) REDUCER - CONCENTRIC FIRE SPRINKLER PIPING WATER FLUW SWITCH HOT WATER PIPING VENT PIPING SANITARY LINE (UNDERGOUND) STEAM SANITARY LINE (AVOVE GROUND) STEAM VENT PIPING VENT PIPING VENT PIPING VENT PIPING VENT PIPING OXY OXYOF GROUND) OXYOF CONDESATE RETURN OXYOF OXY OXYGEN WATER PIPING VENT PIPING VENT PIPING OXYOF GROUND) OXYOF OXYOF GROUND) OXYOF OXYOF OXYOF GROUND) OXYOF OXYOF OXYOF GROUND) OXYOF OXYOF OXYOF OXYOF GROUND) OXYOF OXYOF OXYOF OXYOF GROUND) OXYOF OX		ITEM TO BE DEMOVED	\wedge	MANUAL AID VENT
NEW WORK ISOLATION VALVE CHECK VALVE WATER FLOW SWITCH VALVE IN RISER VALVE IN RISER VALVE IN RISER VENT PIPING STRAINER SANITARY LINE (UNDERGROUND) PIPE ANCHOR EXPANSION JOINT — SLIDING ALIGNMENT GUIDE SPRINKLER HEAD (PENDANT) SPRINKLER HEAD (UPRIGHT) SPRINKLER		ITEM TO BE REMOVED	A	MANUAL AIR VENT
ISOLATION VALVE CHECK VALVE WATER FLOW SWITCH VALVE IN RISER VALVE IN RISER VALVE IN RISER VENT PIPING STRAINER STRAINER PIPE ANCHOR EXPANSION JOINT — SLIDING ALIGNMENT GUIDE UNION SPRINKLER HEAD (PENDANT) SPRINKLER HEAD (PENDANT) CCR SPRINKLER HEAD (UPRIGHT) SPRINKLER HEAD (UPRIGHT) CCC CLEANOUT FCO CLEANOUT FCO CLEANOUT FCO CLEANOUT FCO CLEANOUT SALD FLOOR DRAIN (FD) FLOOR DRAIN (FD) FLOOR DRAIN (FD) FLOOR DRAIN (FD) FRESSURE GAUGE WITH COCK HHWS—HEATING HOT WATER RETURN CAP OR PLUG CHWS—CHWR—CHILLED HOT WATER RETURN CHILLED WATER SUPPLY FRESSURE GAUGE WITH COCK HHWR—HEATING HOT WATER RETURN CHILLED HOT WATER RETURN CHILLED WATER SUPPLY CAP OR PLUG CHENUM WATER RETURN CHILLED WATER SUPPLY CAP OR PLUG CHENUM TURNED DOWN CELBOW — TURNED DOWN CHENUM TURNED LIP THE OUTLET — DOWN			⊠	TEST PLUG (PRESSURE/TEMPERATURE)
CHECK VALVE WATER FLOW SWITCH VALVE IN RISER VALVE IN RISER VENT PIPING VALVE IN RISER VENT PIPING VALVE IN RISER VENT PIPING VENT PIPING STRAINER STRAINER STRAINER SAN SANITARY LINE (UNDERGROUND) EXPANSION JOINT - SLIDING ALIGNMENT GUIDE UNION STM STEAM SPRINKLER HEAD (PENDANT) SPRINKLER HEAD (UPRIGHT) VAC CONDESATE RETURN O SPRINKLER HEAD (UPRIGHT) VAC VACUUM FCO CLEANOUT VAC VACUUM FCO CLEANOUT FLOOR WCO CLEANOUT WALL WCO CLEANOUT WALL WCO CLEANOUT GRADE FLOOR DRAIN (FD) FLOOR DRAIN (FD) FLOOR DRAIN (FD) FRESSURE GAUGE WITH COCK HHWS HEATING HOT WATER SUPPLY THERMOMETER CAP OR PLUG CAP OR PLUG ELBOW - TURNED DOWN ELBOW - TURNED UP TEE OUTLET - DOWN				NEW CONNECTION
WATER FLOW SWITCH VALVE IN RISER VENT PIPING STRAINER PIPE ANCHOR EXPANSION JOINT - SLIDING ALIGNMENT GUIDE SPRINKLER HEAD (PENDANT) SPRINKLER HEAD (UPRIGHT) FCO CLEANOUT FCO CLEANOUT FLOOR GCO CLEANOUT WALL WCO CLEANOUT WALL FLOOR DRAIN (FD) REDUCER - CONCENTRIC F FIRE SPRINKLER PIPE (FS) HHWS HEATING HOT WATER RETURN HOT WATER PIPING HOT WATER PIPING HOT WATER PIPING HOT WATER PIPING HOT WATER RETURN PIPING VENT PIPING HOT WATER RETURN PIPING HOT WATER RETURN PIPING HOT WATER RETURN PIPING HOT WATER RETURN PIPING NANITARY LINE (UNDERGOUND) STEAM CONDESATE RETURN OXY OXY OXY OXY OXY OXY OXY OX				COLD WATER PIPING
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PIPE ANCHOR EXPANSION JOINT - SLIDING ALIGNMENT GUIDE UNION SPRINKLER HEAD (PENDANT) SPRINKLER HEAD (UPRIGHT) SPRINKLER HEAD		VALVE IN RISER		VENT PIPING
PIPE ANCHOR EXPANSION JOINT - SLIDING ALIGNMENT GUIDE UNION STM STEAM SPRINKLER HEAD (PENDANT) — CR — CONDESATE RETURN SPRINKLER HEAD (UPRIGHT) — OXY — OXYGEN CLEANOUT — VAC — VACUUM FCO CLEANOUT FLOOR — MA — MEDICAL AIR WCO CLEANOUT WALL — N2 — NITROGEN SCO CLEANOUT GRADE — N2O — NITROUS OXIDE FLOOR DRAIN (FD) — G — NATURAL GAS FLOOR DRAIN (FD) — F — FIRE SPRINKLER PIPE (FS) HHWS — HEATING HOT WATER SUPPLY PRESSURE GAUGE WITH COCK — HHWR — HEATING HOT WATER RETURN THERMOMETER — CHWS — CHILLED WATER SUPPLY CAP OR PLUG — — CHWR — CHILLED HOT WATER RETURN ELBOW - TURNED DOWN ELBOW - TURNED DOWN TEE OUTLET - DOWN		STRAINER	SAN	SANITARY LINE (UNDERGROUND)
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O SPRINKLER HEAD (UPRIGHT)	——————————————————————————————————————	UNION	—— STM ——	STEAM
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FCO CLEANOUT FLOOR — MA — MEDICAL AIR OF WCO CLEANOUT WALL — N2 — NITROGEN OF GCO CLEANOUT GRADE — N2O — NATURAL GAS FLOOR DRAIN (FD) — G — NATURAL GAS REDUCER - CONCENTRIC — F — FIRE SPRINKLER PIPE (FS) HHWS — HEATING HOT WATER SUPPLY PRESSURE GAUGE WITH COCK — HHWR — HEATING HOT WATER RETURN THERMOMETER — CHWS — CHILLED WATER SUPPLY CAP OR PLUG — CHWR — CHILLED HOT WATER RETURN ELBOW - TURNED DOWN ELBOW - TURNED UP TEE OUTLET - DOWN	0	SPRINKLER HEAD (UPRIGHT)	—— OXY ——	OXYGEN
O WCO CLEANOUT WALL O GCO CLEANOUT GRADE FLOOR DRAIN (FD) REDUCER − CONCENTRIC F − FIRE SPRINKLER PIPE (FS) HHWS − HEATING HOT WATER SUPPLY PRESSURE GAUGE WITH COCK THERMOMETER CAP OR PLUG CAP OR PLUG ELBOW − TURNED DOWN ELBOW − TURNED UP TEE OUTLET − DOWN	II CO	CLEANOUT	—— VAC ——	VACUUM
GCO CLEANOUT GRADE — N20 — NITROUS OXIDE FLOOR DRAIN (FD) — G — NATURAL GAS REDUCER - CONCENTRIC — F — FIRE SPRINKLER PIPE (FS) HHWS — HEATING HOT WATER SUPPLY PRESSURE GAUGE WITH COCK — HHWR — HEATING HOT WATER RETURN THERMOMETER — CHWS — CHILLED WATER SUPPLY CAP OR PLUG — CHWR — CHILLED HOT WATER RETURN ELBOW - TURNED DOWN ELBOW - TURNED UP TEE OUTLET - DOWN	——○ FCO	CLEANOUT FLOOR	——— MA ———	MEDICAL AIR
FLOOR DRAIN (FD) REDUCER - CONCENTRIC	O WCO	CLEANOUT WALL	—— N2 ——	NITROGEN
REDUCER - CONCENTRIC — F — FIRE SPRINKLER PIPE (FS) HHWS— HEATING HOT WATER SUPPLY PRESSURE GAUGE WITH COCK — HHWR— HEATING HOT WATER RETURN THERMOMETER — CHWS— CHILLED WATER SUPPLY CAP OR PLUG — CHWR— CHILLED HOT WATER RETURN ELBOW - TURNED DOWN ELBOW - TURNED UP TEE OUTLET - DOWN	——⊚ GCO	CLEANOUT GRADE	N20	NITROUS OXIDE
PRESSURE GAUGE WITH COCK ——HHWS—— HEATING HOT WATER SUPPLY ——HHWR—— HEATING HOT WATER RETURN ——HHWR—— HEATING HOT WATER RETURN ——CHWS—— CHILLED WATER SUPPLY ——————————————————————————————————		FLOOR DRAIN (FD)	——— G ———	NATURAL GAS
PRESSURE GAUGE WITH COCK ——HHWR—— ——CHWS—— ——CHWR—— ——CHULED WATER RETURN ——CHWR—— ——CHULED HOT WATER RETURN ——CHWR—— ——CHWR—— ——CHULED HOT WATER RETURN ——CHWR—— ——CHWR—— ——CHULED HOT WATER RETURN ——CHWR—— ——CHWR	$-\!\!\!\!-\!\!\!\!\!-\!\!\!\!\!-\!\!\!\!\!-$	REDUCER - CONCENTRIC	—— F ——	FIRE SPRINKLER PIPE (FS)
THERMOMETER —— CHWS—— CHILLED WATER RETURN CAP OR PLUG —— CHWR—— CHILLED HOT WATER RETURN ELBOW — TURNED DOWN ELBOW — TURNED UP TEE OUTLET — DOWN	\bigcirc		HHWS	HEATING HOT WATER SUPPLY
CHWS—— CHILLED WATER SUPPLY CAP OR PLUG —— CHWR—— CHILLED HOT WATER RETURN ELBOW — TURNED DOWN ELBOW — TURNED UP TEE OUTLET — DOWN	<u>. </u>	PRESSURE GAUGE WITH COCK	— — HHWR— —	HEATING HOT WATER RETURN
ELBOW - TURNED DOWN ELBOW - TURNED UP TEE OUTLET - DOWN	<u></u>	THERMOMETER	CHWS	CHILLED WATER SUPPLY
ELBOW - TURNED UP TEE OUTLET - DOWN		CAP OR PLUG	— — CHWR— —	CHILLED HOT WATER RETURN
TEE OUTLET - DOWN		ELBOW — TURNED DOWN		
		ELBOW — TURNED UP		
		TEE OUTLET — DOWN		
		TEE OUTLET - UP		

	MECHANICAL SHEET INDEX
М000	MECHANICAL SYMBOLS LIST, INDEX AND NOTES
MD110	DEMOLITION HVAC PLAN - LEVEL 1
M110	HVAC PLAN - LEVEL 1
FP110	FIRE PROTECTION PLAN — LEVEL 1
М300	MECHANICAL SCHEDULES AND DETAILS
M400	MECHANICAL SPECIFICATIONS

HVAC LEGEND & SYMBOLS

DIRECTION OF FLOW


RETURN AIR GRILLE


SUPPLY AIR GRILLE

LINEAR SUPPLY AIR DIFFUSER

TWO-WAY MODULATING CONTROL VALVE

THREE-WAY MODULATING CONTROL VALVE

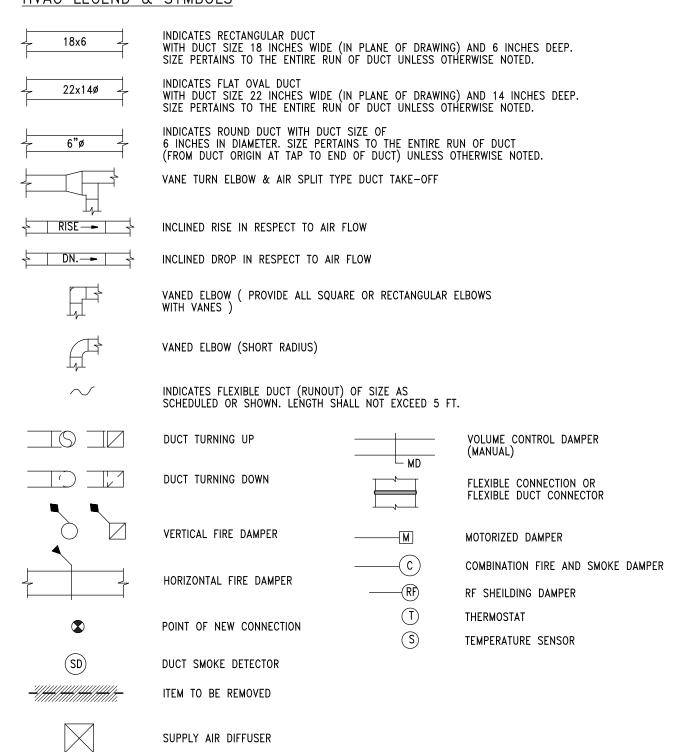

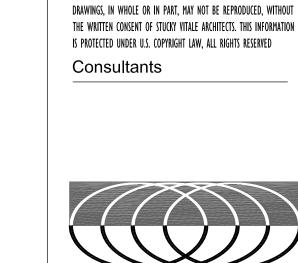

STUCKY VITALE ARCHITECTS

27172 WOODWARD AVENUE

ROYAL OAK, MI 48067-0925

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5155 GULLEN MALL, DETROIT, MI 48202

Key Plan:

5155 GULLEN MALL, DETROIT MI 48202

09/15/2023

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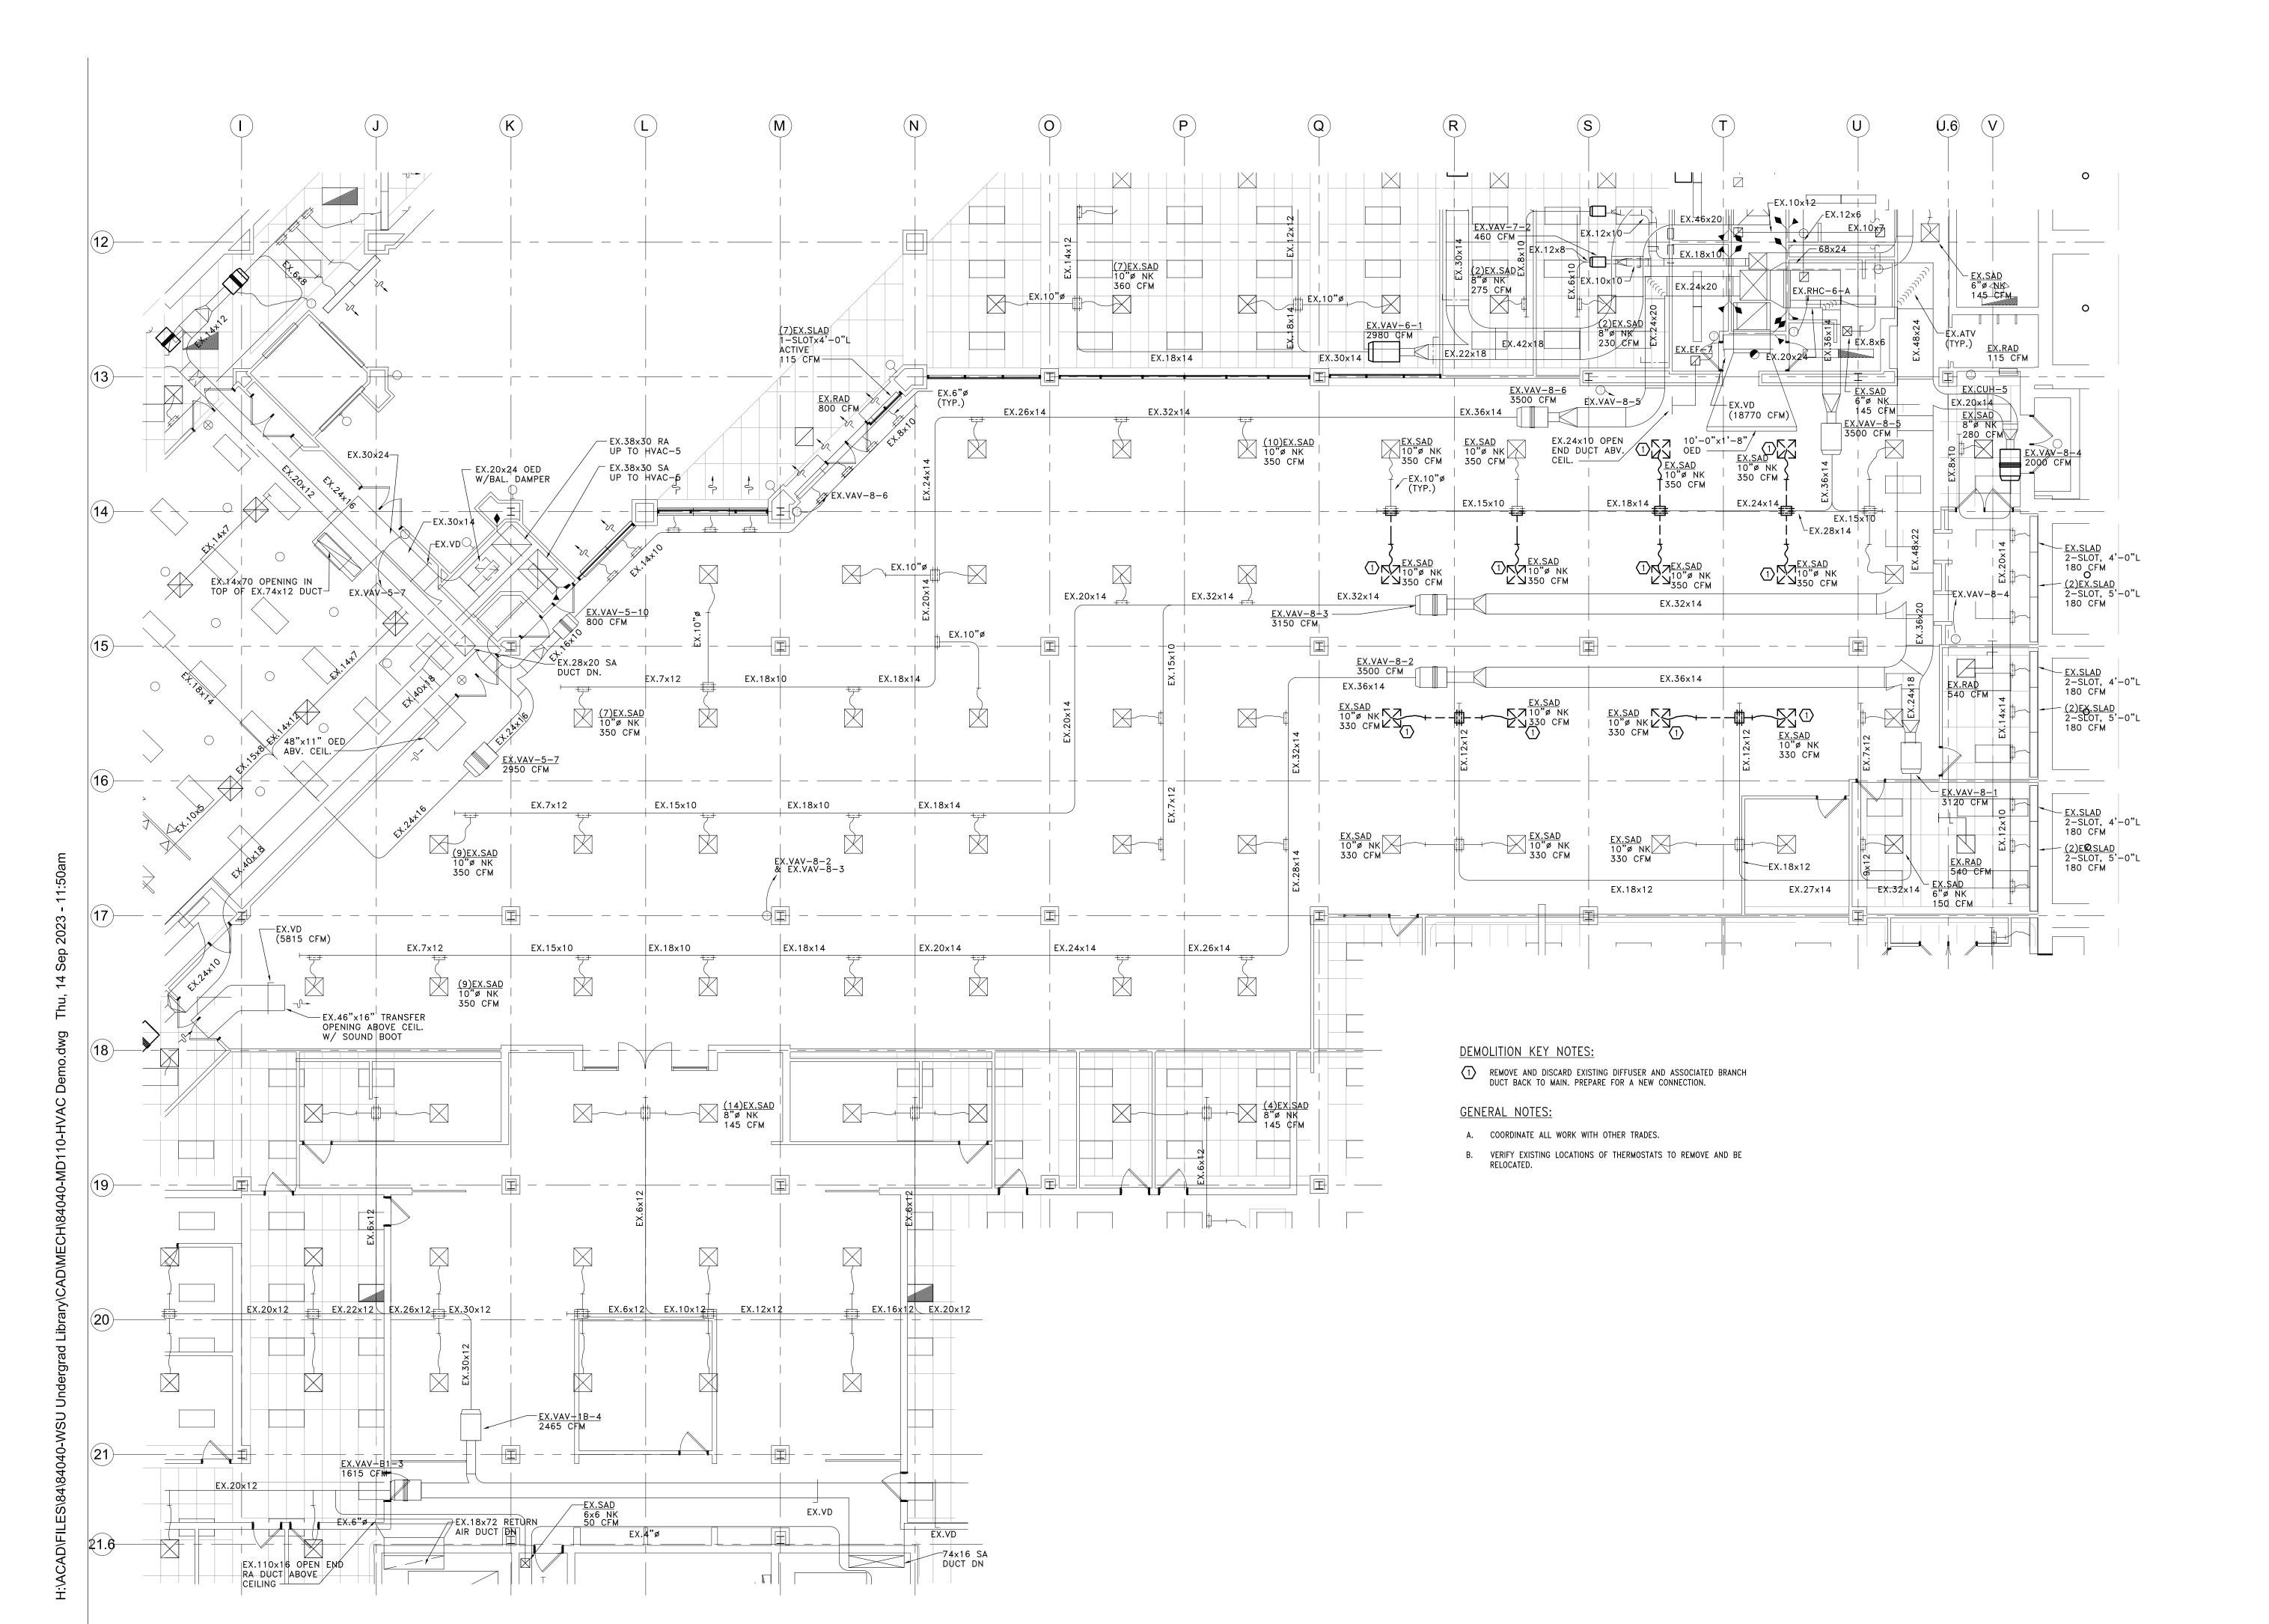
Sheet Title: MECHANICAL SYMBOLS LIST,

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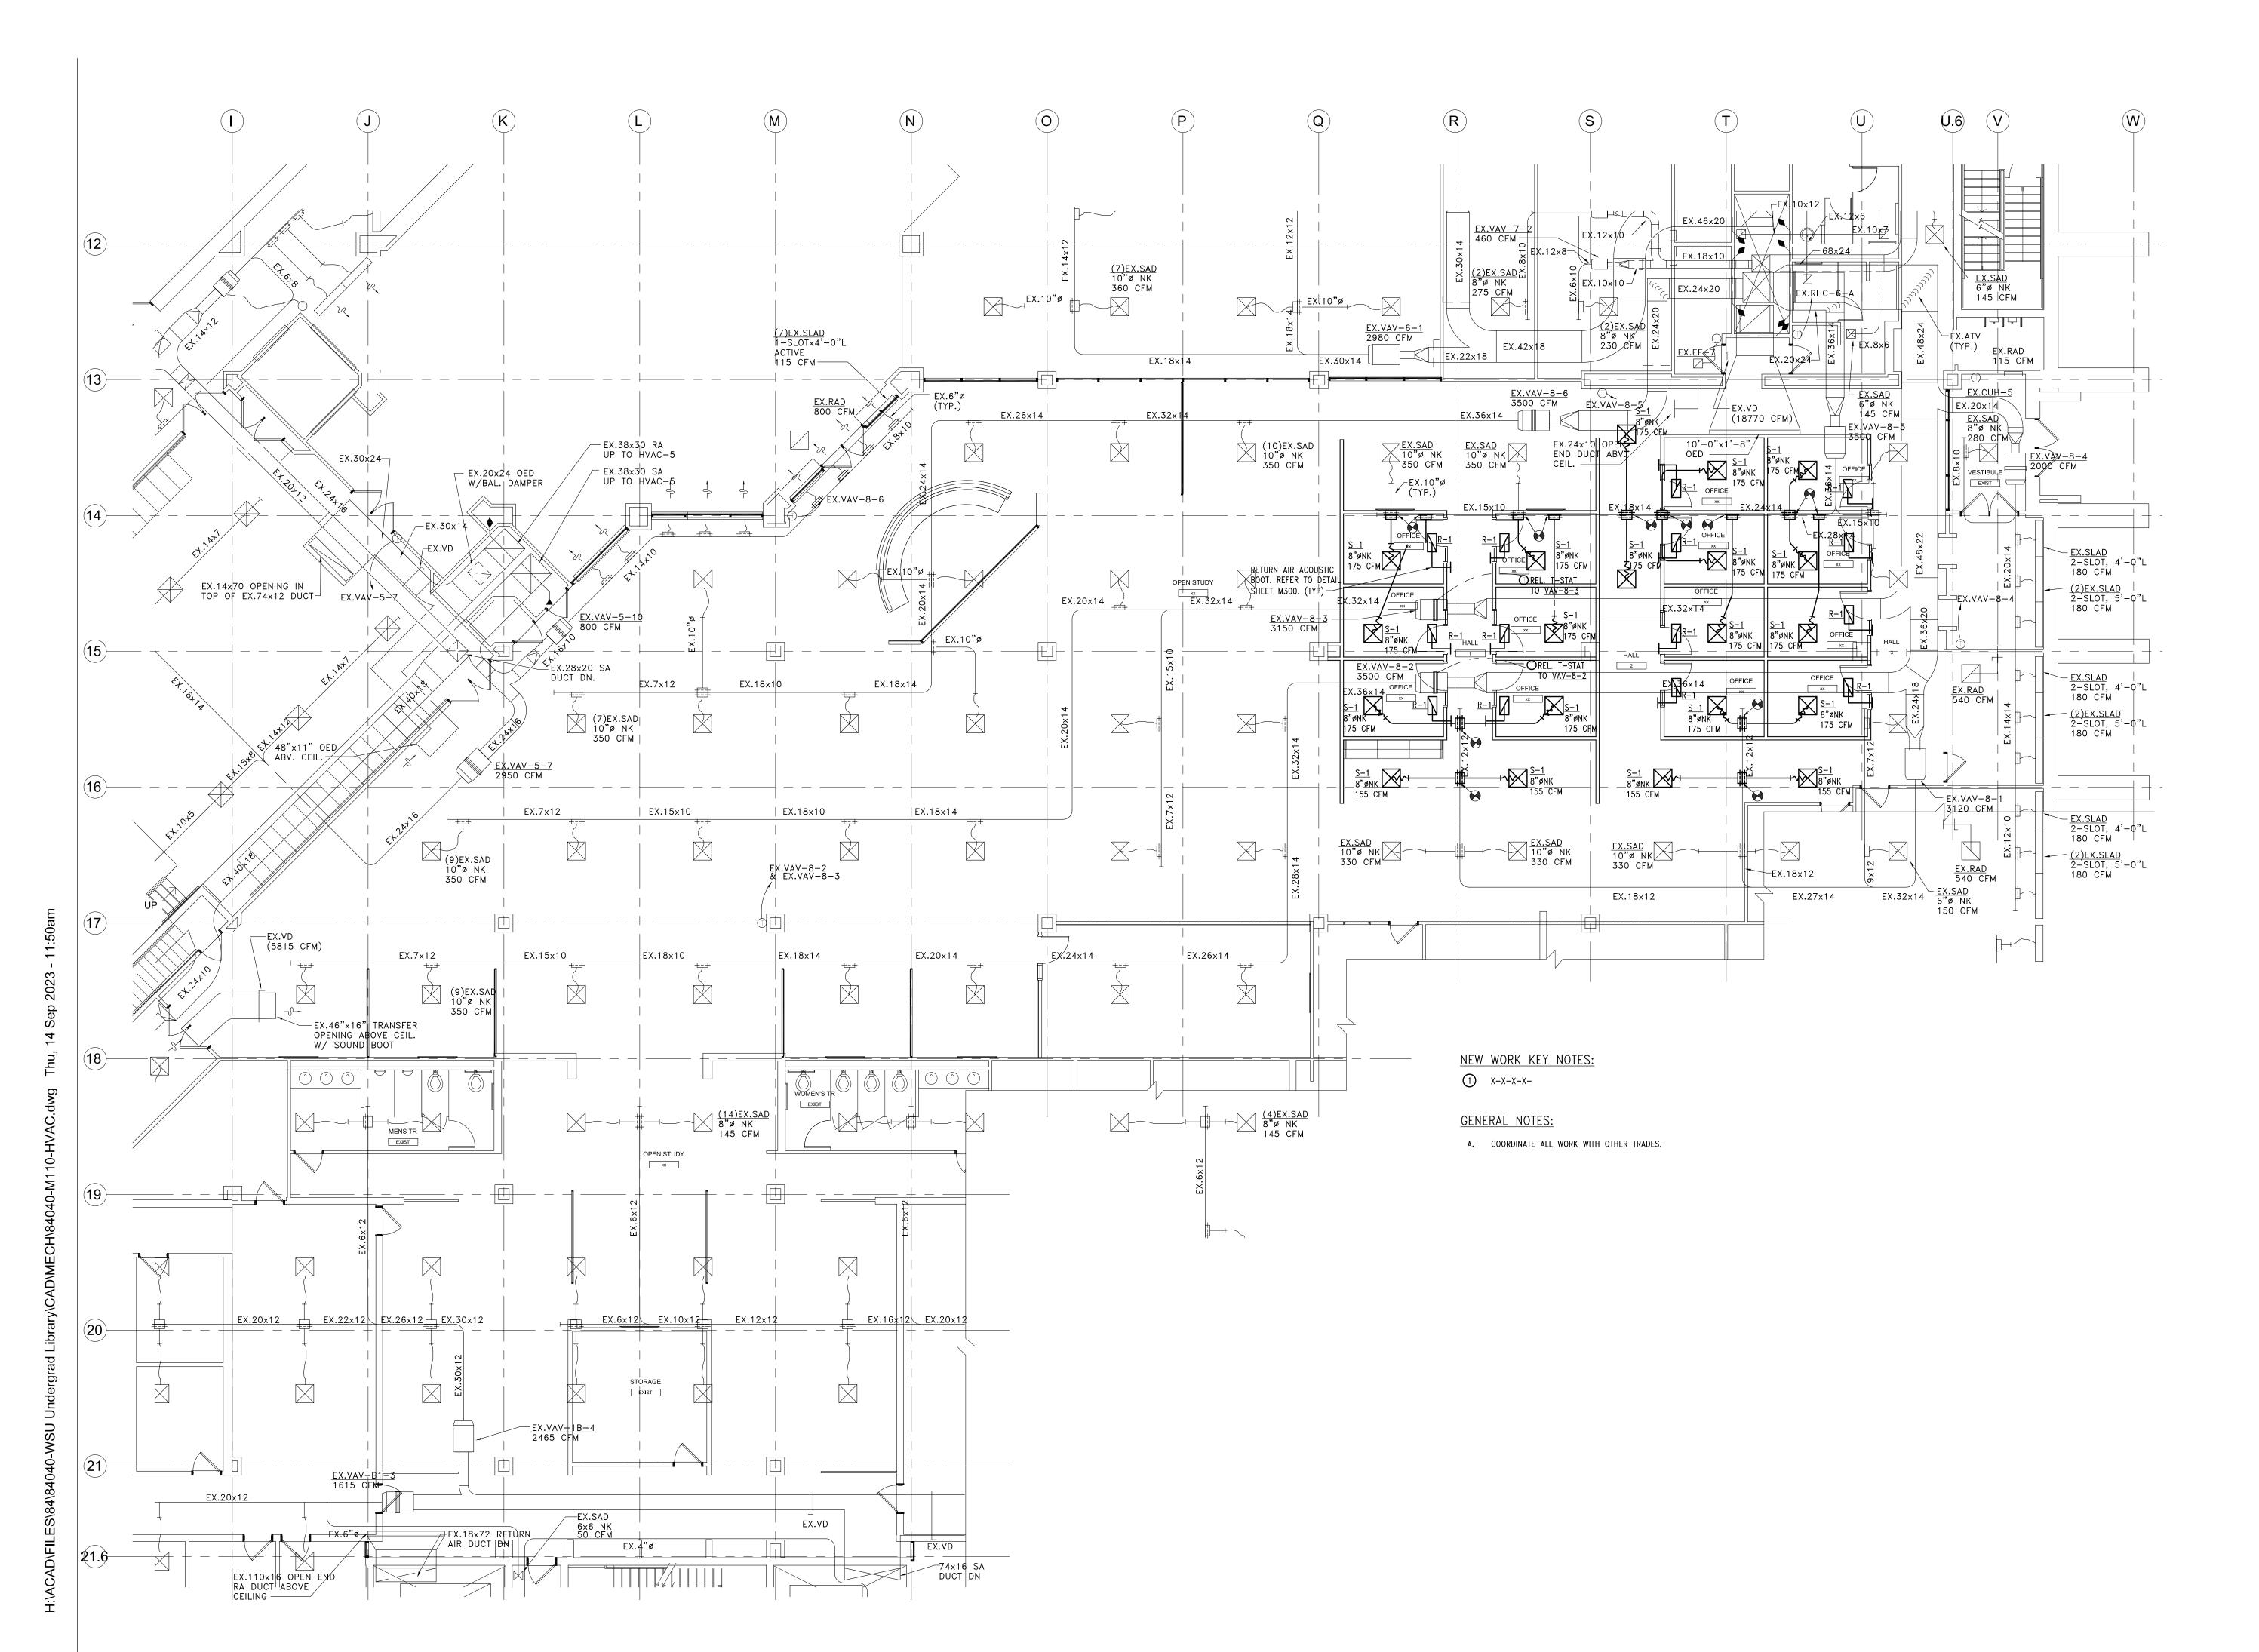
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DEMOLITION HVAC PLAN -LEVEL 1

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Sheet No. :

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HVAC PLAN - LEVEL 1

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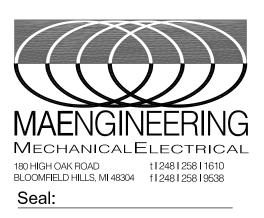
1 HVAC PLAN - LEVEL 1 M110 1/8" = 1'-0"



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FIRE PROTECTION PLAN LEVEL 1

Project No. : 2023.111

Sheet No.:


FP110


Turning The second

1 HVAC PIPING PLAN - LEVEL 1

1/8" = 1'-0"

		GRILLE,	REGISTER	AND DIFF	USER SCH	HEDULE	
TAG	MANUFACTURER & MODEL NO.	SERVICE	MOUNTING	OVERALL SIZE	NECK SIZE	CONSTRUCTION	NOTES/ACCESSORIES
S-1	TITUS OMNI	SAD	CEILING LAY-IN	24x24	SEE PLAN		A
R-1	TITUS 50F	RAG	CEILING LAY-IN	12x24	SEE PLAN		A C
SA	D – CEILING OR WAL G – CEILING OR WAL G – WALL TRANSFER	L SUPPLY GRILLE		RAG	- CEILING OR WA	LL RETURN REGISTEI LL RETURN GRILLE LL EXHAUST GRILLE	R
			NOTES AND ACCES	SORIES DESIGNATIO	N		
A WHITE				С	PROVIDE FLAT BLA	ACK PAINTED BACK	PLENUM
B BLADE	PARALLEL TO SHORT	DIMENSION		D			

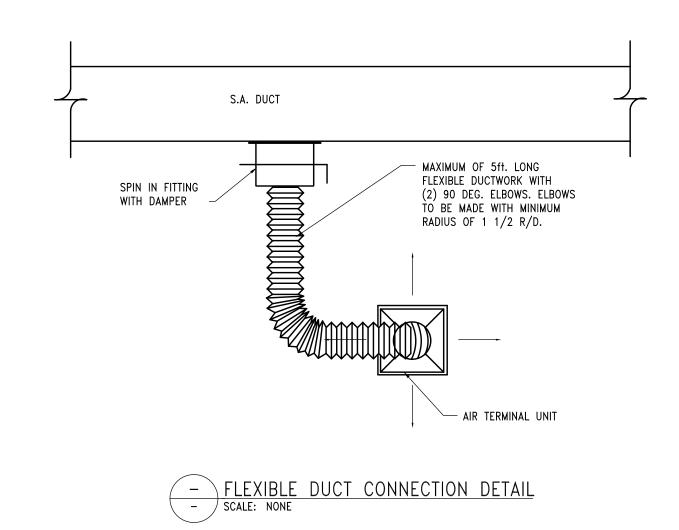

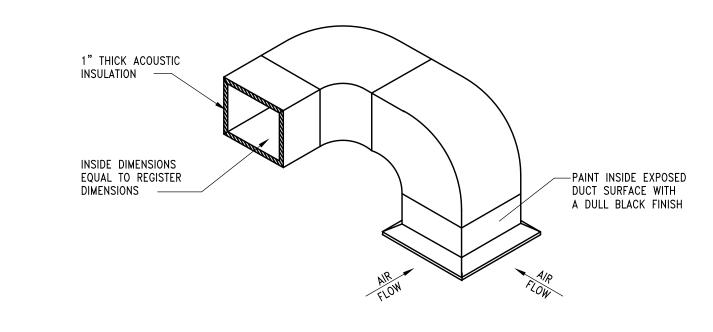

DETAIL OF A TYPICAL SOUND INSULATED RETURN

- AIR PLENUM FOR OFFICES AND CONFERENCE ROOMS


SCALE: NONE



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Checked by:

Sheet Title:

MECHANICAL SCHEDULES AND DETAILS

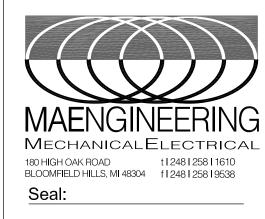Project No.:

2023.111

Sheet No.:

wwwwwww

WORK INCLUDED:

A. FURNISH ALL LABOR AND MATERIAL, APPLIANCES, EQUIPMENT AND SUPERVISION TO PUT IN PLACE A COMPLETE AND FUNCTIONING MECHANICAL INSTALLATION READY FOR OPERATION, AS SPECIFIED HEREIN AND AS INDICATED ON THE DRAWINGS. SYSTEMS SHALL INCLUDE BUT NOT NECESSARILY LIMITED TO THE FOLLOWING MAJOR EQUIPMENT OR OPERATIONS: HEATING, VENTILATING AND AIR CONDITIONING.

A. "PROVIDE": TO FURNISH AND COMPLETELY INSTALL SPECIFIED PRODUCTS AND INCIDENTALS, WHETHER SPECIFICALLY INDICATED OR NOT, NECESSARY FOR A COMPLETE, FUNCTIONAL INSTALLATION. INCLUDES ALL GENERAL AND SPECIALIZED LABOR, EQUIPMENT AND TOOLS NECESSARY TO COMPLETE THE INSTALLATION. B. "PIPING": A COMPLETE SYSTEM, INCLUDING PIPE, TUBING, FITTINGS, HANGERS, SUPPORTS, VALVES, AND ALL SPECIALTIES THAT COMPRISE A FULLY FUNCTIONAL PIPING SYSTEM, WHETHER SPECIFICALLY INDICATED OR NOT.

CODES, ORDINANCES, AND STANDARDS:

A. ALL WORK SHALL CONFORM IN ALL RESPECTS TO THE REQUIREMENTS OF THE LATEST ADOPTED FEDERAL, STATE AND LOCAL CODES, ORDINANCES, AND STANDARDS HAVING JURISDICTION OVER THE WORK.

B. WHERE CONTRACT DOCUMENT REQUIREMENTS EXCEED THE REQUIREMENTS OF THE REFERENCED CODES, ORDINANCES, AND STANDARDS, THE CONTRACT DOCUMENT REQUIREMENTS SHALL BE TAKEN AS MINIMUM. C. ALL EQUIPMENT CONTAINING ELECTRICAL WIRING AND/OR ELECTRICAL COMPONENTS SHALL HAVE A UNDERWRITERS LABORATORIES

(UL) "PACKAGE" LABEL. D. ALL GAS FIRED EQUIPMENT SHALL HAVE THE AMERICAN GAS ASSOCIATION (AGA) LABEL.

PERMITS, FEES AND INSPECTIONS: A. SECURE ALL NECESSARY PERMITS, CONNECTION FEES, TAD FEES, LICENSES AND APPROVALS AND ARRANGE FOR ALL INSPECTIONS,

INCLUDE ALL RELATED COSTS. B. FURNISH CERTIFICATES OF FINAL INSPECTION AND APPROVAL UPON COMPLETION OF PROJECT.

A. VISIT PROJECT SITE AND BECOME FULLY COGNIZANT OF ALL EXISTING ARCHITECTURAL, MECHANICAL, ELECTRICAL, STRUCTURAL AND SITE CONDITIONS, OR EXISTING CODE VIOLATIONS WHICH MAY AFFECT THE WORK. B. NOTIFY ARCHITECT PRIOR TO SUBMITTING BID IF REVISIONS TO CONTRACT DOCUMENTS ARE NECESSARY TO RECTIFY ANY OF THE AFOREMENTIONED EXISTING CONDITIONS. C. NO "EXTRAS" TO CONTRACT PRICE WILL BE ALLOWED AFTER RECEIVING BID IN ORDER TO RECTIFY EXISTING CONDITIONS IN ORDER

COORDINATION WITH OTHER TRADES:

A. COORDINATE ALL WORK BEFORE AND DURING CONSTRUCTION WITH ALL OTHER AFFECTED TRADES.

TO MEET THE DESIGN INTENT OF THE CONTRACT DOCUMENTS OR SATISFY CODE REQUIREMENTS.

WHERE INTERFERENCES DEVELOP, NOTIFY ARCHITECT FOR RESOLUTION OF CONFLICT. RELOCATION OF CONFLICTING INSTALLED WORK, DUE TO LACK OF COORDINATION, OR POOR COORDINATION WILL NOT BE

CONSIDERED EXTRA WORK.

A. USE ONLY MATERIALS SPECIFICALLY INDICATED IN CONTRACT DOCUMENTS, OR COMPARABLE MATERIALS BY OTHER LISTED ACCEPTABLE MANUFACTURERS. NOTE THAT "ACCEPTABLE MANUFACTURER" DOES NOT CONSTRUE AUTOMATIC APPROVAL OF SPECIFIC MATERIALS BY ONE OR ALL OF THE LISTED ACCEPTABLE MANUFACTURERS. ARCHITECT AND/OR ENGINEER OF RECORD RESERVES THE RIGHT OF FINAL DETERMINATION OF ACCEPTABILITY OF EACH ITEM.

A. SUBMIT COMPLETE SHOP DRAWINGS FOR ALL MATERIALS AND EQUIPMENT INTENDED FOR USE ON THIS PROJECT. B. SHOP DRAWINGS SHALL CLEARLY INDICATE ALL PHYSICAL, PERFORMANCE AND ELECTRICAL CHARACTERISTICS FOR ALL MATERIALS

C. SUBMIT ELECTRONIC COPY OF ALL SHOP DRAWINGS FOR REVIEW.

D. NO WORK IS TO BE INSTALLED PRIOR TO RETURN OF ARCHITECT REVIEWED SHOP DRAWINGS.

OPERATION AND MAINTENANCE MANUALS:

A. UPON COMPLETION OF PROJECT, SUBMIT TWO (2) COMPLETE BOUND SETS OF OPERATING AND MAINTENANCE MANUALS FOR ALL EQUIPMENT AND SYSTEMS INSTALLED IN THIS PROJECT. B. MANUALS SHALL INCLUDE GUARANTEE(S), COMPLETE OPERATING INSTRUCTIONS, REPAIR PARTS LIST, PREVENTATIVE MAINTENANCE SCHEDULE, BELT AND FILTER SCHEDULE, AND LIST OF ALL SUBCONTRACTORS ASSOCIATED WITH THE WORK, INCLUDING TELEPHONE NUMBER AND CONTACT PERSON.

A. PRIOR TO FINAL ACCEPTANCE BY OWNER, PROVIDE ALL PERSONNEL, EQUIPMENT, AND LABOR AS NECESSARY TO INSTRUCT OWNER'S PERSONNEL IN PROPER OPERATION AND MAINTENANCE OF THE SYSTEMS AND EQUIPMENT INSTALLED IN THIS PROJECT. PROVIDE INSTRUCTIONAL SESSION DURING TIME PERIOD AGREED TO WITH OWNER.

A. ALL CUTTING AND PATCHING SHALL BE PROVIDED BY THE GENERAL TRADES UNDER THE DIRECTION OF THE MECHANICAL TRADES. COST WILL BE PAID BY THE MECHANICAL TRADE REQUESTING THE WORK. B. RESTORED SURFACES SHALL BE OF SAME MATERIALS AND QUALITY AS ADJACENT SURFACES, AND SHALL MATCH SURROUNDING SURFACES, AND/OR BE RESTORED TO PRE-CONSTRUCTION CONDITION.

PROTECTION OF EXISTING SERVICES: A. PROTECT FROM ALL DAMAGE, EXISTING SERVICES (I.E., GAS, WATER, ELECTRICAL, ETC.), ENCOUNTERED IN THE WORK, NOT SPECIFICALLY INDICATED TO BE DEMOLISHED. INCLUDE ALL RELATED COSTS.

CONSTRUCTION. ABSORB ALL RELATED COSTS. NO "EXTRAS" WILL BE PAID TO RESTORE EXISTING ACTIVE SERVICES DAMAGED DURING ARCHITECT WILL DETERMINE COURSE OF ACTION WHEN EXISTING INACTIVE SERVICES ARE DAMAGED DURING COURSE OF CONSTRUCTION. ABSORB ALL COSTS RELATIVE TO ADDITIONAL DEMOLITION, TERMINATION, RELOCATION AND/OR RESTORATION OF

B. REPAIR AND/OR REPLACE EXISTING ACTIVE SERVICES INTENDED TO REMAIN IN SERVICE, BUT DAMAGED DURING THE COURSE OF

ELECTRICAL WORK: A. PROVIDE ALL ELECTRICAL WORK ASSOCIATED WITH, AND NECESSARY TO COMPLETE THIS PROJECT, WHICH IS NOT INCLUDED AS

ELECTRICAL TRADES WORK. B. PROVIDE ALL ELECTRICAL WORK, AS APPLICABLE, IN ACCORDANCE WITH DIVISION 16 REQUIREMENTS.

CONTRACTOR SHALL BE RESPONSIBLE FOR VERIFICATION (WITH ELECTRICAL TRADES) OF CORRECT VOLTAGES FOR ALL MECHANICAL EQUIPMENT. IN CASE OF DISCREPANCY, NOTIFY ENGINEER IMMEDIATELY AND PRIOR TO SHOP DRAWING SUBMITTALS. FAILURE TO COMPLY WITH THIS REQUIREMENT HOLDS THE CONTRACTOR FULLY RESPONSIBLE FOR ANY SUBSEQUENT PROBLEMS

CLEANING AND FINISHING: A. PRIOR TO FINAL ACCEPTANCE BY OWNER, THOROUGHLY CLEAN ALL WORK INSIDE AND OUT AS APPLICABLE, AND LEAVE ALL SYSTEMS AND EQUIPMENT IN PERFECT WORKING ORDER. THOROUGHLY CLEAN ALL PLUMBING FIXTURES, EXPOSED PIPING, FLOOR DRAIN GRATES, AND CLEANOUT COVERS AS APPLICABLE.

A. REFER TO ARCHITECTURAL SPECIFICATIONS FOR GUARANTEES, IF NONE EXIST THE FOLLOWING MINIMUM GUARANTEES SHALL BE

1. PROVIDE A ONE (1) YEAR GUARANTEE COVERING ALL LABOR AND MATERIAL PROVIDED IN THIS PROJECT. GUARANTEE SHALL INCLUDE ALL SHIPPING AND TRANSPORTATION CHARGES NECESSARY TO RETURN DEFECTIVE MATERIALS TO MANUFACTURER, AS WELL AS LABOR CHARGES NECESSARY TO REMOVE AND REPLACE DEFECTIVE MATERIALS. 2. PROVIDE 5 YEAR GUARANTEE FOR ALL COMPRESSORS.

3. DEFECTIVE MATERIALS AND/OR EQUIPMENT MAY BE REPAIRED IN LIEU OF REPLACED WITH PRIOR APPROVAL OF ARCHITECT AND/OR OWNER. PIPING:

SANITARY WASTE AND VENT PIPE AND FITTINGS:

BELOW GRADE AND/OR BELOW FLOOR SLABS WITHIN BUILDING WALLS AND EXTENDING 5'-0" OUTSIDE:

UP TO 6" DIAMETER: PIPE: ASTM D2665 SCHEDULE 40 PVC-DWV INSTALLED PER MANUFACTURER'S RECOMMENDATIONS.

FITTINGS: ASTM D1554 SOLVENT CEMENTED. SOLVENT CEMENT: ASTM D2564.

INSTALLATION: IN ACCORDANCE WITH ASTM D2321.

ABOVEGROUND SANITARY WASTE AND VENT PIPING AND FITTINGS:

EXISTING, DAMAGED INACTIVE SERVICES AS DIRECTED BY ARCHITECT.

PIPE 4" AND UNDER: ASTM A-53, SCHEDULE 40, GALVANIZED STEEL. PIPE OVER 4": ASTM A-53, SCHEDULE 40, GRADE A AND GRADE B, SEAMLESS OR ERW GALVANIZED STEEL. FITTINGS: ANSI B2.1 THREADS.

PIPE AND FITTINGS: CAST IRON HUBLESS SOIL PIPE AND FITTINGS CONFORMING TO THE REQUIREMENTS OF CISPI STANDARD 310 AND LOCAL CODE REQUIREMENTS. HUBLESS COUPLING GASKETS SHALL CONFORM TO ASTM STANDARD C-564.

STORM WATER PIPE AND FITTINGS:

BELOW GRADE AND/OR BELOW FLOOR SLABS WITHIN BUILDING WALLS AND EXTENDING 5'-0" OUTSIDE:

PIPE: ASTM D2665 SCHEDULE 40 PVC-DWV INSTALLED PER MANUFACTURER'S RECOMMENDATIONS.

FITTINGS: ASTM D1554 SOLVENT CEMENTED. SOLVENT CEMENT: ASTM D2564.

INSTALLATION: IN ACCORDANCE WITH ASTM D2321.

ABOVEGROUND STORM PIPE AND FITTINGS:

PIPE 4" AND UNDER: ASTM A-53, SCHEDULE 40, GALVANIZED STEEL. PIPE OVER 4": ASTM A-53, SCHEDULE 40, GRADE A OR GRADE B, SEAMLESS OR ERW, GALVANIZED STEEL. FITTINGS: ANSI B16.12 CAST IRON THREADED DRAINAGE FITTINGS. JOINTS: ANSI B2.1 THREADS.

PIPE AND FITTINGS: CAST IRON HUBLESS SOIL PIPE AND FITTINGS CONFORMING TO THE REQUIREMENTS OF CISPI STANDARD 310 AND LOCAL CODE REQUIREMENTS. HUBLESS COUPLING GASKETS SHALL CONFORM TO ASTM STANDARD C-564.

UNDERGROUND SEWERS (SANITARY AND STORM) ON SITE EXTENDING BEYOND 5 FEET OUTSIDE OF BUILDING SHALL BE PROVIDED BY SITE UTILITIES CONTRACTOR.

SHEET METAL NOTES:

INSTALL TRANSFER GRILLES IN ALL FULL HEIGHT PARTITIONS TO ALLOW RETURN AIR FLOW. SIZE PER MECHANICAL ENGINEER REQUIREMENTS. THESE SHALL BE FIRE DAMPERS IN RATED WALLS.

BLANK-OFF RETURN DUCTWORK IN AREAS OF WORK THAT CREATES DUST TO PREVENT DEBRIS FROM ENTERING MECHANICAL SYSTEM. LOW PRESSURE DUCTWORK: ALL DUCTWORK ON DISCHARGE OF HVAC UNIT, ALL RETURN AIR DUCTWORK AND EXHAUST AIR DUCTWORK SHALL BE CONSTRUCTED AND SUPPORTED IN ACCORDANCE WITH THE REQUIREMENTS OF THE LATEST SMACNA'S ISSUE OF "LOW PRESSURE DUCT CONSTRUCTION STANDARDS".

IN ADDITION. ALL JOINTS AND SEAMS SHALL BE SEALED WITH DUCT SEALANT EQUAL TO FOSTER #32-14. APPROVED SEALANT MANUFACTURERS: 3M COMPANY, BENJAMIN FOSTER COMPANY, UNITED SHEET METAL, FLINTKOTE.

AT EACH POINT OF CONNECTION OF DUCTWORK TO FANS, PROVIDE A FLEXIBLE CONNECTION, VENTFABRICS, INC., "VENTGLAS L.A." NOT LESS THAN 12" IN LENGTH AND MADE OF HEAVY GRADE GLASS FABRIC DOUBLE COATED WITH NEOPRENE AND PROVIDED WITH A SUITABLE FRAME AT EACH END ARRANGED FOR BOLTING TO INLET AND OUTLET OF FAN AND DUCTWORK, RESPECTIVELY.

ALL LOW PRESSURE AND HIGH PRESSURE FLEXIBLE DUCT SHALL BE FLEXMASTER USA, INC., TYPE #8M INSULATED FLEXIBLE DUCT CONSISTING OF A FACTORY FABRICATED ASSEMBLY OF A TRILAMINATE ALUMINUM FOIL, FIBERGLASS AND POLYESTER. THE FLEXIBLE DUCT SHALL BE UL LISTED 181 CLASS 1 AIR DUCT AND COMPLY WITH NFPA 90A AND 90B AND HAVE A FLAME SPREAD OF NOT OVER 25 AND A SMOKE DEVELOPED OF NOT OVER 50. THE FLEXIBLE DUCT SHALL HAVE A MINIMUM PRESSURE RATING OF 12" WC THROUGH TEMPERATURE RANGE OF -20 DEGREES F. TO + 250 DEGREES F.

DUCT INSULATION:

ACOUSTICAL LINING: ACOUSTIC INSULATION SHALL BE JOHNS-MANVILLE OR EQUAL "LINACOUSTIC" WITH A .70 NRC, 1-1/2"/CU.FT. MINIMUM DENSITY, 1" THICK UNLESS OTHERWISE NOTED. INSULATION SHALL BE SUITABLE FOR VELOCITIES OF 5,000 FPM. ABSOLUTE ROUGHNESS FACTOR SHALL NOT EXCEED .0008 FEET. SCOPE: DUCTWORK AND EQUIPMENT LISTED BELOW AND/OR NOTED ON THE CONTRACT DOCUMENTS SHALL BE ACOUSTICALLY LINED. RECTANGULAR SUPPLY DUCTWORK FROM ALL TERMINAL BOXES TO GRILLES, REGISTERS AND DIFFUSERS. ROUND DUCTWORK ON

DISCHARGE ON TERMINAL BOXES SHALL BE INSULATED EXTERNALLY UNLESS OTHERWISE NOTED.

TESTING AND BALANCING:

TEST AND ADJUST ALL NEW PIPING SYSTEMS INSTALLED IN THIS PROJECT. PROVIDE ALL TESTING INSTRUMENTS, GAUGES, PUMPS AND OTHER EQUIPMENT REQUIRED OR NECESSARY FOR TEST. REPAIR ALL DEFECTS DISCLOSED BY TESTS WITHOUT ADDITIONAL COST TO THE OWNER. REPEAT TESTS AFTER ANY DEFECTS DISCLOSED ARE REPAIRED OR REPLACED, UNLESS WAIVED BY ARCHITECT. ARRANGE AND PAY THE COST OF ALL UTILITIES USED ON TESTS. COMPLETE ALL TESTS BEFORE COVERING IS APPLIED. ISOLATE ALL PIPING SYSTEM COMPONENTS NOT CONSTRUCTED TO WITHSTAND TEST PRESSURES.

BALANCE ALL OUTLETS AND TERMINAL BOXES TO WITHIN 10% OF RATED C.F.M IN ACCORDANCE WITH AABC AND NEBB, SUBMIT



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WSU- DETROIT- UGL **1ST FLOOR STUDENT**

5155 GULLEN MALL, DETROIT, MI 48202

Key Plan:

5155 GULLEN MALL, DETROIT MI 48202

09/15/2023

09.28.23

Issued for

ADDENDUM #1

Drawn by:

Checked by:

Sheet Title:

MECHANICAL SPECIFICATIONS

Project No.:

2023.111

Sheet No.:

ELECTRICAL LEGEND *

	ELECTRICAL LE	EGEND *
"A"	FIXTURE TYPE	
	1x4 LIGHT FIXTURE POLE MOUNTED LIGHTING FIXTURE	
	STRIP LIGHTING FIXTURE 2'X2' OR 2'X4' LIGHTING FIXTURE	
	FULL SHADED LIGHTING FIXTURES ARE WIR LIGHTS	ED UNSWITCHED NIGHT
	HALF SHADED FIXTURES ARE FIXTURES PRO EMERGENCY BATTERY PACK FOR EGRESS L	
	RECESSED DOWN LIGHT	
	WALL MOUNTED LIGHTING FIXTURE TRACK LIGHTING FIXTURE	
\$⊗	EXIT LIGHTING FIXTURE — SHADING INDICATION FACE (S) CHEVRONS AS INDICATED	TES ILLUMINATED
	EMERGENCY LIGHTING UNIT	
<u> </u>	COMBINATION OF EXIT AND EMERGENCY LIC	GHTING UNIT
S ₃	SINGLE POLE LIGHT SWITCH THREE WAY LIGHT SWITCH	
S ₄	FOUR WAY LIGHT SWITCH	
Sk Sp	KEY OPERATED SWITCH LIGHT SWITCH WITH PILOT LIGHT	
Sp3	THREE WAY LIGHT SWITCH WITH PILOT LIG	HT -
So	DIMMER SWITCH, COMPATIBLE WITH LIGHTS	CONTROLLED
SMD	DIMMER SWITCH WITH WALL OCCUPANCY SENS	SOR (SINGLE POLE)
Sd3 St St	THREE WAY LIGHT SWITCH WITH DIMMER TIMER SWITCH	
Slv	LOW VOLTAGE CONTROL STATION WITH DIM BUTTONS AS INDICATED TO PROVIDE PRESE OFF CONTROL FOR ZONES INDICATED, COO CONTRACTOR FOR DEVICE MODEL NUMBERS ADDITIONAL REQUIREMENTS.	TT SCENES, RISER, LOWER, ON, RDINATE WITH LIGHT DIMMING
RPD	RELAY PACK WITH 0-10V DIMMING OUTPUT	r
-(OS)-	CEILING MOUNTED OCCUPANCY SENSOR. DUINFRARED AND MICROPHONIC/ULTRASONIC), CONTROL. PROVIDE QUANTITY OF 20A, 120 AND RELAY PACKS AS REQUIRED TO CONTFIXTURES IN ROOM/SPACE ARE TO BE CON	WITH AUXILIARY RELAY FOR HVAC V/277V RATED POWER PACKS ROL SWITCH LEGS INDICATED. ALL
Sm	WALL MOUNTED VACANCY SENSOR, SINGLE (PASSIVE INFRARED AND MICROPHONICS/UL RATED 800W AT 120V AND 1200W AT 277 STAINLESS STEEL COVERPLATE. FACTORY CACCEPTABLE.	TRASONIC), 120/277V. SWITCH IS -
Sw2	SAME AS SM EXCEPT WITH DUAL POLE	
Φ Φ	SINGLE RECEPTACLE DUPLEX RECEPTACLE	
₩ ₩	QUADRUPLEX RECEPTACLE	
<u></u>	DUPLEX RECEPTACLE WITH GROUND FAULT	(GFCI)
GFP	FACELESS GROUND FAULT CIRCUIT INTERRU	
$egin{array}{c} egin{array}{c} \egin{array}{c} \egin{array}{c} \egin{array}{c} \egin{array}{c} \egin{array}{c} \egin{array}$	SAME AS DUPLEX RECEPTACLE EXCEPT CEILING SAME AS DUPLEX RECEPTACLE EXCEPT SHOW W MOUNTED 6" ABOVE WINDOW, COORDINATE WITH	/INDOW TO BE
——————————————————————————————————————	ARCHITECT PRIOR TO INSTALLATION COMBINATION DUPLEX POWER RECEPTACLE	
—————————————————————————————————————	SAME AS DUPLEX RECEPTACLE EXCEPT HORIZON	
Ф	SPLIT RECEPTACLES	
Φ	FLOOR RECEPTACLE	
\bigcirc R	COMMERCIAL GRADE CORD REEL WITH GFCI MOU	INTED TO STEEL STRUCTURE
♡ R	SPECIAL PURPOSE RECEPTACLE - NEMA TO SPECIAL PURPOSE RECEPTACLE - NEMA TO	
	TO STEEL STRUCTURE DUPLEX RECEPTACLE FLOOR MOUNTED	
J	CEILING JUNCTION BOX	
HJ)	WALL JUNCTION	
	PUSH BUTTON STATION (1, 2, OR 3 BUTTO	(NO
	DOOR ACTIVATOR PUSH PLATE ELECTRIC CLOCK OUTLET	
∇	COMBINATION DATA AND TELEPHONE OUTLET	UNLESS_OTHERWISE
•	PHONE OUTLET SAME AS COMBINATION VOICE/DATA (W: WALL MOUNTED AT +48")	NOTED PROVIDE DOUBLE GANG BOX WITH SINGLE MUD
\bigvee	DATA OUTLET	RING AND 3/4"C UP TO CEILING SPACE
TV	TELEVISION OUTLET, DOUBLE GANG BOX WITH AND 1"C TO CEILING SPACE	SINGLE MUD RING
AV	AUDIO/VIDEO OUTLET, DOUBLE GANG BACK TO ABOVE ACCESSIBLE CEILING, TERMINATE INSULATING BUSHING, PROVIDE PULL STRIN	CONDUIT WITH
$\bigcirc \boxed{\bigcirc AV}$	FLOOR MOUNTED THREE GANG (3G) FLUSH RECEPTACLE, A/V & DATA/PHONE COMPAR	
$\bigcirc \nabla$	DUPLEX RECEPTACLE & DATA/PHONE FLUS TWO GANG (2G) COMPLETE WITH FLANGE	
c	CEILING MOUNTED TWO GANG (2G) FLUSH & DATA/PHONE COMPARTMENTS	BOX, DUPLEX RECEPTACLE
F1	MULTI-SERVICE STAMPED STEEL FLUSH FLO WITH (2)-20A DUPLEX RECEPTACLES & (2) DATA COMPARTMENT,
	WIREMÒLD #RFB4 SERIES OR APPROVED È MULTI-SERVICE STAMPED STEEL FLUSH FLO	QUAL BY HUBBELL DOR POKE-THROUGH BOX
F2	- TYPE F2 - WITH (2)-20A DUPLEX RECI COMPARTMENT, WIREMOLD OR APPROVED E	EPTACLES & (2) DATA
PD	FLOOR MOUNTED TWO GANG (2G) FLUSH E POWER AND DATA COMPARTMENTS FOR FU	BOX WITH SEPARATE RNITURE CONNECTION
PD	FIRE RATED FLUSH FLOOR POKE THRU WI'COMPARTMENTS FOR FURNITURE CONNECTION	

		FIRE RATED FLUSH FLOOR		H DUPLEX OR QUAD RECEPTACLE
			EP FLOOR POKE	THRU WITH DUPLEX OR QUAD
	—————————————————————————————————————	EVOLUTION 6 SERIES. JUNCTION BOX FOR FLEXIBLE	E CONNECTION TO	SYSTEMS (P: POWER, D: DATA). PPLIER. FOR NEW WORK PROVIDE
	HD 3 HJ-es	1"C OR 1 1/4"C FOR DATA NOTED. COORDINATE LOCATION	TO ABOVE ACCE	SSIBLE CEILING. UNLESS OTHERWISE
		DISTRIBUTION PANEL	AND COVERILATE	SUITABLE TOK WITH CONNECTION.
		SURFACE MOUNTED LIGHTIN RECESSED MOUNTED LIGHT	•	
	СВ		· · · · · · · · · · · · · · · · · · ·	CE MOUNTED IN NEMA ENCLOSURE
	СВ		EAKER – FLUSH	MOUNTED IN NEMA ENCLOSURE
_		MOTOR - SINGLE PHASE		
		FOR MOTOR APPLICATIONS. LIGHT, LOCKABLE OFF AND APPLICATIONS TO EQUIPMEN APPLICATIONS WHERE OVER	MANUAL SINGLE WITHOUT OVERLO IT NOT REQUIRIN LOADS ARE INTEG	TH PILOT LIGHT, LOCKABLE OFF, PHASE MOTOR SWITCH WITH PILOT DADS FOR DISCONNECT G OVERLOADS AND FOR GRAL TO MOTOR-BASED LOADS. NISHED SPACES. SURFACE MOUNT
		NON-FUSIBLE DISCONNECT	SWITCH	
		FUSIBLE DISCONNECT SWIT		
		THREE PHASE COMBINATION BUS PLUG FUSIBLE DISCON		IBLE MOTOR STARTER
	T	TRANSFORMER	WEET SWITCH	
	С	CONTACTOR		
	M	METER		
	$\xrightarrow{ \cdot }$	GROUND HOMERUN TO LIGHTING PA	NEL	
_	— ст —	CABLE TRAY		
	— PS —□	PLUG-IN STRIP		
c	EF	EXHAUST FAN	EWC	ELECTRIC WATER COOLER
	EDH A	ABOVE COUNTER	AFF WP	ABOVE FINISHED FLOOR WEATHERPROOF
	A/E	ARCHITECT / ENGINEER	RT	RAINTIGHT
	СМ	COFFEE MAKER	UFD	UNDER FLOOR DUCT
	MW	MICROWAVE	FPB	FAN POWER BOX
	НОА	HAND-OFF-AUTOMATIC	DW	DISHWASHER
	PC	PHOTOCELL	GD	GARBAGE DISPOSAL
_	HG UH	HOSPITAL GRADE UNIT HEATER	REF (E)	REFRIGERATOR EXISTING TO REMAIN
_	UON	UNLESS OTHERWISE NOTED		RELOCATED EXISTING
	EG	EQUIPMENT GROUND	IG	ISOLATED GROUND
	Н	HORIZONTALLY MOUNT 6"		BACK SPLASH
GFI o	or GFR	GROUND FAULT CIRCUIT IN POWER POLE VOICE/DATA/		
		AUDIO/VISUAL HEAD END		
_	DR	DRIVER FOR 24V UNDER C		dT
	CR	CARD READER		
	IC	INTERCOM OUTLET	-0	
	(PC) [WPS]	PHOTOELECTRIC CONTROLLE COMBINE PARTITION SENSO		
	WAP	WIRELESS ACCESS PANEL	T.	
	PP	POWER POLE VOICE/DATA/	POWER	
	СР	CONTROL PANEL, PROVIDE	AS PART OF TH	E EQUIPMENT THEY CONTROL
	TS B	TIME SWITCH BELL		
	RB	RADIO ALERT SYSTEM BELL		
	DS	DOOR SWITCH		
	IC	INTERCOM STATION		
	HEPO]	EMERGENCY POWER OFF P		
_	FACP	FIRE ALARM CONTROL PAN		
	NACP NACP	FIRE ALARM ANNUNCIATOR NOTIFICATION APPLIANCE C		
	MC	MICROPHONE		
	S	CEILING MOUNTED SPEAKER	?	
(V		VOLUME CONTROL DIAL		
_	(SD)	SMOKE DETECTOR HEAT DETECTOR		
	(TS)	TAMPER SWITCH		
	FS	FLOW SWITCH		
	(A/V)	OUTDOOR FIRE DEPARTMEN	T CONNECTION -	- AUDIO VISUAL DEVICE
	DH OS	MAGNETIC DOOR HOLDER		
	(SOD)	DUCT SMOKE DETECTOR COMBINATION SMOKE/CO DETE	ECTOR	
	F	MANUAL FIRE ALARM STATI		
	F	FIRE ALARM STROBE		
	F	FIRE ALARM HORN/STROBE		
	-F-	FIRE ALARM HORN/STROBE		INTED
- مله	-(F)-S	FIRE ALARM STROBE - CE		THESE SWARDS AND
		TANDARD SYMBOL LIST AR ON DRAWINGS.	- 20MF OF	IHF2F 21WROF WAX


	ELECTRICAL SHEET INDEX
SHEET	DESCRIPTION
E001	ELECTRICAL LEGEND, SHEET INDEX AND DETAILS
E002	ELECTRICAL SPECIFICATION
E003	ELECTRICAL PANEL SCHEDULES-1
E004	ELECTRICAL PANEL SCHEDULES-2
ED110	DEMOLITION LIGHTING PLAN - LEVEL 1
ED210	DEMOLITION POWER PLAN — LEVEL 1
E110	LIGHTING PLAN - LEVEL 1
E210	POWER PLAN — LEVEL 1

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WSU- DETROIT- UGL 1ST FLOOR STUDENT

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Key Plan:

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Issued for BIDS

BIDS 09/15/2023 ADDENDUM #1 09.28.23

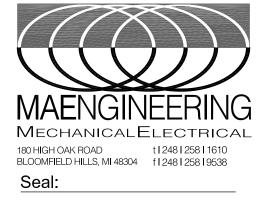ADDENDUM #1 C

Drawn by : LZ

Checked by:

Sheet Title :

ELECTRICAL LEGEND, SHEET
INDEX AND DETAILS

Project No.

Project No.:

2023.111

Sheet No. :

Luurung

ELECTRICAL SPECIFICATION:

GENERAL REQUIREMENTS:

ALL WORK SHALL BE IN ACCORDANCE WITH NATIONAL ELECTRICAL CODE, LATEST EDITION, AND ALL LOCAL AND STATE AUTHORITIES HAVING JURISDICTION THEREOF.

ALL EQUIPMENT SHALL BE SPECIFICATION GRADE AND SHALL HAVE U.L. LABEL FOR INTENDED USE.

ALL REQUIRED PERMIT AND INSPECTIONS SHALL BE OBTAINED BY CONTRACTOR AND SUCH COSTS SHALL BE INCLUDED IN BID PRICE FOR THIS WORK.

AND FUNCTIONING INSTALLATION SUBJECT TO FINAL APPROVAL OF ARCHITECT/ENGINEER.

SYSTEM WITH EQUAL OR GREATER RATING THAN ASSEMBLY. REFER TO ARCHITECTURAL DOCUMENTS FOR RATINGS AND LOCATIONS OF ASSEMBLIES.

EXAMINATION OF SITE IS MANDATORY. CONTRACTOR IS HEREBY HELD TO HAVE EXAMINED THE SITE AND HAVE INCLUDED IN HIS BID PRICE ALL COSTS DUE TO SITE AND FIELD CONDITIONS.

COMPLETE IDENTIFICATION OF PROJECT ELECTRICAL COMPONENTS IS REQUIRED. IDENTIFY ALL PANELS, DISCONNECTS, CONTROL DEVICES, ETC., WITH THE NOMENCLATURE INDICATED ON THE DOCUMENTS AND WITH

TELEPHONE SERVICE TO THE SITE IS EXISTING AND SHALL BE UTILIZED AS INDICATED ON THE DRAWINGS. POWER SOURCE AND ELECTRICAL RATINGS USING PLASTIC LAMINATE NAMEPLATE. INSTALL TYPEWRITTEN DIRECTORIES OF ALL CIRCUITS ON INSIDE OF PANELS. IDENTIFY WIRING DEVICE COVERPLATES WITH PANELBOARD AND BRANCH CIRCUIT NUMBER SERVING DEVICE, E.G. "A-15". PROVIDE ¼" MACHINE-WRITTEN BLACK LETTERING ON CLEAR PLASTIC ADHESIVE TAPE. LOCATE ON BOTTOM FRONT OF COVERPLATE, CENTERED POLARIZED. RECEPTACLES IN GENERAL SHALL BE 20A, 125 V., HUBBELL #HBL5362 OR EQUAL BELOW WIRING DEVICE(S). SUBMIT SAMPLE OF LABELED TAPE WITH WIRING DEVICE/COVERPLATE SUBMITTAL. SAMPLE MAY BE ADHERED TO PAPERWORK IN SUBMITTAL, RATHER THAN TO A COVERPLATE.

PROVIDE TEMPORARY POWER AND LIGHTING DURING CONSTRUCTION. REMOVE TEMPORARY WIRING UPON COMPLETION OF THE PROJECT. TEMPORARY SERVICES SHALL BE AS REQUIRED, BY N.E.C. AND OSHA. CONTRACTOR IS RESPONSIBLE TO MEET WITH UTILITY TO FOR TEMPORARY POWER PROVISION AND ALL REQUIRED SKID UNITS.

GROUND CONTINUITY SHALL BE MAINTAINED THROUGHOUT THE ELECTRICAL SYSTEM. INSTALL EQUIPMENT GROUNDING CONDUCTOR WITH EVERY CIRCUIT.

COORDINATE SIZE AND LOCATION OF ANY REQUIRED ACCESS PANELS IN WALLS OR FINISHED CEILINGS WITH ARCHITECT PRIOR TO INSTALLATION.

UNLESS A LONGER PERIOD IS SPECIFIED IN INDIVIDUAL PARAGRAPHS, PROVIDE A MINIMUM OF ONE YEAR WARRANTY ON ALL ELECTRICAL WORK BEGINNING THE DATE OF FINAL ACCEPTANCE OF THE PROJECT BY THE

SUBMIT SHOP DRAWINGS FOR ALL MAJOR COMPONENTS OR SYSTEMS OF THE PROJECT. SUBMIT ADDITIONAL SHOP DRAWINGS IF REQUESTED BY ENGINEER.

NO APPARATUS OR EQUIPMENT SHALL BE SHIPPED FROM STOCK OR FABRICATED UNTIL ITS SHOP DRAWINGS HAVE BEEN STAMPED 'REVIEWED" OR "APPROVED AS NOTED". SUBMIT DATA REQUIRED FOR TRANSFORMERS SUCH AS EFFICIENCY, REGULATION, CORE LOSS AND SOUND LEVELS. (SEE APPLICABLE SECTIONS).

SUBMIT SYSTEM COMPONENTS. PRODUCT DATA AND SHOP DRAWINGS COMPLETE FOR EACH SYSTEM UNDER ONE SUBMITTAL. DO NOT BREAK OUT EQUIPMENT FOR ONE SYSTEM BETWEEN MULTIPLE SUBMITTALS.

ALL SHOP DRAWINGS MUST BE CLEARLY MARKED TO SHOW EQUIPMENT SUBMITTED AND ANY DEVIATIONS FROM CONDUCTORS SIZED #10 AND SMALLER SHALL BE SOLID. ALL CONDUCTORS LARGER THAN #10 SHALL BE RELEVANT INFORMATION TO SHOW ACTUAL EQUIPMENT SUBMITTED. ELECTRICAL CONTRACTOR MUST SIGN AND HAVE XHHW OR THWN INSULATION. APPROVE ALL SHOP DRAWINGS PRIOR TO SUBMITTAL. UNIQUELY NUMBER EACH PAGE IN SUBMITTAL.

IF DIFFERENT SYSTEMS ARE INCLUDED IN ONE SUBMITTAL, CLEARLY SEPARATE INFORMATION AND PROVIDE DIFFERENT SUB-NUMBERING OF SYSTEMS. SHOP DRAWINGS THAT ARE INCOMPLETE, UNSIGNED AND NOT PLAINLY MARKED WILL NOT BE REVIEWED.

MICHIGAN UNIFORM ENERGY CODE THIS IS A PERFORMANCE BASED DESIGN-BUILD SPECIFICATION AND APPLIES ONLY TO ROOMS WITH NEW

THE INTENT OF THIS SPECIFICATION ITEM IS FOR FULL COMPLIANCE WITH THE REQUIREMENTS OF THE 2015 MICHIGAN UNIFORM ENERGY CODE AND RELATED AMENDMENTS AS THEY APPLY TO THE ASHRAE 90.1-2013 STANDARDS, AUTOMATIC CONTROL APPLIES TO NEW AND TO EXISTING TO REMAIN FIXTURES.

DESIGN AND PROVIDE A COMPLETE LIGHTING CONTROL SYSTEM PER MANUFACTURER'S RECOMMENDATION AND MAGNETIC MOTOR STARTERS SHALL BE 600 VOLT 3-PHASE WITH 3 THERMAL OVERLOAD ELEMENTS, HOA TO COMPLY TO ENERGY CODE AS INDICATED ABOVE, INDICATE ALL COMPONENTS AND EQUIPMENT LAYOUT ON SWITCH AND RESET BUTTON IN COVER AND GREEN RUNNING PILOT LIGHT. NEMA ENCLOSURE AND SIZE AS FLOOR PLANS AND SUBMIT FOR REVIEW AND APPROVAL. COORDINATE WITH ARCHITECTURAL TRADES TO PROVIDE CEILING ACCESS PANELS WHERE REQUIRED.

PROVIDE OCCUPANCY SENSOR(S) IN EVERY ROOM OR SPACE (EXCEPT WHERE TIMER CONTROL IS INDICATED) PROVIDE THERMAL ALLOY MELTING TYPE HEATER ELEMENTS FOR ALL MOTORS BASED ON MOTOR NAMEPLATE TO AUTOMATICALLY SHUTOFF ALL NON-EMERGENCY LIGHTING WITHIN ITS SPACE WITH ADJUSTABLE TIME DELAY DATA.

BY MANUFACTURER FOR EACH SPACE/APPLICATION CEILING MOUNTED.

INCLUDE CONTROL PANEL STARTUP/COMMISSIONING AND TRAINING BY MANUFACTURER'S FACTORY-TRAINED PROVIDE ALL NECESSARY FUSES AND REPLACE ALL THOSE BLOWN DURING CONSTRUCTION. ALL FUSES SHALL PERSONNEL. IN ADDITION TO OTHER STARTUP REQUIREMENTS, MANUFACTURER'S FACTORY REPRESENTATIVE IS BE TIME LAG, DUAL ELEMENT, BUSSMAN "LOW PEAK YELLOW" OR EQUAL. TO OBTAIN OWNER'S DESIRED OPERATIONAL SCHEDULE FOR EACH CIRCUIT, PROGRAM PANEL WITH SITE-SPECIFIC INFORMATION, AND CONTROL LIGHTING FIXTURES PER OWNER'S SCHEDULE IN COMPLIANCE WITH INSTALLATION AND METHODS OF EXECUTION:

PROVIDE OWNER WITH A MINIMUM OF 2 HOURS OF TRAINING AT JOBSITE BY MANUFACTURER'S FACTORY REPRESENTATIVE.

DEMOLITION AND RENOVATION WORK:

MICHIGAN UNIFORM ENERGY CODE.

DISCONNECT, REMOVE, RELOCATE, REWIRE OR DISPOSE OF ANY EQUIPMENT INTERFERING WITH NEW CONSTRUCTION OR AFFECTED BY RENOVATION WORK.

ANY ELECTRICAL EQUIPMENT OR SYSTEMS WHICH ARE TO REMAIN, AND ARE AFFECTED BY THIS WORK, SHALL GALVANIZED STEEL. BE IMMEDIATELY RESTORED TO FULL OPERATING CONDITION AND AT NO ADDITIONAL COST TO THE CONTRACT.

EQUIPMENT REMOVED SHALL BE DISPOSED OF AS DIRECTED, EITHER TO STORAGE OR OFF THE PREMISES.

WHERE SERVICES OR CIRCUITS ARE DISCONNECTED OR DISCONTINUED, IT IS MANDATORY THAT ANY EXISTING UNUSED WIRING BE REMOVED TO THE SOURCE UNLESS SPECIFICALLY NOTED ON THE DRAWINGS. IT IS THE INTENT OF THIS ARTICLE TO PERMANENTLY DISCONNECT ALL UNUSED CIRCUITS AT THE MAIN SOURCE WHENEVER POSSIBLE. NO ENERGIZED CIRCUIT SHALL BE TAPED AND ABANDONED IN OUTLET BOXES UNLESS

REMODELING WORK INVOLVING EXISTING BRANCH CIRCUIT PANELBOARD SHALL BE SUCH THAT, WHEN ALL WORK IS COMPLETED EXISTING PANELS ARE PROVIDED WITH NEW AND UPDATED ACCURATE DIRECTORIES. ALL SURFACE RACEWAY AS REQUIRED FOR WIRING INSTALLED. PROVIDE FLUSH OUTLET BOXES AND CONDUIT AT VACATED CIRCUITS SHALL BE MARKED SPARE. WHEN NEW BREAKERS ARE REQUIRED. THEY SHALL BE INSTALLED IN EXISTING SPACES AND SHALL MATCH THOSE THAT ARE EXISTING, PROVIDE NEW PANELS IF REQUIRED AND WHERE INDICATED.

CONTRACTOR MAY USE EXISTING CONDUITS AND OUTLET BOXES, PROVIDED THEY ARE IN GOOD ELECTRICAL CONDITION AND THE INSTALLATION IS APPROVED BY THE AHJ. RE-SUPPORT EXISTING TO REMAIN CONDUIT AND BOXES IN RENOVATION AREA IF INADEQUATELY SUPPORTED. PROVIDE SUPPORT AS REQUIRED TO COMPLY WIRES FOR THE SUSPENDED CEILING. WITH NEC AND AHJ REQUIREMENTS.

IT IS THE INTENT OF THE OVERALL DESIGN TO CONCEAL ALL WORK EXCEPT IN UNFINISHED AREAS. CUT AND HORIZONTAL DISTANCE OF TWENTY FOUR (24) INCHES. PATCH EXISTING SURFACES AS REQUIRED FOR A CONCEALED INSTALLATION.

SUITABLE BLANK COVER PLATES. ABANDONED FLOOR OUTLETS AND PENETRATIONS SHALL BE FILLED TO MATCH RESISTANCE RATING PER ARTICLE 300.21 2017 NEC. EXISTING SURROUNDING CONDITIONS.

CONDUITS AND OTHER PARTS OF ELECTRICAL SYSTEMS THAT BECOME EXPOSED AS A PART OF NEW WORK SHALL BE REMOVED AS REQUIRED TO A POINT WHERE THE ABANDONED PORTION IS TOTALLY CONCEALED. ALL SURFACES DAMAGED BY THIS CONTRACTOR IN THE COURSE OF PERFORMING WORK SHALL BE RESTORED TO SATISFACTORY CONDITION, AS DIRECTED BY THE ARCHITECT AND ALL COSTS OF REPAIRS SHALL BE PAID FOR BY THE CONTRACTOR

ELECTRICAL SYSTEMS SHALL BE COMPLETE IN EVERY DETAIL, INCLUDING ALL INCIDENTAL ITEMS FOR A PROPER REMOVE SERVICE TO MECHANICAL, ELECTRICAL AND BUILDING EQUIPMENT SPECIFIED AND/OR INDICATED AS REMOVED OR DISCONNECTED. MAINTAIN CIRCUITS TO EXISTING-TO-REMAIN EQUIPMENT. IDENTIFY UNUSED, REMOVED CIRCUITS ON PANEL SCHEDULE AS SPARE. COORDINATE WITH ARCHITECTURAL, MECHANICAL AND ELECTRICAL DRAWINGS FOR EXISTING TO REMAIN EQUIPMENT AND FOR DEMOLITION WORK.

SERVICE SHUTDOWN AND POWER OUTAGES SHALL BE SCHEDULED WITH THE OWNER PRIOR TO PERFORMING PROVIDE UL LISTED SYSTEM FOR FIRE STOPPING PENETRATIONS THROUGH FIRE RATED ASSEMBLIES. PROVIDE ANY WORK ON EXISTING SERVICE. SCHEDULE SHALL BE PROVIDED IN WRITING 72 HOURS IN ADVANCE AND SHALL SHOW A DETAILED DESCRIPTION OF THE PROPOSED WORK AND THE DURATION OF OUTAGE.

PROVIDE LUMINAIRE DISCONNECTING MEANS PER LIGHTING SPECIFICATIONS.

<u>UTILITY SERVICES (EXISTING BUILDING):</u> ELECTRIC SERVICE TO THE SITE IS EXISTING AND SHALL BE UTILIZED AS INDICATED ON THE DRAWINGS.

<u>LECTRICAL EQUIPMENT AND DEVICES:</u> RECEPTACLES SHALL BE SPECIFICATION GRADE, GROUNDING TYPE, 2-POLE, 3-WIRE, AND MOUNTED 16" AFF IN OFFICES AREAS.CLES DESIGNATED "GFR" SHALL BE GROUND FAULT RECEPTACLES, SIMILAR TO HUBBELL #GF-5362.

SWITCHES SHALL BE SINGLE POLE, TWO POLE, OR THREE-WAY, AS INDICATED, TOGGLE TYPE, 20A, 120/277V., QUIET TYPE, HUBBELL #1221/1222/1223 OR APPROVED EQUAL. PILOT TYPE SWITCHES HUBBELL

PROVIDE DIMMERS RATED FOR LOAD WATTAGE AND VOLTAGE CONTROLLED. CONTRACTOR TO COORDINATE RATING BASED ON APPROVED FIXTURE SUBMITTALS AND ACTUAL FIXTURE QUANTITIES. PROVIDE DIMMERS DESIGNED FOR CONTROLLED LOAD CONSULT LIGHT FIXTURE MANUFACTURER FOR COMPATIBLE DIMMER

WIRING DEVICE COLORS SHALL BE WHITE OR AS SELECTED BY OWNER/ARCHITECT.

DEVICE COVER PLATES SHALL BE OF TYPE AND NUMBER OF GANGS FOR DEVICES INSTALLED, SMOOTH EDGED 302/304 GRADE BRUSHED STAINLESS STEEL. PROVIDE BRANCH CIRCUIT IDENTIFICATION ON ALL COVERPLATES AS SPECIFIED UNDER "GENERAL REQUIREMENTS". COVERPLATES FOR DEVICES CONNECTED TO THE EMERGENCY SYSTEM SHALL ALSO BE FACTORY LABELED WITH BLACK LETTERING TO READ "EMERGENCY".

TWO GANG OUTLET BOX WITH PLASTER RING AND NO COVER PLATE. JACK AND COVER PLATE ARE SUPPLIED INSPECTION. BY OTHERS. HEIGHT OF OUTLET FOR DESK PHONE IS 16" AFF AND FOR WALL PHONE 48" AFF. TELEPHONE/DATA OUTLETS SHALL CONTAIN OF 3/4" CONDUIT FROM OUTLET TO AN ACCESSIBLE PORTION OF CEILING SPACE. TERMINATE WITH INSULATING BUSHING.

ALL CONDUCTORS SHALL BE SOFT-DRAWN COPPER OF SIZES INDICATED ON THE DRAWINGS. ALL CONDUCTORS SHALL BE INSULATED FOR 600 VOLTS AND WITH 75 DEGREES (CENTIGRADE) CODE GRADE

SPECIFICATIONS SHALL BE NOTED THEREON. DO NOT INCLUDE ONLY MODEL NUMBERS TO INDICATE SUBMITTED MADE UP OF STRANDED SINGLE CONDUCTOR CABLE. CONDUCTORS SHALL HAVE THWN OR THHN INSULATION EQUIPMENT. STRIKE OUT ANY INFORMATION ON PRODUCT DATA THAT IS NOT PROJECT SPECIFIC, AND EDIT AS APPLICABLE. CONDUCTORS IN UNDERGROUND CONDUIT AND FOR SERVICE ENTRANCE CONDUCTOR SHALL

#12 AWG SHALL BE THE MINIMUM WIRE SIZE ALLOWED EXCEPT #14 AWG MAY BE USED FOR CONTROL

TYPICAL BRANCH CIRCUITS FROM 20A, 1-POLE BRANCH OVER CURRENT DEVICES

ARE 1/2"C, 2#12 AND 1#12G.

STARTERS, SAFETY SWITCHES, FUSES AND HEATERS: MANUAL MOTOR STARTERS SHALL BE 600V TOGGLE TYPE WITH THERMAL OVERLOAD ELEMENT FOR MOTOR PROTECTION STAINLESS STEEL COVER PLATE AND PILOT LIGHT; FLUSH IN ALL AREAS EXCEPT IN UNFINISHED SPACES, CONTRACTOR TO COORDINATE AND PROVIDE QUANTITY OF POLES AS REQUIRED FOR BRANCH CIRCUIT AND LOAD SERVED. MANUAL MOTOR SWITCHES SHALL BE THE SAME AS MANUAL STARTERS EXCEPT WITHOUT OVERLOADS AND USED AS DISCONNECTING MEANS.

INDICATED. COMBINATION STARTERS SHALL HAVE BUILT-IN FUSED DISCONNECT. PROVIDE START-STOP PUSH BUTTONS FOR USE IN HAND (MANUAL) MODE.

SAFETY AND DISCONNECT SWITCHES SHALL BE 250 OR 600 VOLTS AS REQUIRED, HEAVY DUTY, TWO OR THREE POLE. "OUICK-MAKE'. "OUICK-BREAK" SWITCH MECHANISM AND COVER INTERLOCK. SWITCHES SHALL OCCUPANCY SENSORS SHALL BE OF ULTRASONIC, INFRARED OR MULTI-TECHNOLOGY TYPE AS RECOMMENDED BE FUSED OR UNFUSED AS INDICATED AND SHALL HAVE PAD LOCK PROVISIONS, WITH NEMA TYPE ENCLOSURE GAMEWELL FOR LOCATION USED. SWITCHES SHALL BE SQUARE "D"CLASS 3110 OR APPROVED EQUAL.

ALL WIRING SHALL BE IN CONDUIT, MINIMUM ½". FLEXIBLE METAL CONDUIT SHALL BE USED FOR SHORT CONNECTION TO MOTORS, FINAL CONNECTION TO RECESSED LIGHTING FIXTURES FROM RIGIDLY MOUNTED OUTLET BOX (NOT BETWEEN FIXTURES), VIBRATING EQUIPMENT, ETC., BUT NEVER LONGER THAN 6 FEET. PROVIDE LIQUID TIGHT FLEXIBLE METAL CONDUIT FOR ALL APPLICATIONS EXPOSED TO WATER OR WEATHER. PROVIDE ANTI-SHORT BUSHINGS FOR ALL FLEXIBLE CONDUIT ARMOR TERMINATIONS. PROVIDE SEPARATE

EQUIPMENT GROUND WIRE IN ALL CONDUIT RUNS. CONDUIT CONCEALED IN CEILING, WALLS OR FURRED SPACES OR EXPOSED IN DRY LOCATIONS SHALL BE EMT, CONFORM TO STATE AND LOCAL FIRE CODES THIN WALL ELECTRIC METALLIC TUBING. CONDUIT EXPOSED TO WEATHER, IN CONTACT WITH CONCRETE, BURIED CONFORM TO RULES AND REQUIREMENTS OF LOCAL GOVERNING BODY. IN SLAB, OR IN HAZARDOUS AREAS, SHALL BE HEAVY WALL, RIGID. ALL CONDUITS SHALL BE HOT DIPPED

CONDUIT RUNS SHOWN ON DRAWINGS ARE DIAGRAMMATIC. EXACT ROUTING OF CONDUIT RUNS SHALL SUIT

JOB CONDITIONS. EXPOSED CONDUIT SHALL BE RUN ONLY IN UNFINISHED AREAS SUBJECT TO FINAL

REGARDING THE REQUIREMENT FROM ONE MANUFACTURER TO ANOTHER.

APPROVAL OF ENGINEER AND SHALL RUN PARALLEL TO BUILDING LINES, NEVER DIAGONALLY. CONNECTION TO EQUIPMENT SHALL BE DONE IN ACCORDANCE WITH MANUFACTURER'S SHOP AND INSTALLATION PRODUCTS: DRAWINGS. REQUIREMENTS GENERALLY VARY FROM ONE MANUFACTURER TO ANOTHER AND CONTRACTOR IS BOUND TO COMPLY AND PROVIDE ALL WORK AS REQUIRED ALTHOUGH CERTAIN DISCREPANCIES MAY EXIST

FINAL CONNECTIONS, INCLUDING TESTING OF MOTORS FOR PROPER ROTATION.

OUTLET BOXES MAY-BE SURFACE MOUNTED ON EXISTING WALLS (CMU, BRICK OR CONCRETE) WITH SMALLEST NEW CONSTRUCTION WALL AND AT EXISTING WALLS WHICH ARE NOT CMU BRICK OR CONCRETE CONSTRUCTION. CUT AND PATCH EXISTING WALLS AS REQUIRED FOR FLUSH INSTALLATION.

PROVIDE 4" TALL CONCRETE HOUSEKEEPING PADS FOR ALL FLOOR MOUNTED ELECTRICAL EQUIPMENT. ALL WIRING LOCATED ABOVE THE SUSPENDED CEILING MUST BE SUPPORTED INDEPENDENTLY OF THE SUPPORT

OUTLET BOXES ON OPPOSITE SIDES OF FIRE RESISTANT WALLS OR PARTITIONS SHALL BE SEPARATED BY A

ELECTRICAL OPENINGS AROUND ELECTRICAL PENETRATIONS THROUGH FIRE RESISTANT RATED WALLS, ALL ELECTRICAL OPENINGS THAT ARE ABANDONED IN WALLS. CEILINGS OR FLOOR SHALL BE PROVIDED WITH PARTITIONS, FLOORS, OR CEILINGS SHALL BE FIRESTOPPED USING APPROVED METHODS TO MAINTAIN THE FIRE ALARM HORNS/SPEAKERS:

PROVIDE PROPER WORKING CLEARANCES FOR ELECTRICAL EQUIPMENT AS REQUIRED PER NEC.

LIGHTING SPECIFICATIONS:

SYSTEM DESIGN

LED LIGHTING FIXTURES SHALL HAVE 5 YEAR WARRANTY, A COLOR RENDERING INDEX OF 90 OR HIGHER 3500K COLOR TEMPERATURE UNLESS OTHERWISE INDICATED ON DRAWINGS, LIFETIME: 50,000 HOURS OR GREATER AND MAINTAIN AT LEAST 70% OF INITIAL LUMEN OUTPUT. RATED FOR OUTDOOR USE AND WET LOCATION, IF IN OPEN FIXTURE.

SHALL POSSESS COLOR MANAGEMENT SYSTEM TO MAINTAIN COLOR CONSISTENCY OVER TIME AND TEMPERATURE OF NO GREATER THAN ±100K OVER LIFE.

REFER TO LIGHTING FIXTURE SCHEDULE ON ARCHITECTURAL REFLECTED CEILING PLANS FOR LED FIXTURES WITH DIMMING CONTROLS.

LED DRIVERS TO BE ELECTRONIC, HIGH POWER FACTOR, MIN. 0.9; UNIVERSAL VOLTAGE 120-277V; 5 YEAR WARRANTY, COMPATIBLE WITH THE LED LAMP OR MODULE USED. FIRE ALARM SYSTEM - PERFORMANCE SPECIFICATION:

A/E WILL ONLY SHOW EXISTING DEVICES ON PLANS FOR REFERENCE ONLY. SYSTEM'S QUALITY AND PERFORMANCE SHALL BE AS COVERED IN THESE SPECIFICATIONS.

SCOPE OF WORK: MODIFY EXISTING FIRE ALARM SYSTEM COVERAGE INCLUDING RELOCATING AND/OR ADDING DEVICES IN AREA OF RENOVATION FOR A COMPLETE, FUNCTIONING AND APPROVED INSTALLATION INCLUDING BUT NOT LIMITED TO THE FOLLOWING MAJOR ITEMS:

DEVICE LOCATION BATTERY CALCULATIONS CIRCUIT VOLTAGE DROP CALCULATIONS. BUILDING PLANS WITH LOCATION OF ALL DEVICES AND EQUIPMENT. INTERFACE WITH OTHER SYSTEMS OR EQUIPMENT. FIRE CURTAINS AND SMOKE BARRIERS, FIRE AND SMOKE DAMPERS. FIRE SUPPRESSION SYSTEM.

ANY OTHER FIRE RELATED DEVICES OR EQUIPMENT.

SYSTEM RISER. LEGEND FOR ALL DEVICES AND EQUIPMENT SHOWN ON PLANS AND RISER. SYSTEM OPERATION MATRIX AND AS REQUIRED FOR FULL COMPLIANCE WITH REQUIREMENTS OF NFPA 72 AND APPLICABLE LOCAL, STATE AND NATIONAL RULES AND REGULATIONS.

EMPLOY THE SERVICES OF A QUALIFIED CERTIFIED FIRE ALARM CONTRACTOR/CONSULTANT TO PREPARE THE SYSTEM DESIGN AND RELATED CONSTRUCTION DOCUMENTS INCLUDING ALL RELATED CALCULATIONS, DEVICE PROTECTION INSTALLER FULLY COMPLETE WITH ALL INFORMATION AND RELATED DATA, AS REQUIRED, TO OBTAIN SYSTEM APPROVAL BY THE AUTHORITIES HAVING JURISDICTION. DETERMINE THE APPLICABLE PROVIDE TELEPHONE/DATA OUTLETS AND STUBS AS INDICATED. TELEPHONE/DATA OUTLETS SHALL CONSIST OF AUTHORITIES HAVING JURISDICTION FOR PROJECT AND INCLUDE ALL IN PLAN REVIEW, PERMITTING, AND

> SURVEY EXISTING CONDITIONS PRIOR TO BID. COORDINATE WORK WITH BUILDING FINISHES AND WITH OTHER WORK BEING PERFORMED.

PROVIDE SYSTEM TESTING AND CORRECT ALL DEFECTS PRIOR TO FINAL DEMONSTRATION AND OWNER ACCEPTANCE.

PROVIDE FOUR (4) HOURS OF TRAINING IN OPERATION AND MAINTENANCE FOR TWO PERSONS AS SELECTED BY THE OWNER/USER.

SUBMITTALS TO THE AUTHORITIES HAVING JURISDICTION (AHJ) THE FOLLOWING DOCUMENTS SHALL BE SUBMITTED FOR REVIEW PRIOR TO INSTALLATION:

LOCATION OF CONTROL AND ANNUNCIATION EQUIPMENT. LOCATION OF INITIATING DEVICES AND ALARM INDICATING APPLIANCES ON PLANS. POWER CONNECTION.

SYSTEM RISER DIAGRAM. DEVICE CIRCUITING ON PLANS AND OR RISER.

BATTERY CALCULATIONS. CIRCUIT CONDUCTORS, TYPE AND SIZE

VOLTAGE DROP CALCULATION FOR EVERY CIRCUIT WITH THE 25% SPARE CAPACITY INCLUDED. INTERFACE WITH OTHER SYSTEMS OR EQUIPMENT (CONTROL FUNCTIONS) AS REQUIRED, SPECIFIED OR

SYSTEM MATRIX FOR EVENTS (FUNCTIONAL MATRIX). MANUFACTURER DATA, CUTS, SHEETS, LISTING AND ALL RELATED INFORMATION FOR THE EQUIPMENT AND MAKE ALL REVISIONS OR CHANGES NECESSARY TO MAINTAIN FINAL APPROVAL AT NO EXTRA COST TO OWNER. DEVICES PROVIDED FOR THE SYSTEM.

ARCHITECTS/ENGINEERS REVIEW: ARCHITECT/ENGINEER WILL REVIEW SYSTEM DOCUMENTS AFTER THEY HAVE BEEN APPROVED BY LOCAL AUTHORITY. INCLUDE PROOF OF LOCAL AUTHORITY APPROVAL WITH A/E SUBMITTAL. REVIEW WILL COVER GENERAL COMPLIANCE WITH PROJECT REQUIREMENTS AND THE INTENT OF THESE

SPECIFICATIONS. SUGGESTED CONSULTANTS/CONTRACTORS: SIEMENS FIRE SAFETY

SIMPLEX/GRINNELL **CODES AND STANDARD:** NFPA 72 - NATIONAL FIRE ALARM CODE NFPA 101 - LIFE SAFETY CODE NEC 760 - FIRE PROTECTIVE SIGNALING SYSTEMS NEC 725 - SIGNALING AND POWER LIMITED CIRCUITS

JOHNSON CONTROLS

NATIONAL TIME AND SIGNAL

LOCAL ORDINANCES AS APPLICABLE REGULATORY REQUIREMENTS: CONFORM TO REQUIREMENTS OF NATIONAL FIRE CODE (NFC). A.D.A. FEDERAL GUIDELINES

PROVIDE ELECTRONICALLY SUPERVISED SYSTEM, WITH SUPERVISED ALARM INITIATING AND ALARM SIGNALING CIRCUITS, OCCURRENCE OF SINGLE GROUND OR OPEN CONDITION IN INITIATING OR SIGNALING CIRCUIT PLACES. CIRCUIT IN TROUBLE MODE. OCCURRENCE OF SINGLE GROUND CONDITION ON ALARM INITIATING OR SIGNALING CIRCUIT DOES NOT DISABLE THAT CIRCUIT FROM TRANSMITTING AN ALARM.

THE FOLLOWING IS INTENDED TO ESTABLISH GENERAL QUALITY OF SYSTEM BUT NOT INTENDED TO LIMIT SYSTEM DESIGN OR EXCLUDE ANY REQUIRED DEVICES.

FIRE ALARM CONTROL PANELS: CIRCUIT TRACE EXISTING TO REMAIN CIRCUITS AS NECESSARY FOR PROPER IDENTIFICATION, AND AS REQUIRED PROVIDE POWER WIRING, DISCONNECTS, AND PROTECTION DEVICES TO ALL MECHANICAL EQUIPMENT AND MAKE PROVIDE FLUSH MOUNTED MAIN FIRE ALARM CONTROL PANEL AND REMOTE FIRE ALARM CONTROL PANEL. COORDINATE PANEL FINISH WITH ARCHITECT. COORDINATE MOUNTING LOCATIONS WITH ARCHITECT AND WITH

> SEMI FLUSH, ADDRESSABLE AND WITH PRIORITY ALARM MODULES. MANUAL STATIONS SHALL BE INDIVIDUALLY IDENTIFIABLE BY THE FIRE ALARM CONTROL PANEL.

REMOTE INTERFACE MODULES: ADDRESSABLE, PROGRAMMABLE INTERFACE MODULES AS REQUIRED TO MONITOR, CONTROL AND INITIATE REQUIRED FIRE ALARM FUNCTIONS.

SMOKE DETECTORS: (INTELLIGENT ANALOG ADDRESSABLE) PHOTOELECTRIC, LISTED FOR USE AS OPEN AREA PROTECTIVE COVERAGE AND SHALL BE INSENSITIVE TO AIR VELOCITY CHANGES. DETECTORS SHALL BE OPERATIONAL WITH RELAY BASES, AUDIBLE BASES, AND REMOTE INDICATING LED'S PROGRAMMABLE BY THE CONTROL PANEL.

ALARM HORNS/SPEAKERS FULLY ENCLOSED AND DUSTPROOF. DESIGNED TO BE MOUNTED ON A WALL WITH ENTIRE LENS NOT LESS THAN 80" AFF AND NOT GREATER THAN 96" AFF. MOUNT ALL DEVICES AT THE SAME

FLUSH BACK BOXES, COMPLYING WITH A.D.A. GUIDELINES FOR LIGHT INTENSITY AND THE FOLLOWING:

VISUAL SIGNALS SHALL BE MOUNTED AT A HEIGHT OF MAXIMUM 80 INCHES ABOVE FINISH FLOOR LEVEL, OR SIX INCHES BELOW CEILING LEVEL WHICHEVER IS LOWER. SYNCHRONIZE DEVICES WHEN MULTIPLE DEVICES ARE WITHIN THE SAME LINE OF SIGHT.

DEVICES SUCH AS MAGNETIC DOOR HOLDERS, WATER FLOW SWITCHES, TAMPER SWITCHES AND THE LIKE SHALL BE PROVIDED AS REQUIRED.

PROVIDE DETECTORS FOR ALL AIR HANDLING UNITS AS REQUIRED. PHOTOELECTRIC LISTED FOR USE IN DUCT DETECTION. INSENSITIVE TO AIR VELOCITY CHANGES CAPABLE OF SENSITIVITY TESTED AFTER REMOVAL FROM BASES.

THE SYSTEM AS DESCRIBED SHALL BE INSTALLED, TESTED, AND APPROVED BY THE AHJ. THE SYSTEM SHALL INCLUDE ALL THE REQUIRED HARDWARE, RACEWAYS, INTERCONNECTING WIRING AND SOFTWARE TO ACCOMPLISH THE INTENT OF THESE SPECIFICATIONS AND THE CONTRACT DOCUMENTS, WHETHER OR NOT SPECIFICALLY

ALL EQUIPMENT FURNISHED SHALL BE NEW AND INCLUDE THE LATEST STATE OF THE ART PRODUCTS FROM A SINGLE MANUFACTURER, ENGAGED IN THE MANUFACTURING AND SALE OF FIRE DETECTION SYSTEMS FOR OVER FIVE YEARS. THE INSTALLING CONTRACTOR SHALL CONTRACT WITH A SINGLE SOURCE FOR SUPPLYING DEVICES/MATERIALS, SERVICES, AND PROGRAMMING, INCLUDING FINAL INSPECTION/TEST SERVICES FOR THE FIRE ALARM SYSTEM.

CONTROL AND OTHER PANELS SHALL BE MOUNTED WITH SUFFICIENT CLEARANCE FOR OBSERVATION AND

FIRE ALARM PULL STATIONS AND HORNS INSTALLED IN FINISHED AREAS SHALL BE MOUNTED SEMI-FLUSH AND MAY BE SURFACE MOUNTED IN EXISTING AND NON-FINISHED AREAS. SMOKE DETECTORS AND THERMAL PLACEMENT; AND INCLUDE COORDINATION WITH OTHER SUPPLIERS/CONTRACTORS SUCH AS DESIGN-BUILD FIRE DETECTORS SHALL BE MOUNTED ON A RECESS MOUNTED JUNCTION BOX IN FINISHED AREAS AND TO SURFACE

> INSTALL MANUAL STATION FLUSH MOUNTED WITH OPERATING HANDLE 48 INCHES ABOVE FLOOR. INSTALL AUDIBLE AND VISUAL SIGNAL DEVICES NO MORE THAN 80 INCHES ABOVE HIGHEST FLOOR LEVEL OR 6 INCHES

MOUNT OUTLET BOX FOR ELECTRIC DOOR HOLDER TO WITHSTAND 80 POUNDS PULLING FORCE.

ALL FIRE ALARM WIRING SHALL BE RUN IN A DEDICATED RACEWAY SYSTEM APPROVED BY THE AHJ. WITH APPROVAL OF LANDLORD AND THE AHJ, PLENUM RATED WIRING MAY BE RUN WITHOUT RACEWAYS ABOVE ACCESSIBLE FINISHED CEILINGS. WHERE EXPOSED RACEWAY IS PERMITTED BY ARCHITECT IN FINISHED SPACES, SUCH AS IN EXISTING CONSTRUCTION, COORDINATE APPROVAL OF RACEWAY TYPE, ROUTING AND FINISH WITH THE AHJ AND WITH

NO WIRING OTHER THAN THAT DIRECTLY ASSOCIATED WITH FIRE ALARM DETECTION, ALARM OR AUXILIARY FIRE PROTECTION FUNCTIONS SHALL BE PERMITTED IN FIRE ALARM CONDUITS. WIRING SPLICES ARE TO BE AVOIDED TO THE EXTENT POSSIBLE, AND IF NEEDED THEY MUST BE MADE ONLY IN JUNCTION BOXES AND SHALL BE CRIMP CONNECTED. TRANSPOSING OR CHANGING COLOR CODING OF WIRE SHALL NOT BE PERMITTED. ALL CONDUCTORS IN CONDUIT CONTAINING MORE THAN ONE WIRE SHALL BE LABELED AND HARNESSED SO THAT EACH DROPS OFF DIRECTLY OPPOSITE TO ITS TERMINAL. ALL WIRING SHALL BE CHECKED AND TESTED TO INSURE THAT THERE ARE NO GROUNDS, OPENS, OR SHORTS.

MINI HORNS WHEN USED FOR LIVING UNITS SHALL BE RATED 90DB AT 10' AND SHALL MOUNT TO A SINGLE GANG BOX.

XENON STROBE WITH MINIMUM REPETITION RATE OF 1 HZ, NOT EXCEEDING 3 HZ AND A MAXIMUM DUTY CYCLE OF 40% WITH A PULSE DURATION OF .2 SECONDS. UNFILTERED OR CLEAR WHITE LIGHT.

REMOTE INDICATING LED PROGRAMMABLE (RESETTABLE) FROM CENTRAL PANEL. (WALL OR CEILING MOUNTED -COORDINATE WITH ARCHITECT).

ITEMIZED HEREIN.

TESTING. ALL FIRE ALARM JUNCTION BOXES MUST BE CLEARLY MARKED FOR EASY IDENTIFICATION.

MOUNTED JUNCTION BOXES IN NON-FINISHED AREAS.

BELOW THE CEILING, WHICHEVER IS LOWER.

TESTING, APPROVAL AND CERTIFICATION: FIRE ALARM SYSTEM SHALL BE TESTED IN PRESENCE OF LOCAL INSPECTING AUTHORITY AND TEST REPORT OF RESULTS SHALL BE FILED WITH OWNER/ARCHITECT/ENGINEER AS PART OF SYSTEMS DOCUMENTATION.


PROVIDE ALL PERSONNEL AND MATERIALS REQUIRED FOR SYSTEM TESTING.

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WSU- DETROIT- UGL 1ST FLOOR STUDENT

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Key Plan:

5155 GULLEN MALL DETROIT MI 48202

ADDENDUM #1

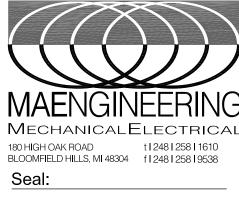09/15/2023

09.28.23

Issued for

Drawn by

Checked by:

Sheet Title: ELECTRICAL SPECIFICATION

Project No :

Sheet No.

	VOL ⁻	TAGE: MAIN: ATION:	RP-12 (EXISTING BEFORE DEMO) 208Y/120V, 3 PHASE, 4 WIRE + G 400 A MCB ELECTRICAL ROOM MOUNTING: SURFACE AIC: EXISTING FEEDER: EXISTING SPD EQUIPPED: YES			
Isolat Circ		ound E aker	Bus Load Information	Co	nnected W	atts
No	Pole	Trip	Location Description Code		Phase B	
3	1		FL.PLUG 24HR.ST.(1300)COL.U14 FL.PLUG 24HR.ST.(1300)COL.U14			
5	1	20	FL.PLUG 24HR.ST.(1300)COL.T15			
7 5	1		FL.PLUG 24HR.ST.(1300)COL.T15 FL.PLUG 24HR.ST.(1300)COL.T16			
11	1		FL.PLUG 24HR.ST.(1300)COL.T16 FL.PLUG 24HR.ST.(1300)COL.T16			
13	1	20	FL.PLUG 24HR.ST.(1300)COL.T17			
15 17	1		FL.PLUG 24HR.ST.(1300)COL.T17 SPARE			
19	1	20	SPARE			
21	1		SPARE FL.PLUG 24HR.ST.(1300)COL.R15			
25	1	20	FL.PLUG 24HR.ST.(1300)COL.R16			
27 2 9	1		FL.PLUG 24HR.ST.(1300)COL.R17			
31	1		FL.PLUG 24HR.ST.(1300)COL.Q15 FL.PLUG 24HR.ST.(1300)COL.Q16			
33	1	20	FL.PLUG 24HR.ST.(1300)COL.Q17			
35 37	1		FL.PLUG 24HR.ST.(1300)COL.P15 FL.PLUG 24HR.ST.(1300)COL.P15			
35	1	20	FL.PLUG 24HR.ST.(1300)COL.P15			
41 43	1	-	FL.PLUG 24HR.ST.(1300)COL.P16 FL.PLUG 24HR.ST.(1300)COL.P16			
45	1		FL.PLUG 24HR.ST.(1300)COL.P16 FL.PLUG 24HR.ST.(1300)COL.P16			
47	1	20	FL.PLUG 24HR.ST.(1300)COL.P17			
49 51	1		FL.PLUG 24HR.ST.(1300)COL.P17 FL.PLUG 24HR.ST.(1300)COL.P17			
53	1	20	FL.PLUG 24HR.ST.(1300)COL.P17			
55 57	1		FL.PLUG 24HR.ST.(1300)COL.P17 FL.PLUG 24HR.ST.(1300)COL.P17			
59	1		FL.PLUG 24HR.ST.(1300)COL.P17 FL.PLUG 24HR.ST.(1300)COL.P17			
61	1		MENS BATHROOM HAND DRYER			
63 65	1		WOMENS BATHROOM HAND DRYER SPARE			
67	1	20	SPARE			
69 71	1		SPARE SPARE	en ediniska edne en en stadunatida dahidindera en		
73	1	20	SPARE			
75 77	1		SPARE SPARE	***************************************		
79	1		SPARE			
81	1		SPARE			
83	1		SPARE OFFICE(1242)			
4	1	20	DIRECTED RESEARCH(1243)			
6 8	1		OFFICE(1242) FL.PLUG 24HR.ST.(1300)COL.R13			
18	1	20	FL.PLUG 24HR.ST.(1300)COL.R13			
12 14	1		FL.PLUG 24HR.ST.(1300)COL.R13 FL.PLUG 24HR.ST.(1300)COL.R13			
16	1		FL.PLUG 24HR.ST.(1300)COL.R13	<u></u>		
18	1	-	FL.PLUG 24HR.ST.(1300)COL.R13			
20 22	1		FL.PLUG 24HR.ST.(1300)COL.Q13 FL.PLUG 24HR.ST.(1300)COL.Q13			
24	1	20	FL.PLUG 24HR.ST.(1300)COL.P13			
26 2 0	1		FL.PLUG 24HR.ST.(1300)COL.P13 FL.PLUG 24HR.ST.(1300)COL.P13			
30	1	20	FL.PLUG 24HR.ST.(1300)COL.P13			
32 34	1		FL.PLUG 24HR.ST.(1300)COL.P13 FL.PLUG 24HR.ST.(1300)COL.P13			
36	1		FL.PLUG 24HR.ST.(1300)COL.P13 FL.PLUG 24HR.ST.(1300)COL.P13			
38	1		FL.PLUG 24HR.ST.(1300)COL.P13			
40 42	1		FL.PLUG 24HR.ST.(1300)COL.P13 FL.PLUG 24HR.ST.(1300)COL.P13			1
44	1	20	FL.PLUG 24HR.ST.(1300)COL.P13			
48 48	1		FL.PLUG 24HR.ST.(1300)COL.P13 SPARE	***************************************		
50	1	20	SPARE			
52 54	1		SPARE SPARE			
56	1		SPARE			
58	1		SPARE			
60 62	1	20 20	SPARE SPARE			
64	1	20	SPARE			
6 0	1		SPARE SPARE			
70	1	20	SPARE			
72	1		SPARE SPARE			
74 7 0	1		SPACE SPACE			
78	1	20	SPACE			1
80 82	1		SPACE SPACE			
84	1	20	SPACE	***************************************		
			CONNECTED KW: 0 CONNECTED AMPS: 0 Phase Watts: DEMAND KW: 0 DEMAND AMPS: 0	0	0	

Circ No 1 3 5	ed Gr	ATION:	400 A MCB FEEDER: EXISTING ELECTRICAL ROOM SPD EQUIPPED: YES	,		
Circ No 1 3 5						
No 1 3 5	Rro	ouna I	Bus			
1 3 5		aker	Load Information		nnected W	
3 5	Pole 1		Location Description Code SPARE	Phase A	Phase B	Phase
5	1		SPARE			
	1	20	SPARE			
7	1		SPARE			
5	1		SPARE			
11 13	1		SPARE SPARE			
15	1		SPARE			
17	1		SPARE			
19	1	20	SPARE			
21	1		SPARE			
23 25	1		SPARE SPARE			
27	1		SPARE			
29	1		SPARE			•
31	1	20	SPARE			
33	1		SPARE			
35	1		SPARE			
37 35	1		SPARE SPARE	-		
41	1		SPARE			1
43	1		SPARE			
45	1	20	SPARE			
47	1		SPARE			
49 51	1		SPARE	 		
51	1		SPARE SPARE			1
55	1		SPARE			
57	1	20	SPARE			
59	1		NEW CONFERENCE ROOM IG RECEPTACLES			
61 63	1		MENS BATHROOM HAND DRYER WOMENS BATHROOM HAND DRYER			
65	1		SPARE			•
67	1	20	SPARE			
69	1	20	SPARE			
71 73	1		SPARE SPARE			
75	1		SPARE			
77	1	20	SPARE			
79	1		SPARE			
81 83	1		SPARE SPARE			-
2	1		OFFICE(1242)			
4	1	20	DIRECTED RESEARCH(1243)			
6	1		OFFICE(1242)			
8 18	1		SPARE SPARE			
12	1		SPARE			1
14	1		SPARE			
16	1	20	SPARE			
18	1		SPARE			
20 22	1		SPARE	-		
24	1		SPARE SPARE			1
20	1		SPARE			1
28	1	20	SPARE]
30	1		SPARE			
32 34	1		SPARE	<u> </u>		
34	1		SPARE SPARE			1
38	1		SPARE			
46	1	20	SPARE			
42	1	20	SPARE			
44	1		SPARE	<u> </u>		
46 48	1		SPARE SPARE	1		-
50	1		SPARE			
52	1	20	SPARE]
54 50	1		SPARE		***************************************	
56 5 8	1	20 20	SPARE SPARE	1		
60	1	20	SPARE			1
62	1	20	SPARE			
64	1	20	SPARE			
66 6 8	1	20 20	SPARE SPARE			
78	1	20	SPARE		-	
72	1	20	SPARE			
74	1	20	SPARE			
76	1	20	SPACE SPACE	-		-
78 80	1	20 20	SPACE SPACE			
82	1	20	SPACE			
84	1	20	SPACE CONNECTED KW: 0			



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Project:

WSU- DETROIT- UGL 1ST FLOOR STUDENT

5155 GULLEN MALL, DETROIT, MI 48202

Key Plan:

5155 GULLEN MALL, DETROIT MI 48202

Issued for BIDS

09/15/2023

ADDENDUM #1 09.28.23

KEY NOTES:

1 CROSS-HATCHED CIRCUITS REPRESENT EXISTING CIRCUITS DEMOLISHED AND TO BE USED FOR NEW WORK

Drawn by : LZ

Checked by: WZ

Sheet Title: ELECTRICAL RISER DIAGRAM

Må M

Project No. :

2023.111

Sheet No. :

			RP-D1B (EXISTING BEFORE DEMO) MOUNTING: SURFACE	MOUNTE	D	
		MAIN:	208Y/120V, 3 PHASE, 4 WIRE + G AIC: EXISTING 400 A MCB FEEDER: EXISTING ELEC ROOM SPD EQUIPPED: YES			
Circ No	Bre Pole	aker Trip	Load Information Location Description Code		nected Wa	
1 3	1	20	OFFICE 1242 DIR. REAS.1243,COLS.Q11,N11,Q134			
5	1	20	OFFICE 1242			
7 9	1	20	DIRECTED RESEARCH 1243 DIRECTED RESEARCH 1243			
11 13	1		FL. PLUG 24HR.ST.1300 COL.R13 FL. PLUG 24HR.ST.1300 COL.R13			
15 17	1		FL. PLUG 24HR.ST.1300 COL.Q13 FL. PLUG 24HR.ST.1300 COL.P13			
19 21	1		FL. PLUG 24HR.ST.1300 COL.P13 FL. PLUG 24HR.ST.1300 COL.O13			
23	1	20	FL. PLUG 24HR.ST.1300 COL.O13 FL. PLUG 24HR.ST.1300 COL.O13			
27	1	20	FL. PLUG 24HR.ST.1300 COL.O13			
2 9 31	1	20	BOOK RETURN CIR#29 EXHAUST FAN 1230			
33 35	1	20	DOOR OPENER SPARE	***************************************		
37 39	1		SPARE SPARE			
41 43	1		SPARE SPARE	AND THE RESERVE TO TH		
45 47	1	20	SPARE SPARE			
49	1	20	SPARE		erre vendendamenteli den etaliiliidadaliiliida asuusuu ee ee	
51 53	1	20	SPARE SPARE			
55 57	1	20	SPARE SPARE			
59 61	1	20	SPARE SPARE			
63 65	1	20	SPARE SPARE			
67 69	1	20	SPARE SPARE			
71	1	20	SPARE			
73 75	1	20	SPARE SPARE			
77 79	1	20	SPARE SPARE			
81 83	1		SPARE SPARE			
2	1		HEATER STAIRWAY BATHROOMS			
6	1	20	WATER FOUNTAIN FL. PLUG 24HR.ST.1300 COL.U14			
10	1	20	SECURE LOBBY			
12 14	1	20	STORAGE 1314 FL. PLUG 24HR.ST.1300 COL.N16			
16 18	1		FILE SERVICE RM.1309 FILE SERVICE RM.1309			
20 22	1		LOBBY RECPTSPOLICE MINI STATION LOBBY RECPTSPOLICE MINI STATION			
24 26	1	20	FL.PLUG 24HR.STU1300COL. FL.PLUG 24HR.STU1300COL.T16			
2θ 3 6	1	20	FL.PLUG 24HR.STU1300COL.T16 FL.PLUG 24HR.STU1300COL.R15			
32	1	20	FL.PLUG 24HR.STU1300COL.R15			VIII.
34 36	1	20	FL.PLUG 24HR.STU1300COL.R16 FL.PLUG 24HR.STU1300COL.R15			
38 48	1		FL.PLUG 24HR.STU1300COL.Q16 FL.PLUG 24HR.STU1300COL.Q16			
42 44	1	20	FL.PLUG 24HR.STU1300COL.P15 FL.PLUG 24HR.STU1300COL.P15			
46 48	1	20	FL.PLUG 24HR.STU1300COL.P16 FL.PLUG 24HR.STU1300COL.P17			
50 52	1	20	FL.PLUG 24HR.STU1300COL.O18 FL.PLUG 24HR.STU1300COL.O13			*
54	1	20	FL.PLUG 24HR.STU1300COL.O13			
5θ 5θ	1	20	SPARE SPARE			
60 62	1	20	SPARE SPARE			
64 6 0	1		SPARE SPARE			
68 7 6	1	20	SPARE SPARE			
72 74	1	20	SPARE SPARE			
76	1	20	SPARE			
78 80	1	20	SPARE SPARE			
82 84	1		SPARE SPARE			
l	[
			CONNECTED KW: 0 CONNECTED AMPS: 0 Phase Watts:			

Circ		aker	Load Information		nnected W	
No 1	Pole 1	_	Location Description Code OFFICE 1242	Phase A	Phase B	Phas
3 5	1		DIR. REAS.1243,COLS.Q11,N11,Q134 OFFICE 1242			
7	1	20	DIRECTED RESEARCH 1243			
9 11	1		DIRECTED RESEARCH 1243 OFFICE 1332, 1333 NEW RECEPTACLES			
13	1	20	OFFICE 1330, 1331 NEW RECEPTACLES			
15 17	1 1		OPEN STUDY XX NEW IN GROUND RECEPTACLE OPEN STUDY XX NEW IN GROUND RECEPTACLE			
19	1		FL. PLUG 24HR.ST.1300 COL.P13			
21 23	1		OPEN STUDY XX NEW IN GROUND RECEPTACLE FL. PLUG 24HR.ST.1300 COL.O13	And the shadow to		
25 27	1		OPEN STUDY XX NEW IN GROUND RECEPTACLE			
29	1	20	FL. PLUG 24HR.ST.1300 COL.O13 BOOK RETURN CIR#29			
31 33	1		EXHAUST FAN 1230 DOOR OPENER		_	
35	1	20	SPARE			
37 39	1		SPARE SPARE		-	
41 43	1	20	SPARE SPARE			
45	1	20	SPARE			
47 49	1		SPARE SPARE			
51	1	20	SPARE			
53 55	1	20	SPARE SPARE			
57 59	1	20	SPARE SPARE			-
61	1	20	SPARE			
63 65	1		SPARE SPARE			-
67	1	20	SPARE			
69 71	1		SPARE SPARE			L
73 75	1	20	SPARE SPARE			
77	1	20	SPARE			
79 81	1		SPARE SPARE			
83	1		SPARE	1		
				1		
2	1	20	HEATER STAIRWAY			
4	1	20	BATHROOMS			
6 8	1		WATER FOUNTAIN OPEN STUDY XX NEW COFFEE BAR RECEPTACLE			
10 12	1	20 20	SECURE LOBBY STORAGE 1314			
14	1	20	FL. PLUG 24HR.ST.1300 COL.N16			
1 0	1		FILE SERVICE RM.1309 FILE SERVICE RM.1309			
20 22	1		LOBBY RECPTSPOLICE MINI STATION LOBBY RECPTSPOLICE MINI STATION			
24	1	20	OFFICE 1334, 1335 NEW RECEPTACLES			
2 0	1	20 20	OFFICE 1336, 1337 NEW RECEPTACLES OPEN STUDY XX NEW IN GROUND RECEPTACLE		-	
30	1	20	OFFICE 1323, 1324 NEW RECEPTACLES			
32 34	1	20 20	OFFICE 1326, 1327 NEW RECEPTACLES OPEN STUDY XX NEW IN GROUND RECEPTACLE		-	
36	1	20	HALL-1 NEW RECEPTACLES			
38 40	1	20 20	OFFICE 1322, 1324 NEW RECEPTACLES OPEN STUDY XX NEW IN GROUND RECEPTACLE		-	
42	1	20	OPEN STUDY XX NEW IN GROUND RECEPTACLE			
44	1		OPEN STUDY XX NEW IN GROUND RECEPTACLE OPEN STUDY XX NEW IN GROUND RECEPTACLE		_	
48	1	20	OPEN STUDY XX NEW COFFEE BAR RECEPTACLE			
50 52	1		CONFERENCE ROOM NEW RECEPTACLES FL.PLUG 24HR.STU1300COL.O18		L	
54	1	20	FL.PLUG 24HR.STU1300COL.O18 SPARE			
	1	20	SPARE			
56 58	1	20 20	SPARE SPARE			
56	1	20	SPARE			
56 58 60 62 64	4	20 20	SPARE SPARE			
56 58 60 62 64 60 68	1		SPARE SPARE			
56 58 60 62 64 60 68 70	1 1	コンロー	SPARE			
56 58 60 62 64 66 68 70 72 74	1 1 1	20		1		
56 58 60 62 64 60 68 70 72	1 1	20 20	SPARE SPARE			
56 58 60 62 64 66 68 70 72 74 76 78	1 1 1 1 1 1 1 1	20 20 20 20	SPARE SPARE SPARE			
56 58 60 62 64 66 68 70 72 74 76	1 1 1 1 1 1	20 20 20	SPARE SPARE			
56 58 60 62 64 66 68 70 72 74 76 80 82	1 1 1 1 1 1	20 20 20 20 20	SPARE SPARE SPARE SPARE SPARE			
56 58 60 62 64 66 68 70 72 74 76 80 82	1 1 1 1 1 1 1 1	20 20 20 20 20	SPARE SPARE SPARE SPARE SPARE			
56 58 60 62 64 66 68 70 72 74 76 80 82	1 1 1 1 1 1 1 1	20 20 20 20 20	SPARE SPARE SPARE SPARE SPARE			
56 58 60 62 64 66 68 70 72 74 76 80 82	1 1 1 1 1 1 1 1	20 20 20 20 20	SPARE SPARE SPARE SPARE SPARE			
56 58 60 62 64 66 68 70 72 74 76 80 82	1 1 1 1 1 1 1 1	20 20 20 20 20	SPARE SPARE SPARE SPARE SPARE			

				100 A MLO	FEE	DER: EXISTING			
				ELECTRICAL ROOM S	PD EQUIP	PPED: YES			
-		ed Gre							
	irc	Brea		Load Information	1			nnected W	
	10	Pole		Location Description		Code	Phase A	Phase B	Phase C
	1	1		FL.PLUG 24HR.ST.1300 COL.J16					
	3	1		FL.PLUG 24HR.ST.1300 COL.L18					
	5	1		FL.PLUG 24HR.ST.1300 COL.K18			***************************************	<u> </u>	
-	7	1		FL.PLUG 24HR.ST.1300 COL.N17					
	9	1		FL.PLUG 24HR.ST.1300 COL.N16					
_	1	1		FL.PLUG 24HR.ST.1300 COL.N16					
	3	1		FL.PLUG 24HR.ST.1300 COL.N15					
1	5	1		SPARE					
1	7	1		SPARE					
1	9	1		SPARE					
2	21	1		SPARE					
2	23	1		SPARE					
2	25	1	20	SURGE PROTECTION					
2	27	1	20	SURGE PROTECTION					
2	29	1	20	SURGE PROTECTION					
	2	1	20	DIG. SIGNAGE.L15					
-	4	1	20	DIG. SIGNAGE.L15					
(6	1	20	DIG. SIGNAGE.L15					
	8	1	20	DIG. SIGNAGE.L15					
1	0	1		DIG. SIGNAGE.L15					
1	2	1	20	BASEMENT CUBICLE					
	4	1		BASEMENT CUBICLE					
1	6	1		FL/OL.24HR.ST.1300,COL.L17					
	θ	1		BASEMENT PLUG SOUTH WALL					
	20	1		BASEMENT FRIDGE SOUTH WALL		*****			
	22	1		BASEMENT MICROWAVE					
2	24	1		BASEMENT PLUG EAST WALL	····				
	26	1		BASEMENT PLUG EAST WALL					
_2	20	1		BASEMENT PLUG EAST WALL					
	30	1		SPARE					
				CONNECTED KW:	0				
				CONNECTED AMPS:	0	Phase Watts:	0	0	,
				DEMAND KW:	0		ľ		
				DEMAND AMPS:	0				

-			RP-D1E (EXISTING BEFORE DEMO) 208Y/120V, 3 PHASE, 4 WIRE + G	MOL	JNTING: SURFACI AIC: EXISTING			
		MAIN:	100 A MLO	FE	EEDER: EXISTING	i		
	LOCA	TION:	ELECTRICAL ROOM	SPD EQL	JIPPED: YES			
Circ	Bre	aker	Load Information	on		Coi	nnected W	atts
No	Pole	Trip	Location Description		Code	Phase A	Phase B	Phase C
1	1	20	FL.PLUG 24HR.ST.1300 COL.L15					
3	1	20	FL.PLUG 24HR.ST.1300 COL.L15					
5	1	20	FL.PLUG 24HR.ST.1300 COL.L16					
7	1	20	FL.PLUG 24HR.ST.1300 COL.L17				***************************************	
5	1	20	BASEMENT BATHROOM GFI M15					
11	1	20	BASEMENT BATHROOM LIGHTS M16					
13	1	20	HAND DRYER WOMEN					
15	1	20	HAND DRYER MEN					
17	1	20	HAND DRYER HANDICAP					
15	1	20	BASEMENT BATHROOM HOT WATER					
21	1	20	ATRIUM COLUMN PLUG					
23	3		SURGE PROTECTION					
25			SURGE PROTECTION					
27		60	SURGE PROTECTION					
29	1	20	BASEMENT KITCHEN GFI					
2	1	20	E.OUTER WALL LECT.HALL(1400)					
4	1	20	E.O.WALL LEC.HALL(1400)					
6	1		FL.PLUGS 24HR.ST.1300COL.K18					
8	1	20	FL.PLUGS 24HR.ST.1300COL.M18					
10	1	20	FL.PLUGS 24HR.ST.1300COL.N17					
12	1	20	FL.PLUGS 24HR.ST.1300COL.N17					
14	1	20	FL.PLUGS 24HR.ST.1300COL.N16					
10	1	20	FL.PLUGS 24HR.ST.1300COL.N16					
10	1	20	FL.PLUGS 24HR.ST.1300COL.N15					
20	1	20	TABLE BY COPIERS WEST SIDE					
22	1	20	BASEMENT STORAGE WALL PLUG					
24	1	20	BASEMENT STORAGE COLUMN FURNI	TURE				
20	1	20	BASEMENT STORAGE WALL PLUG					
28	1		SPARE					
30	1	20	SPARE					
			CONNECTED KW:	0				
			CONNECTED AMPS:	0	Phase Watts:	0	0	
			DEMAND KW:	0				
			DEMAND AMPS:	0				

			208Y/120V, 3 PHASE, 4 WIRE + G		AIC: EXISTING			
			100 A MLO	FEE	DER: EXISTING			
			ELECTRICAL ROOM S	PD EQUIP	PED: YES			
Isolat	ed Gro	ound l	Bus					
Circ			Load Information	l			nnected W	
No	Pole		Location Description		Code	Phase A	Phase B	Phase
1	1		FL.PLUG 24HR.ST.1300 COL.J16					
3	1	20	OPEN STUDY XX NEW IG RECE	PTACLES				
5	1	20	OPEN STUDY XX NEW IG RECE	PTACLES				
7	1	20	SPARE					
5	1	20	SPARE					
11	1	20	SPARE					•
13	1	20	SPARE					
15	1	20	SPARE					
17	1	20	SPARE					-
19	1	20	SPARE					
21	1	20	SPARE					
23	1		SPARE					
25	1	20	SURGE PROTECTION					
27	1		SURGE PROTECTION					
29	1		SURGE PROTECTION					
2	1		DIG. SIGNAGE.L16					
4	1		DIG. SIGNAGE.L16					
6	1		DIG. SIGNAGE.L16					
8	1		DIG. SIGNAGE.L16					
16	1		DIG. SIGNAGE.L16					
12	1		BASEMENT CUBICLE					
14	1		BASEMENT CUBICLE					
16	1		FL/OL.24HR.ST.1300,COL.L17			Miles berget and a second seco		
18	1		BASEMENT PLUG SOUTH WALL					
20	1		BASEMENT FRIDGE SOUTH WALL					
22	1		BASEMENT MICROWAVE					-
24	1		BASEMENT PLUG EAST WALL					
26	1		BASEMENT PLUG EAST WALL					
2 0 30	1		BASEMENT PLUG EAST WALL SPARE					
50	'	20	CONNECTED KW:	0				
			CONNECTED AMPS:	0	Phase Watts:	0	0	
			DEMAND KW:	0	i ilase Walls.	"	0	
			DEMAND AMPS:	0				

PAI	NELB(DARD:	RP-D1E (EXISTING AFTER NEW WORK) MOUN	ITING: SURFACE	Ξ		
	VOL	TAGE:	208Y/120V, 3 PHASE, 4 WIRE + G	AIC: EXISTING	1		
		MAIN:	100 A MLO FEE	DER: EXISTING	i		
	LOCA	ATION:	ELECTRICAL ROOM SPD EQUIF	PPED: VEO			
				YES			
Circ	Bre	aker	Load Information		Co	nnected W	atts
No	Pole	Trip	Location Description	Code	Phase A	Phase B	Phase C
1	1	20	FL.PLUG 24HR.ST.1300 COL.L15				
3	1		FL.PLUG 24HR.ST.1300 COL.L15				
5	1		FL.PLUG 24HR.ST.1300 COL.L15				
7	1	20	FL.PLUG 24HR.ST.1300 COL.L17				
9	1	20	BASEMENT BATHROOM GFI M15				
11	1		BASEMENT BATHROOM LIGHTS M16				
13	1		HAND DRYER WOMEN				
15	1	20	HAND DRYER MEN				
17	1	20	HAND DRYER HANDICAP				
19	1	20	BASEMENT BATHROOM HOT WATER				
21	1	20	ATRIUM COLUMN PLUG				
23	3		SURGE PROTECTION				
25			SURGE PROTECTION				
27			SURGE PROTECTION				
29	1	20	BASEMENT KITCHEN GFI				
2	1		E.OUTER WALL LECT.HALL(1400)				
4	1		E.O.WALL LEC.HALL(1400)				
6	1	20	OPEN STUDY NEW WALL RECEPTAC	LES			
8	1	20	OPEN STUDY NEW WALL RECEPTAC	LES			
10	1	20	OPEN STUDY NEW IN GROUND RECE	PTACLE			
12	1	20	OPEN STUDY NEW IN GROUND RECE	PTACLE			
14	1	20	OPEN STUDY NEW IN GROUND RECE	PTACLE			
10	1	20	OPEN STUDY NEW IN GROUND RECE	PTACLE			
10	1	20	OPEN STUDY NEW IN GROUND RECE	PTACLE			
20	1	20	TABLE BY COPIERS WEST SIDE		whaterroom and the constitution to		
22	1	20	BASEMENT STORAGE WALL PLUG				
24	1	20	BASEMENT STORAGE COLUMN FURNITURE				
28	1		BASEMENT STORAGE WALL PLUG				
28	1	20	SPARE				
30	1	20	SPARE				
	_	-	CONNECTED KW: 0				
			CONNECTED AMPS: 0	Phase Watts:	0	0	0
			DEMAND KW: 0				
			DEMAND AMPS: 0				
					•		

KEY NOTES :

1 CROSS-HATCHED CIRCUITS REPRESENT EXISTING CIRCUITS DEMOLISHED AND TO BE USED FOR NEW WORK



STUCKY VITALE ARCHITECTS 27172 WOODWARD AVENUE ROYAL OAK, MI 48067-0925 P. 248.546.6700

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Project:

WSU- DETROIT- UGL 1ST FLOOR STUDENT REFRESH

5155 GULLEN MALL, DETROIT, MI 48202

Key Plan:

5155 GULLEN MALL, DETROIT MI 48202

Issued for BIDS 09/15/2023 ADDENDUM #1 09.28.23

Drawn by : LZ Checked by:

Sheet Title:


PANEL SCHEDULES

Må M

Project No. :

2023.111

Sheet No.:

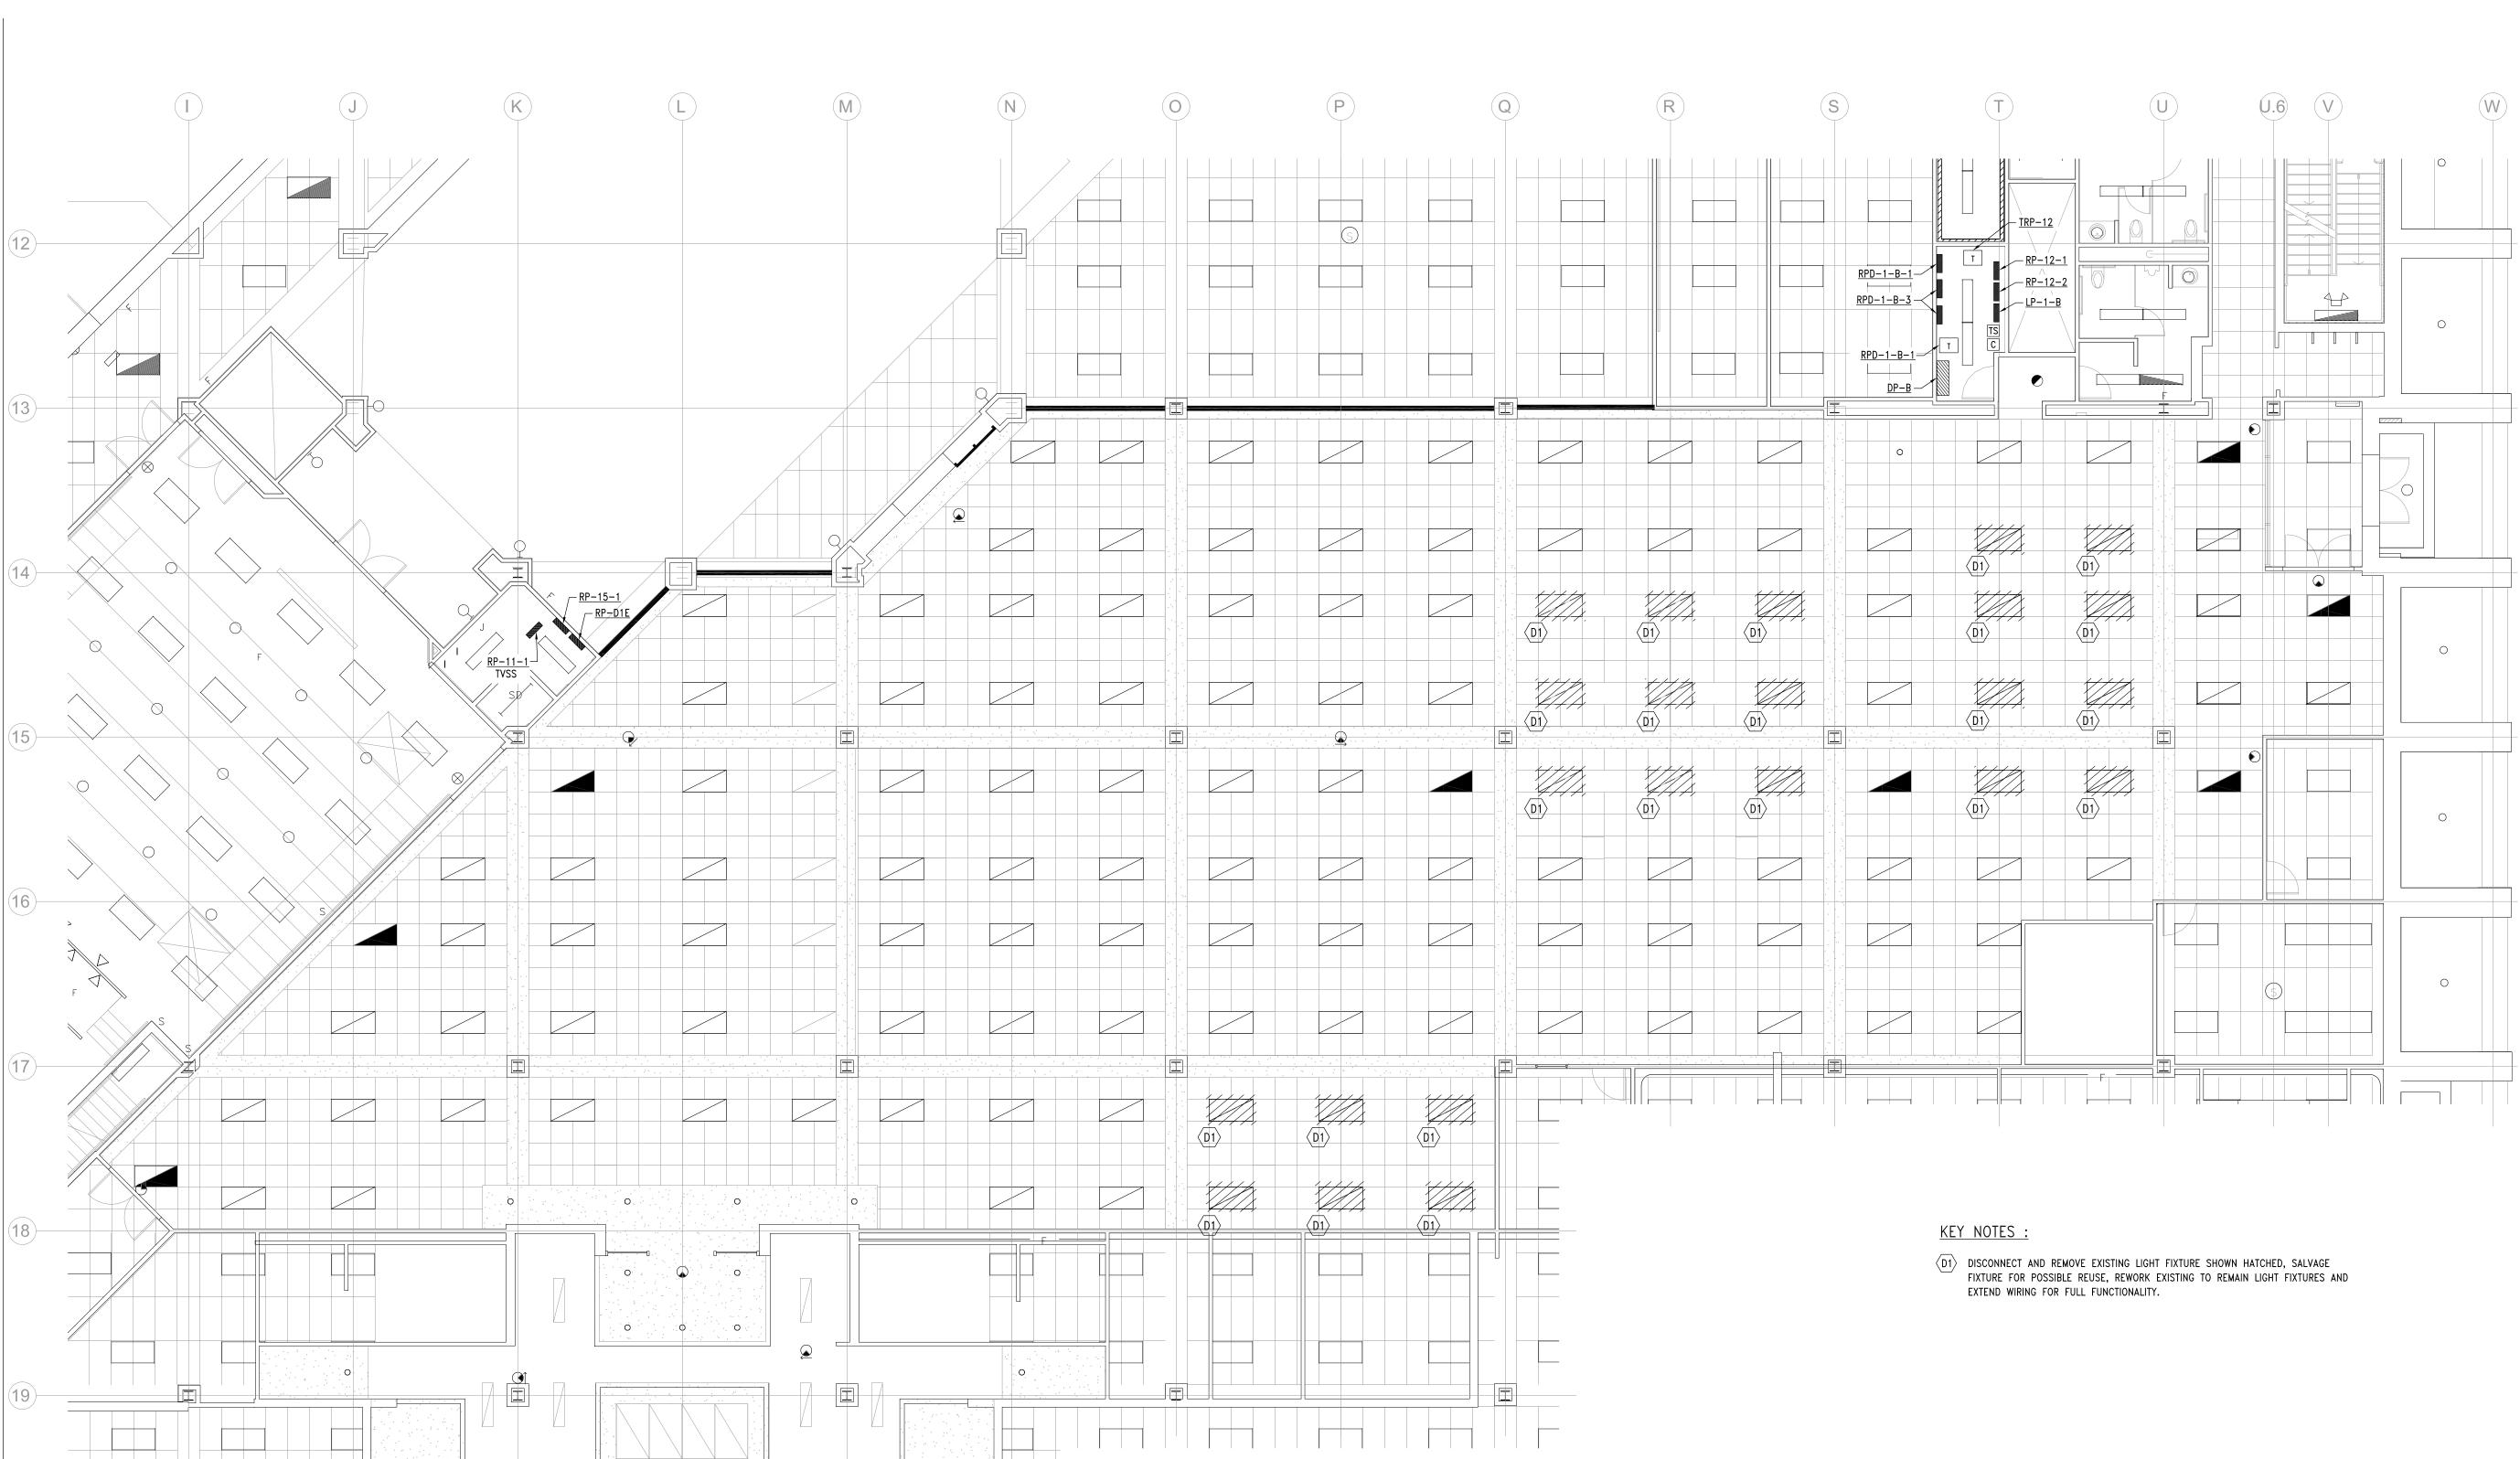

DEMOLITION GENERAL NOTES:

- A. GENERAL DEMOLITION NOTES APPLY TO ALL ELECTRICAL DEMOLITION PLANS INCLUDED WITHIN THIS
- B. CIRCUITING INFORMATION ON THESE SHEETS HAVE BEEN OBTAINED FROM AS-BUILT DRAWINGS PROVIDED BY OWNER AND FROM SITE PANEL DIRECTORIES AND SHALL BE USED FOR REFERENCE ONLY, CONTRACTOR SHALL FIELD VERIFY TO DETERMINE EXISTING CONDITIONS AND UPDATE PANEL DIRECTORIES AS REQUIRED AFTER NEW WORK IS COMPLETED.
- C. DEVICES SHOWN ON DEMOLITION PLANS HAVE BEEN OBTAINED FROM OLD CONSTRUCTION DOCUMENTS AND FIELD SURVEY WITH LIMITED ACCESSIBILITY TO CERTAIN AREAS, CONTRACTOR SHALL FIELD VERIFY EXISTING CONDITIONS AND INCLUDE IN THE SCOPE OF WORK DEMOLITION OF ALL EXISTING DEVICES, WIRES, RACEWAYS, SUPPORTS AND ACCESSORIES, REFER TO KEY NOTES FOR DETAILS.
- D. COORDINATE ANY SERVICE SHUTDOWNS OR WORK INVOLVING OTHER AREAS WITH HOSPITAL FACILITIES AND PROJECT MANAGER.
- E. CONTRACTOR SHALL PROTECT NON-CONSTRUCTION AREAS OF OWNER'S BUILDING FROM CONSTRUCTION DUST/DEBRIS.
- F. ANY CIRCUITS WHICH ARE TO BE FULLY DEMOLISHED SHOULD BE DEMOLISHED TO THE UPSTREAM PANEL, REMOVE ALL WIRING AND UNUSED CONDUITS. THE FEEDING BREAKER SHALL BE LABELED AS SPARE, REFER TO SPECIFICATION FOR DETAILS.
- G. ANY LOW VOLTAGE COMMUNICATION AND MEDICAL DEVICES ON CEILING SUCH AS: WIRELESS ACCESS POINTS, SPEAKERS, SMOKE DETECTORS...ETC. SHALL BE REMOVED AND STORED FOR RE-INSTALLATION AS COORDINATED WITH HOSPITAL COMMUNICATION DEPARTMENT.
- H. ALL ELECTRICAL ITEMS SHOWN ON THESE PLANS ARE EXISTING TO REMAIN UNLESS OTHERWISE INDICATED.

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Project:

WSU- DETROIT- UGL 1ST FLOOR STUDENT REFRESH

5155 GULLEN MALL, DETROIT, MI 48202

Key Plan:

5155 GULLEN MALL, DETROIT MI 48202

Issued for 09/15/2023

09.28.23

ADDENDUM #1

Drawn by:

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Sheet Title:

DEMOLITION LIGHTING PLAN -CONTRACTOR LEVEL 1

Project No.:

2023.111

Sheet No.:

DEMOLITION LIGHTING PLAN - LEVEL 1

ED110




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ADDENDUM #1 09.28.23

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Sheet Title :

DEMOLITION POWER PLAN -

Project No. :


Project No. : 2023.111

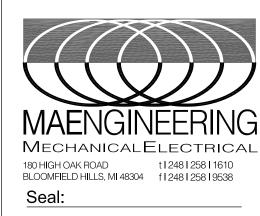Sheet No. :

Sheet No.:
ED210

minimi

1 DEMOLITION POWER PLAN - LEVEL 1
ED210 1/8" = 1'-0"

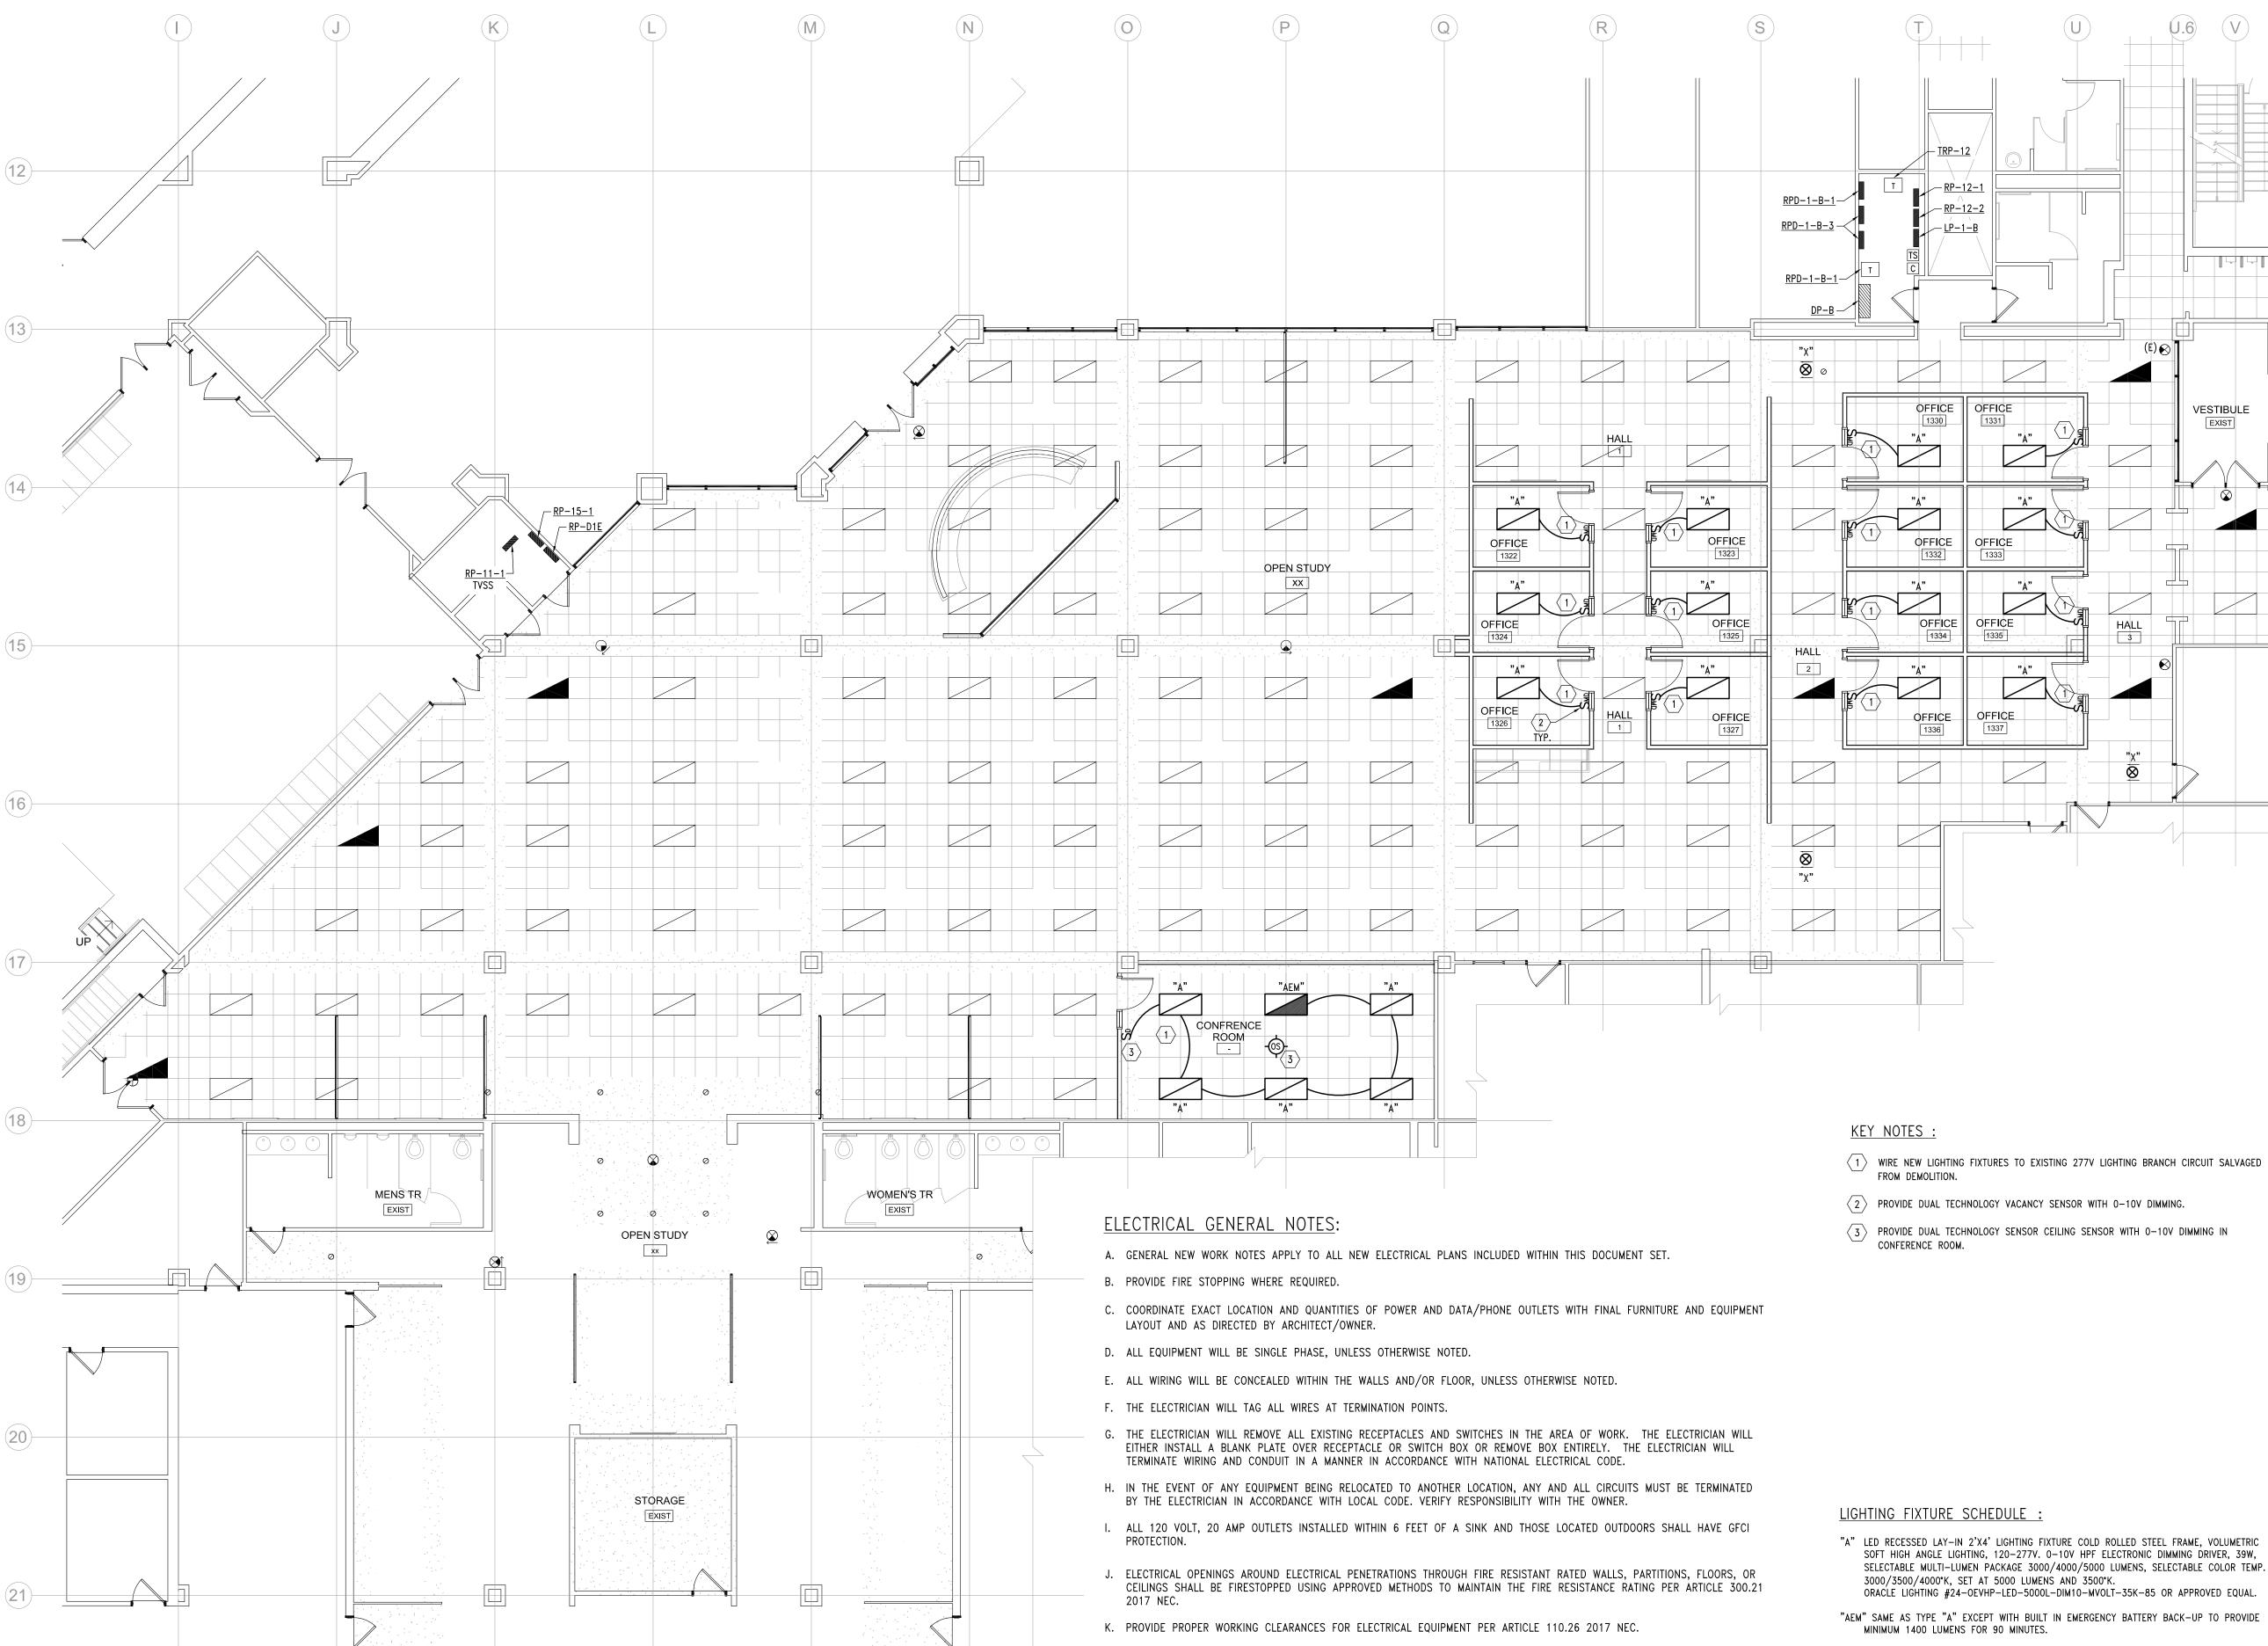

L. MAINTAIN A MINUMUM OF 24" HORIZONTAL SEPARATION BETWEEN BOXES INSTALLED ON OPPOSITE SIDES OF FIRE RATED

M. ALL WIRING LOCATED ABOVE SUSPENDED CEILING MUST BE SUPPORTED INDEPENDENTLY OF THE SUPPORT WIRES FOR THE

WALLS TO COMPLY WITH NEC 300.21.

SUSPENDED CEILING PER ARTICLE 300.11 2017 NEC.

N. PROVIDE COMPLETE SYSTEM GROUNDING AND BONDING PER ARTICLE 250 2017 NEC.

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09.28.23

ADDENDUM #1

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Sheet Title: LIGHTING PLAN - LEVEL 1

Project No.: 2023.111

Sheet No. :

1 LIGHTING PLAN - LEVEL 1 E110 1/8" = 1'-0"

"A" LED RECESSED LAY-IN 2'X4' LIGHTING FIXTURE COLD ROLLED STEEL FRAME, VOLUMETRIC SOFT HIGH ANGLE LIGHTING, 120-277V. 0-10V HPF ELECTRONIC DIMMING DRIVER, 39W, SELECTABLE MULTI-LUMEN PACKAGE 3000/4000/5000 LUMENS, SELECTABLE COLOR TEMP. 3000/3500/4000°K, SET AT 5000 LUMENS AND 3500°K. ORACLE LIGHTING #24-OEVHP-LED-5000L-DIM10-MVOLT-35K-85 OR APPROVED EQUAL.

VESTIBULE

"AEM" SAME AS TYPE "A" EXCEPT WITH BUILT IN EMERGENCY BATTERY BACK-UP TO PROVIDE

"X" LED EXIT SIGN, SINGLE FACE, POLYCARBONATE HOUSING CONSTRUCTION, UNIVERSAL DIRECTIONAL ARROW KNOCKOUTS, FULLY OVERLAPPING LIGHT SEAL 6" HIGH RED LETTERS25 YEAR LIFE LED LAMPS, MULTI VOLT INPUT, 6 VOLT SEALED MAINTENANCE-FREE

BATTERY 90 MINUTE DISCHARGE, 24 HOUR RECHARGE.

LIGHTALARMS #QLXN500-R OR APPROVED EQUAL.



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Drawn by: LZ Checked by:

Sheet Title: POWER PLAN - LEVEL 1

Project No :

2023.111

Sheet No.: E210

minimum

POWER PLAN - LEVEL 1 E210 1/8" = 1'-0"