

- I2C MRI INSTALLATION - LAB 5 FIT-OUT ADDRESS: 461 BURROUGHS ST. DETROIT, MI. 48202

Wayne State University



I2C MRI Installation -Lab 5 Fit-Out

461 Burroughs St. Detroit, MI 48202

Addendum 2

09/05/2019



2017-03497-000 Client's Project Number: 212-313128

MATERIAL DESIGNATION LEGEND

| MATERIAL | |
|---|--|
| EARTH | |
| SAND FILL | |
| FILL | |
| CONCRETE | |
| BRICK | |
| CONCRETE MASONRY UNIT | |
| SOLID CONCRETE MASONRY UNIT WITH FILLED CORES | |
| STONE | |
| METALS | |
| WOOD BLOCKING, NAILER ETC. (CONTINUOUS) | |
| WOOD BLOCKING, INTERRUPTED OR SHIMS | |
| FINISH WOOD | |
| PLYWOOD OR PARTICLE BOARD | |
| PLASTIC LAMINATE ON PLYWOOD | |
| RIGID INSULATION | |
| BLANKET OR BATT INSULATION | |
| SPRAYED-ON INSULATION OR FIREPROOFING | |
| GASKET MATERIAL OR JOINT FILLER | |
| SEALANT W/ BOND BREAK TAPE 1/2 X | |
| SEALANT W/ BACKER ROD × | |

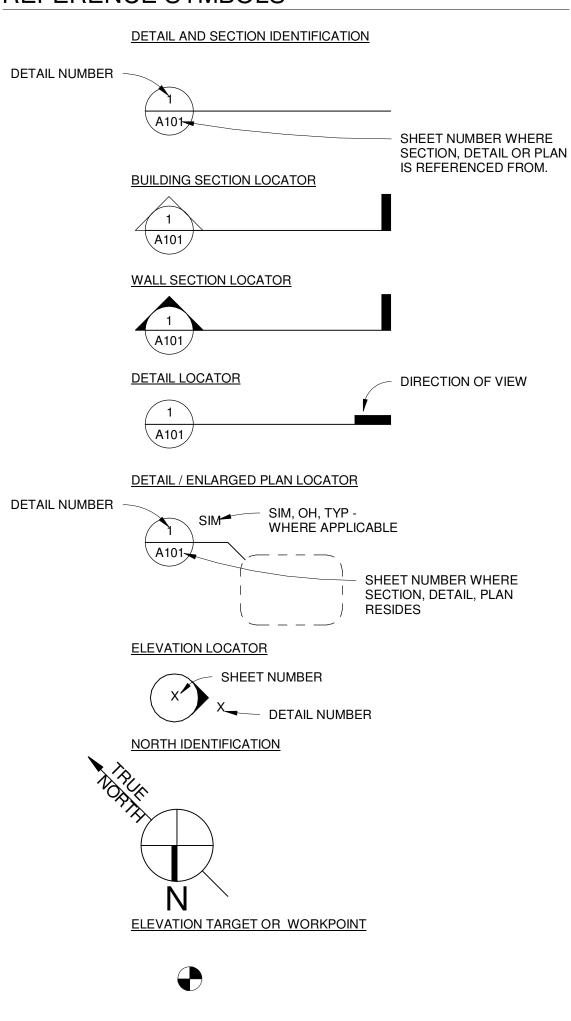
TENANT SPACE OCCUPANT LOAD PER AREA/USE

| EXISTING BUILDING SQUARE FOOTAGE | |
|----------------------------------|--|
| (E) MEZZANINE | 4,833 S.F. |
| (E) BUSINESS (OFFICE + SHOWROOM) | 8,238 + 4'535 = 12,773 S.F. |
| (E) AUDITORIUM (ASSEMBLY) | 3,695 S.F. |
| (E) LABORATORY (FACTORY) | 23,522 S.F. |
| TOTAL FLOOR AREA | 44,823 S.F. (NO CHANGE TO (E) FLOOR AREA) |
| | |
| USE GROUP CLASSIFICATION | MIXED USE "A-3 / B / F-1" |
| TYPE OF CONSTRUCTION | IIB (FULLY SPRINKLERED) |
| HEIGHT & STORY | 1-STORY W/ MEZZANINE |
| | |
| TOTAL (E) OCCUPANTS | 500 OCCUPANTS (NO CHANGE OF USE, NO CHANGE TO EXISTING OCCUPANT LOAD) |
| | |
| AREA OF SCOPE OF WORK | |
| LAB - 5 | 909 S.F. / 100 = 9 OCCUPANTS (NO CHANGE OF USE) |
| | |

REFERENCE SYMBOLS

GYPSUM BOARD OR

PLASTER



1. COORDINATE DELIVERY SCHEDULE / SEQUENCE AND STREET CLOSURE REQUIREMENT WITH WAYNE STATE UNIVERSITY OR CITY OF DETROIT &

NOTE TO CONTRACTOR:

MRI MAGNET SUPPLIER.

2. CONTRACTORS PROVIDE TEMPORARY STAGING / PROTECTION OVER (E) LAWN STRIP (+/- 780 S.F.) AND (E) CONC. SIDEWALK (+/- 180 S.F.) FOR MRI MAGNET (+/- 38000 LBS) DELIVERY WITH 5'-0" MINIMUM ADDITIONAL PROTECTION ZONE ON BOTHSIDES OF TRANSPORT PATH- PATCH AND REPAIR TO MATCH EXISTING CONDITION AS REQUIRED AFTER DELIVERY

3. PROVIDE AND MAINTAIN CONTINUOUS THERMAL BARRIER AND WATER AND WEATHER TIGHTNESS UNTIL PERMANENT ENCLOSURE OF NEW ROLLING SERVICE DOOR INSTALLATION IS BUILT AND COMPLETELY ENCLOSED. PROVIDE TEMPORARY PROTECTION FOR ROLLING SERVICE DOOR DURING MAGNET DELIVERY.

3A. PROVIDE TEMPORARY PROTECTION FULL HEIGHT (+/- 650 S.F.) AT EXISTING EXTERIOR WALL DURING MAGNET DELIVERY. PATCH AND REPAIR TO EXISTING CONDITION IF DAMAGE OCCURS DURING MAGNET DELIVERY.

4. REFER TO A-101 PLAN FOR "REMOVABLE WALL SECTIONS AND RF SHIELD" FOR MAGNET DELIVERY. CONTRATOR SHALL COORDINATE RF SHIELD VENDOR/SUPPLIER FOR PHASED RF SHIELDING INSTALLATION.

5. PROVIDE TEMPORARY MAGNET PROTECTION PER MAGNET SUPPLIER'S INSTRUCTION AFTER MAGNET DELIVERY WHILE CONTRACTORS COMPLETING GENERAL FIT-OUT WORK

MRI MAGNET SUPPLIER: SVP Product Development Time Medical System Tel : +852 2156 1711 Mob : +852 9656 1639 Contact:Johnson Chong

email: johnson@time-medical.com

| = 12,773 S.F. |
|--|
| |
| |
| NO CHANGE TO (E) FLOOR AREA) |
| |
| A-3 / B / F-1" |
| RINKLERED) |
| MEZZANINE |
| |
| NTS (NO CHANGE OF USE, TO EXISTING OCCUPANT LOAD) |
| |

PLAN REVIEW DATA - EXISTING LAB 5 - 105

BUILDING CODE

2015 MICHIGAN REHABILITATION FOR EXISTING BUILDINGS PLUMBING CODE

2015 MICHIGAN PLUMBING CODE INCORPORATING THE 2015 EDITION OF THE INTERNATIONAL PLUMBING CODE. MECHANICAL CODE

2015 MICHIGAN MECHANICAL CODE INCORPORATING THE 2015 EDITION OF THE INTERNATIONAL MECHANICAL CODE. ELECTRICAL CODE

2014 NATIONAL ELECTRICAL CODE AS AMENDED BY MICHIGAN BUREAU OF CONSTRUCTION CODE RULES, ELECTRICAL CODE RULES PART 8, 2014.

LIFE SAFETY CODE STATE OF MICHIGAN, DEPARTMENT OF CONSUMERS AND INDUSTRY SERVICES, BUREAU OF FIRE SERVICES STATE FIRE SAFETY BOARD NEW AND EXISTING SCHOOL, COLLEGE AND UNIVERSITY FIRE SAFETY RULES USING THE 2012 EDITION OF NFPA 101 LIFE SAFETY CODE WITH MICHIGAN AMENDMENTS

FIRE ALARM 2013 NFPA 72

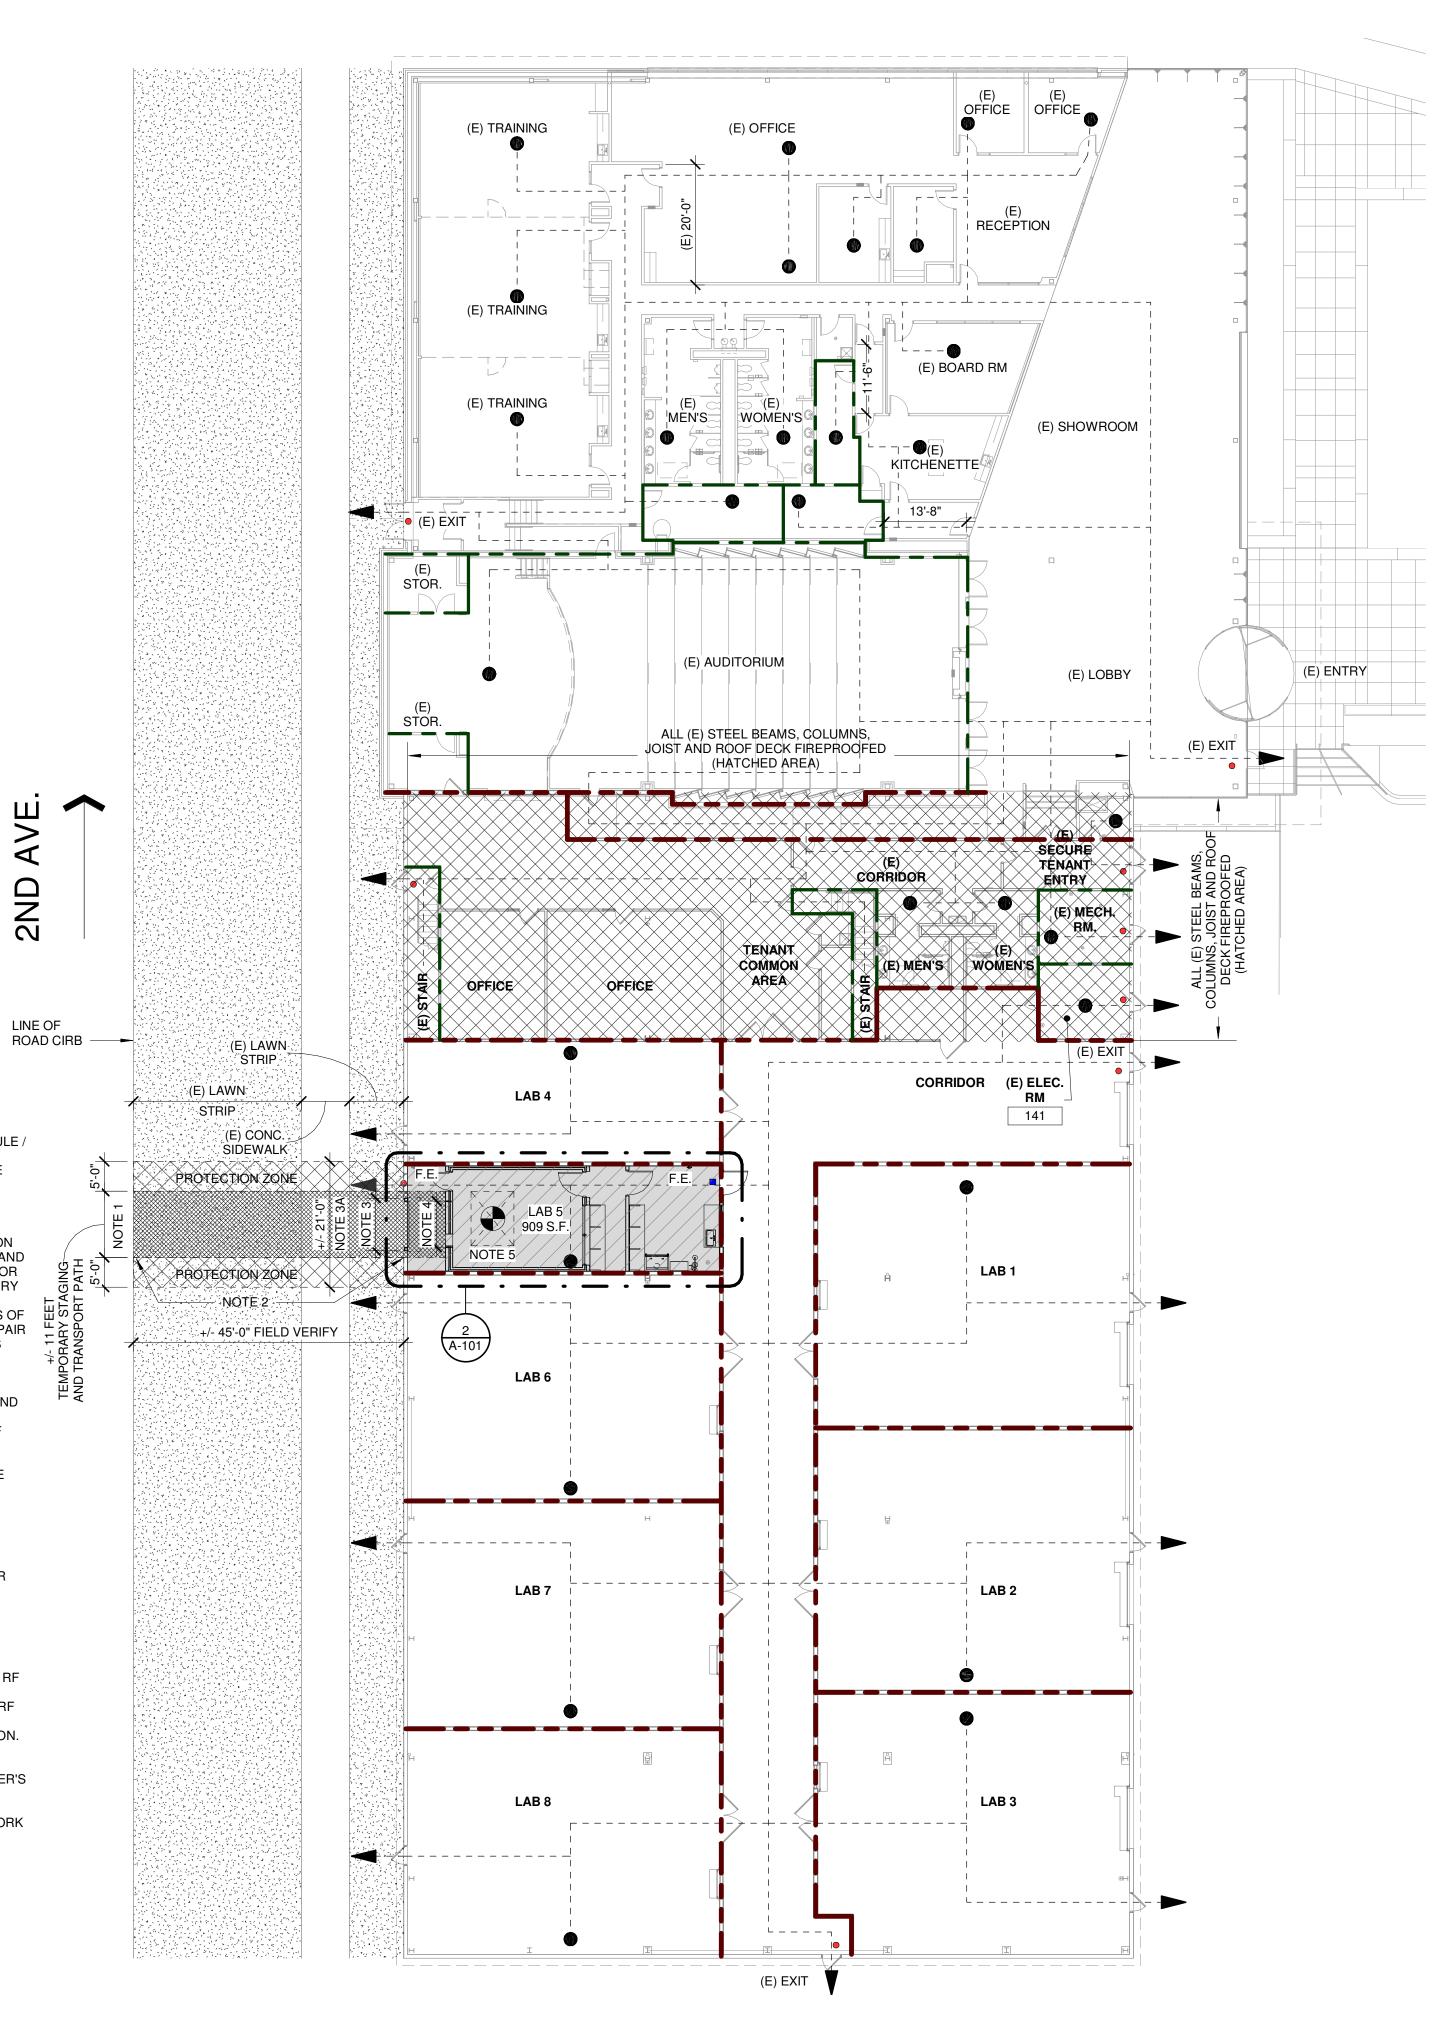
FIRE SUPPRESSION SYSTEM 2013 NFPA 13 - FULLY SPRINKLERED

ACCESSIBILITY

ICC/ANSI A117.1-2009 ADA STANDARD FOR ACCESSIBILITY DESIGN 2010 <u>ENERGY</u>

2015 MICHIGAN ENERGY CODE ANSI/ASHRAE/IES STANDARD 90.1-2013 BUILDINGS

THE PLUMBING FIXTURE COUNT.



FIRST FLOOR LIFE SAFETY PLAN SCALE: 1/16" = 1'-0"

ALTERATION LEVEL

2015 MICHIGAN REHABILITAION BUILDING CODE FOR EXISTING

ALTERATION LEVEL 2 (SECTION 504.1): LEVEL 2 ALTERATIONS INCLUDE THE RECONFIGURATION OF SPACE, THE ADDITION OR ELIMINATION OF ANY DOOR OR WINDOW, THE RECONFIGURATION OR EXTENSION OF ANY SYSTEM, OR THE INSTALLATION OF ANY ADDITIONAL EQUIPMENT.

PLUMBING FIXTURE COUNT

PER 2015 MICHIGAN REHABILITAION BUILDING CODE FOR EXISTING BUILDINGS SECTION 810 PLUMBING: WHERE THE OCCUPANT LOAD OF THE STORY IS INCREASED BY MORE THAN 20 PERCENT, PLUMBING FIXTURES FOR THE STORY SHALL BE PROVIDED IN QUANTITIES SPECIFIED IN THE INTERNATIONAL PLUMBING CODE BASED ON THE INCREASED OCCUPANT LOAD.

OCCUPANT LOAD OF THE STORY UNDER PROJECT SCOPE (WITHIN EXISTING 1ST FLOOR AREA) REMAINS NO CHANGE. NO CHANGE TO

| | GENERAL DRAWING LIST | |
|--------------|----------------------|------------------|
| Sheet Number | Sheet Name | Sheet Issued For |
| | | |
| G-000 | Title Sheet | Addendum 2 |
| G-001 | Drawing List | Addendum 2 |

| GENERAL DRAWING LIST | | |
|----------------------|---|--------------------------------|
| Sheet Number | Sheet Name | Sheet Issued For |
| G-000 | Title Sheet | Addendum 2 |
| G-001 | Drawing List | Addendum 2 |
| | ARCHITECTURAL DRAWI | NG LIST |
| Sheet Number | | |
| Sheet Number | Sheet Name | Sheet Issued For |
| A-101 | Sheet Name Detail Demolition, Lab Fit-Out and RCP plans | Sheet Issued For Addendum 2 |
| | Sheet Name | Sheet Issued For |
| A-101 | Sheet Name Detail Demolition, Lab Fit-Out and RCP plans | Sheet Issued For Addendum 2 |
| A-101 A-161 | Sheet Name Detail Demolition, Lab Fit-Out and RCP plans Equipment and Finishes Plan | Addendum 2 Addendum 2 |

| STRUCTURAL DRAWING LIST | | |
|-------------------------|-----------------------------|------------------|
| Sheet Number | Sheet Name | Sheet Issued For |
| | | |
| S-101 | Framing Plan & Details | Bids / Permits |
| S-102 | Roof Framing Plan & Details | Bids / Permits |

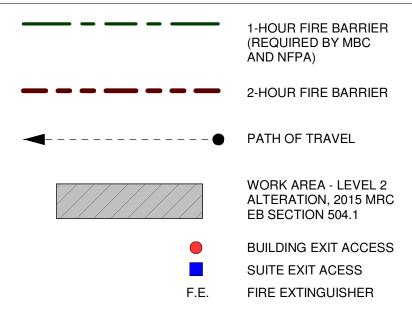
| | MECHANICAL DRAWING LIST | |
|--------------|---|------------------|
| Sheet Number | Sheet Name | Sheet Issued For |
| M-1 | Mechanical Combined Plans Demo + New Work | Addendum 2 |
| M-2 | Mechanical Details | Bids / Permits |
| M-3 | Mechanical Specifications | Bids / Permits |
| M-4 | Mechanical Specifications | Bids / Permits |

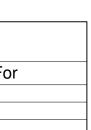
| ELECTRICAL DRAWING LIST | | |
|-------------------------|---|------------------|
| Sheet Number | Sheet Name | Sheet Issued For |
| E-001 | Electrical Symbols | Bids / Permits |
| E-011 | Electrical General Notes & Composite Plan | Bids / Permits |
| E-012 | Electrical Specifications | Bids / Permits |
| E-021 | Electrical One-Line / Riser Diagrams | Bids / Permits |
| E-041 | Panel & Lighting Schedules | Bids / Permits |
| E-101 | Electrical Demo & Lighting Plans | Bids / Permits |
| E-102 | Electrical Power and Misc. Systems Plans | Bids / Permits |

| RF SHIELD DRAWING LIST (ETS LINDGREN) - For Reference | | |
|---|------------|---------------------------|
| Sheet Number | Sheet Name | Sheet Issued For |
| RF3.0 | Details | Addendum 2 - Supplemental |
| RF3.1 | Details | Addendum 2 - Supplemental |

| RF SHIELD DRAWING LIST (IMEDCO) - For Reference | | |
|---|--------------|---------------------------|
| Sheet Number | Sheet Name | Sheet Issued For |
| SPG25-D4 | Detail Sheet | Addendum 2 - Supplemental |
| SPG25-D18 | Detail Sheet | Addendum 2 - Supplemental |
| SPG25-D22 | Detail Sheet | Addendum 2 - Supplemental |
| SPG25-D24 | Detail Sheet | Addendum 2 - Supplemental |
| SPG25-D26 | Detail Sheet | Addendum 2 - Supplemental |
| SPG25-D35 | Detail Sheet | Addendum 2 - Supplemental |
| SPG25-D36 | Detail Sheet | Addendum 2 - Supplemental |
| SPG25-D39 | Detail Sheet | Addendum 2 - Supplemental |
| SPG25-D41 | Detail Sheet | Addendum 2 - Supplemental |
| SPG25-D42 | Detail Sheet | Addendum 2 - Supplemental |
| SPG25-D43 | Detail Sheet | Addendum 2 - Supplemental |
| SPG25-D45 | Detail Sheet | Addendum 2 - Supplemental |
| SPG25-D48 | Detail Sheet | Addendum 2 - Supplemental |
| SPG25-D49 | Detail Sheet | Addendum 2 - Supplemental |
| SPG25-D50 | Detail Sheet | Addendum 2 - Supplemental |
| SPG25-D51 | Detail Sheet | Addendum 2 - Supplemental |











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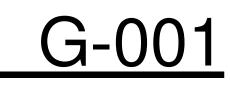
461 Burroughs St.. Detroit, **MI 48202**

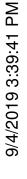
| Date | Issued For |
|------------|--------------------|
| 06/07/2019 | Design Development |
| 07/12/2019 | Owner Review |
| 08/12/2019 | Bids / Permits |
| 08/27/2019 | Addendum 1 |
| 09/05/2019 | Addendum 2 |
| | |

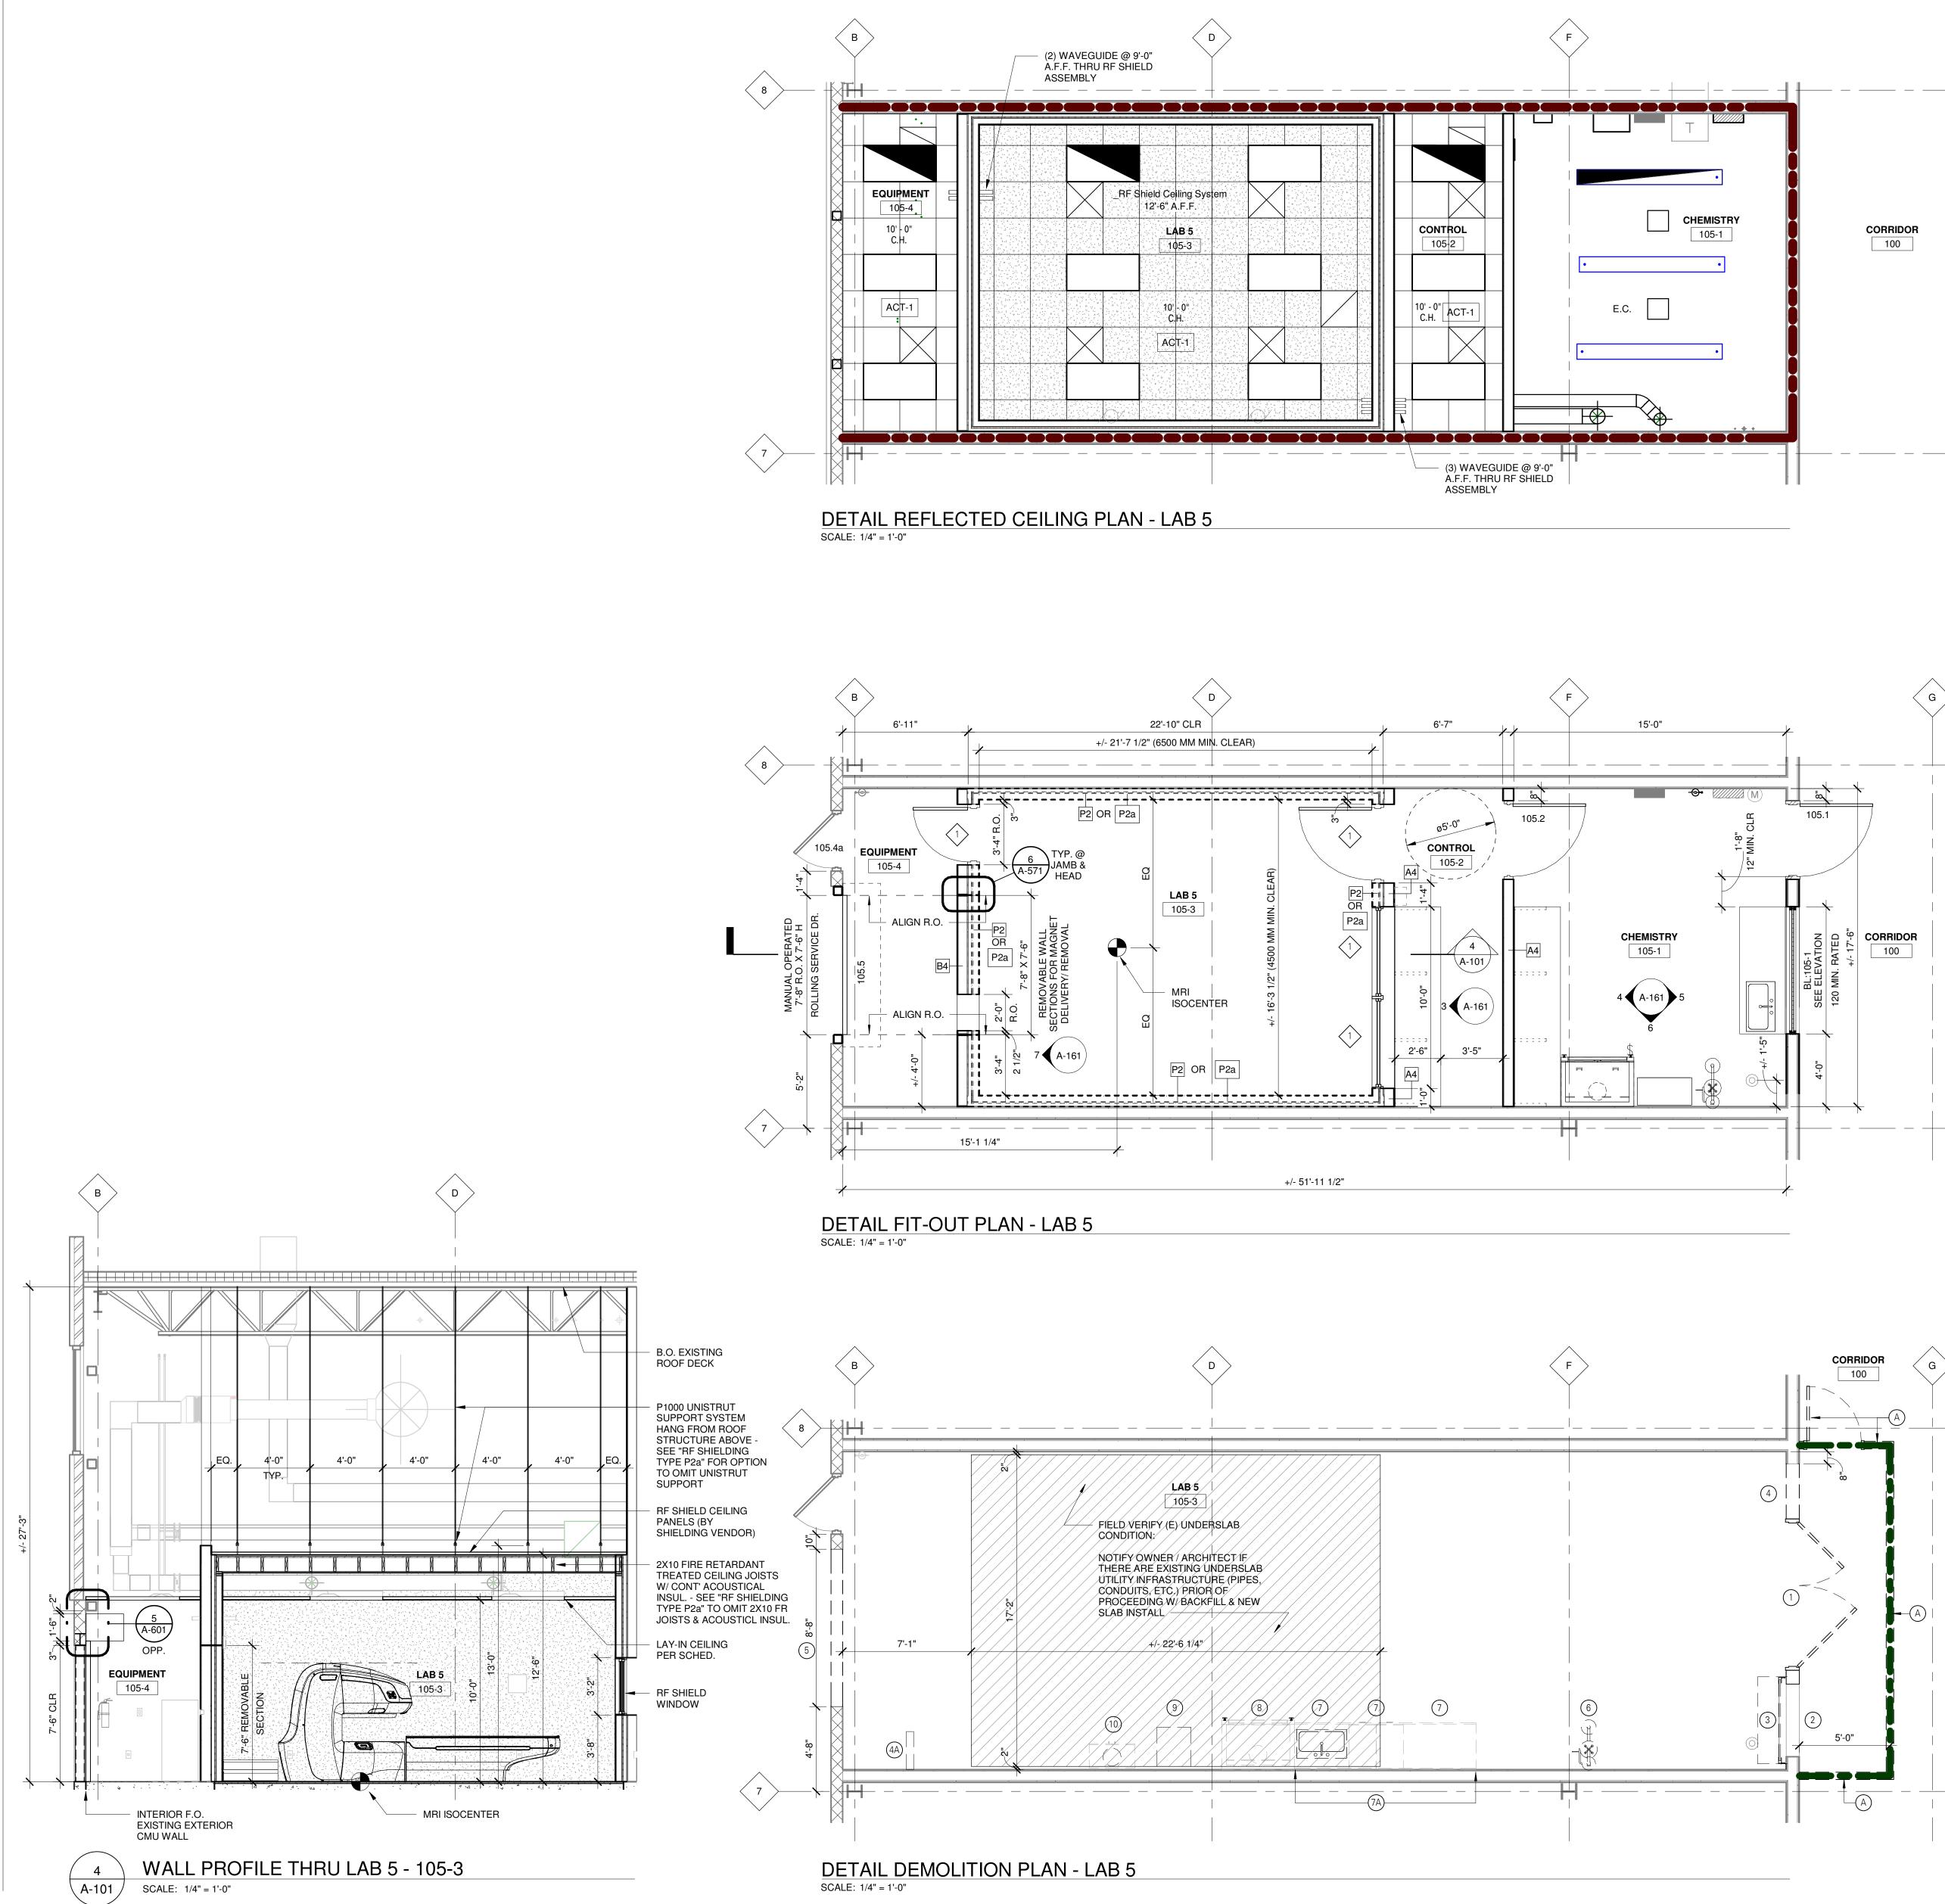


48033 USA (248) 262-1500 WWW.HED.DESIGN







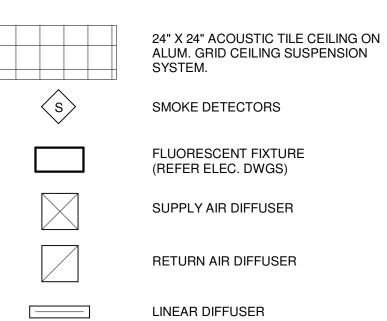


CEILING PLAN GENERAL NOTES

- COORDINATE FINAL SIZE AND FINAL LOCATION OF ALL Α. ACCESS PANELS WITH TRADE REQUIRING SAME.
- COORDINATE CEILING SUSPENSION SYSTEMS WITH OTHER CEILING SPACE EQUIPMENT SUPPORTING DEVICES.
- SEE SHEET A-571 FOR PARTITION TYPES .
- ALL EXISTING WALLS IN PROJECT AREA TO MEET FIRE RATINGS INDICATED ON REFLECTED CEILING PLAN.
- CEILING GRID SYSTEM TO BE CENTERED IN ROOM IN BOTH
- DIRECTIONS UNLESS OTHERWISE NOTED. NO CEILING PANEL TO BE CUT TO LESS THAN 6" WIDTH AT
- CEILING PANEL INSTALLATION TYPICAL. AT CONDITIONS WHERE CEILING TILE PADS EXCEED 2'-0" G.
- TRIM 2' X 4' CEILING PADS AS REQUIRED TO FIT. SPRINKLER HEADS TO BE LOCATED IN THE CENTER OF Н.
- CEILING PANELS (TYPICAL). PAINT ALL EXPOSED (VISUAL) CONSTRUCTION ABOVE CEILINGS
- INCLUDING, BUT NOT LIMITED TO MECH. & ELECTRICAL ITEMS. SEE NOTES ON REFLECTED CEILING SHEETS FOR EXTENT OF SCOPE.
- VERIFY EXACT LOCATIONS OF SOFFIT AND CEILING CONTROL JOINTS WITH THE ARCHITECTS REPRESENTATIVE IN THE FIELD.
- REFER TO A-161 SERIES DRAWINGS FOR LOCATIONS OF CEILING MOUNTED EQUIPMENT.
- COORDINATE THE LOCATION OF ESCUTCHEON PLATES AT М. CEILING PANEL PENETRATIONS WITH ELECTRICAL AND MECHANICAL TRADES.
- N. SEE ELECTRICAL DRAWINGS FOR FIXTURE TYPES.
- REPAIR (OR REPLACE WITH NEW) EXISTING CEILING PANELS AND GRID WHERE WALLS WERE REMOVED.
- CONTRACTOR SHALL MAINTAIN THE FIRE RATING INTEGRITY OF ALL EXISTING PARTITIONS INDICATED AS FIRE RESISTANCE RATED. ADVISE THE ARCHITECT OF ANY PRE-EXISTING BREACHES DISCOVERED IN THE COURSE OF THE WORK.

CEILNG PLAN LEGEND

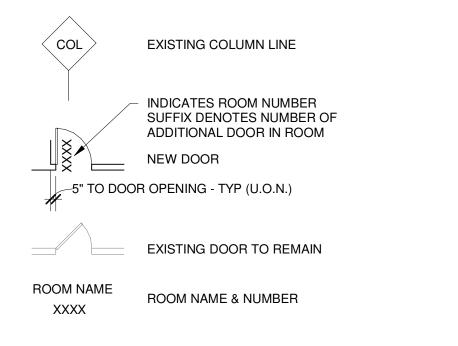
2-HOUR FIRE BARRIER



FLOOR PLAN GENERAL NOTES

- 1. ALL PARTITION TYPES () ARE "A2" (TYP.) UNLESS OTHERWISE NOTED. - SEE SHEET A-571 FOR PARTITION TYPES.
- 2. COORDINATE PARTITION FIRE RATING REQUIREMENTS AS INDICATED ON REFLECTED CEILING PLAN SHEET (A-101)
- . SEE EQUIPMENT PLANS (A-161) FOR EQUIPMENT AND RELATED WALL REINFORCEMENT
- 4. CONTRACTOR SHALL VERIFY ALL BUILDING DIMENSIONS, PARTITION AND WALL LOCATIONS AND FLOOR ELEVATIONS AND NOTIFY THE ARCHITECT/ ENGINEER OF ANY DISCREPANCIES BEFORE START OF WORK.
- DIMENSIONS FOLLOWED BY +/- SHALL BE REVIEWED AND ALL NECESSARY ADJUSTMENTS MADE PRIOR TO FABRICATION AND/OR INSTALLATION OF WORK.
- ALL EXISTING CONSTRUCTION REMAINING BUT AFFECTED BY THE WORK UNDER THIS CONTRACT SHALL BE RESTORED AND REFINISHED TO MATCH THE MATERIALS, FINISH AND ALIGNMENT OF THE EXISTING ADJACENT CONSTRUCTION.
- VERIFY QTY, SIZE AND LOCATION OF ALL FLOOR, ROOF AND WALL OPENINGS FOR MECHANICAL AND ELECTRICAL WORK WITH THE APPROPRIATE TRADE. PROVIDE ALL OPENINGS SHOWN OR REQUIRED FOR COMPLETION OF WORK.
- 8. COORDINATE SIZE AND LOCATION OF ALL ACCESS PANELS WITH APPROPRIATE TRADES.
- 9. ALL DIMENSIONS LOCATING STUD PARTITIONS ARE TO FINISH FACE OF PARTITION.
- 10. PROVIDE TRANSITIONS AT FLOORING MATERIALS PER DETAILS ON INTERIOR FINISH PLANS (A-161)
- 11. WHERE FIRE RATED PARTITIONS TERMINATE AT EXTERIOR WALLS, PROVIDE FIRE SAFING INSULATION FROM END OF PARTITION TO INTERIOR FACE OF EXTERIOR SHEATHING - 5" DEPTH X FULL HEIGHT OF CONSTRUCTION (TYPICAL)
- 12. WHERE RECESSED ITEMS ARE LOCATED IN FIRE RATED PARTITIONS, PROVIDE GYPSUM BOARD OF EQUIVALENT THICKNESS AND LAYERS BEHIND RECESSED ITEM TO MAINTAIN FIRE RATING OF PARTITION ASSEMBLY
- 13. PATCH AND REPAIR EXISTING PARTITIONS AT REMOVED RECESSED ITEMS AND AT NEW DOOR OPENINGS. CUT BACK EXISTING GYPSUM BOARD TO NEXT STUD. JOINT BETWEEN NEW AND EXISTING GYPSUM BOARD SHALL BE SECURED TO A COMMON EXISTING STUD.
- 14. PATCH AND REPAIR EXISTING CONCRETE SLAB AT REMOVED FLOOR DRAINS, WATER CLOSETS, DUCT PENETRATIONS AND OTHER REMOVED UTILITIES. PROVIDE CONCRETE IN THICKNESS REQUIRED TO MAINTAIN FIRE RATING OF FLOOR SLAB.
- 15. LEVEL AND SCARIFY EXISTING SLABS TO PROVIDE ACCEPTABLE SUBSTRATE FOR SCHEDULED FLOORING.

FLOOR PLAN LEGEND



FLOOR PLAN KEYNOTES

Section Se VENDOR

DEMOLITION GENERAL NOTES

- 1. THE ARCHITECT HAS NO RESPONSIBILITY FOR THE DISCOVERY, PRESENCE, HANDLING, REMOVAL, OR DISPOSAL OF, OR EXPOSURE O PERSONS TO, HAZARDOUS MATERIALS OR TOXIC SUBSTANCES IN AN FORM AT THE PROJECT SITE, INCLUDING BUT NOT LIMITED TO ASBES ASBESTOS PRODUCTS, POLYCHLORINATED BIPHENYL (PCB), LEAD P/ OR OTHER TOXIC SUBSTANCES. THE FACT THAT THESE DOCUMENTS NOT INDICATE THE PRESENCE OF OR REMOVAL OR CONTAINMENT OF THE FOREGOING IS NOT INTENDED TO INDICATE THAT THESE MATER OR SUBSTANCES, AMONG OTHERS, ARE NOT PRESENT AND ARE NOT REQUIRED TO BE REMOVED OR CONTAINED IN COMPLIANCE WITH FEDERAL, STATE AND LOCAL REGULATIONS.
- 2. THE OWNER'S NORMAL OPERATIONS WILL BE CONTINUED DURING DEMOLITION. DEMOLITION CONTRACTOR SHALL NOT INTERFERE WITH THESE OPERATIONS IN ANY WAY WITHOUT THE OWNER'S EXPRESSED CONSENT.
- . OWNER WILL OCCUPY PORTIONS OF THE BUILDING IMMEDIATELY ADJACENT TO AREAS OF SELECTIVE DEMOLITION. CONDUCT SELECTIVE DEMOLITION WORK IN MANNER THAT WILL MINIMIZE NEED FOR DISRUPTION OF OWNER'S NORMAL OPERATIONS. PROVIDE MINIMUM OF 72 HOURS ADVANCE NOTICE TO OWNER OF DEMOLITION ACTIVITIES THAT WILL AFFECT OWNER'S NORMAL OPERATIONS.
- 4. PROVIDE TEMPORARY BARRICADES AND OTHER FORMS OF PROTECTION TO PROTECT OWNER'S PERSONNEL AND GENERAL PUBLIC FROM INJURY DUE TO SELECTIVE DEMOLITION WORK.
- PROTECT FROM DAMAGE EXISTING FINISH WORK THAT IS TO REMAIN IN PLACE AND BECOMES EXPOSED DURING DEMOLITION OPERATIONS.
- 6. PROTECT FLOORS WITH SUITABLE COVERING WHEN NECESSARY. 7. COVER AND PROTECT FURNITURE, EQUIPMENT, AND FIXTURES FROM
- SOILING OR DAMAGE WHEN DEMOLITION WORK IS PERFORMED IN AREAS WHERE SUCH ITEMS HAVE NOT BEEN REMOVED. 8. PRIOR TO CUTTING EXISTING CONSTRUCTION, LOCATE AND IDENTIFY SERVICES TO REMAIN IN OPERATION, INCLUDING ALL FLOOR
- PENETRATIONS, UNDOCUMENTED CONDITIONS, UTILITY RISERS, ETC. AND ANY WALLS THAT CONTAIN LIFE SAFETY VERTICAL RISERS THAT MUST REMAIN IN OPERATION DURING THE DEMOLITION WORK. 9. CONTRACTOR SHALL VERIFY ALL EXISTING BUILDING DIMENSIONS,
- PARTITION AND WALL LOCATIONS AND FLOOR ELEVATIONS IN FIELD AND NOTIFY THE OWNER'S REPRESENTATIVE OF ANY DISCREPANCIES BEFORE THE START OF WORK.
- 10. WHEN UNANTICIPATED MECHANICAL, ELECTRICAL, OR STRUCTURAL ELEMENTS THAT CONFLICT WITH INTENDED FUNCTION OF DESIGN ARE ENCOUNTERED, INVESTIGATE AND MEASURE BOTH NATURE AND EXTENT OF THE CONFLICT AND NOTIFY OWNER'S REPRESENTATIVE.
- 11. MAINTAIN EXISTING UTILITIES INDICATED TO REMAIN IN SERVICE AND PROTECT THEM AGAINST DAMAGE DURING DEMOLITION OPERATIONS. DO NOT INTERRUPT UTILITIES SERVING OCCUPIED OR USED FACILITIES, EXCEPT WHEN AUTHORIZED IN WRITING BY AUTHORITIES HAVING JURISDICTION. PROVIDE TEMPORARY SERVICES DURING INTERRUPTIONS TO EXISTING UTILITIES, AS ACCEPTABLE TO GOVERNING AUTHORITIES.
- 12. WHERE DEMOLITION IS REQUIRED BEYOND THE LIMITS OF THE CONTRACT TO ROUTE NEW DUCTWORK, PIPING, CONDUITS ETC., RATED WALLS AND SMOKE BARRIERS SHALL BE PATCHED BY CONTRACTOR REQUIRING PENETRATIONS. ALL FINISHES DAMAGED BY THE WORK SHALL BE RESTORED TO THEIR ORIGINAL CONDITION.
- 13. REPAIR DEMOLITION PERFORMED IN EXCESS OF THAT REQUIRED. RETURN ELEMENTS OF CONSTRUCTION AND SURFACES TO REMAIN, TO THE CONDITION EXISTING PRIOR TO START OF OPERATIONS. REPAIR ADJACENT CONSTRUCTION OR SURFACES SOILED OR DAMAGED BY SELECTIVE DEMOLITION.
- 14. PROVIDE SHORING, BRACING AND ANY OTHER MEANS REQUIRED TO PROTECT AND MAINTAIN THE SAFETY, INTEGRITY AND STABILITY OF ALL EXISTING AND NEW CONSTRUCTION.
- 15. WHEN ROOFING, GLAZING, FLASHING, COPING OR PORTIONS OF EXTERIOR WALLS ARE REMOVED OR OPENED, SUITABLE WEATHER PROTECTION SHALL BE PROVIDED AND MAINTAINED FOR THE DURATION OF WORK AND SECURED AND SEALED WEATHERTIGHT DAILY.
- 16. ERECT AND MAINTAIN 1 HOUR FIRE RESISTANCE RATED TEMPORARY PARTITIONS WHERE REQUIRED TO PROTECT EXISTING CONSTRUCTION AND OWNER'S OPERATIONS.
- 17. REMOVAL OF ITEMS NOTED INCLUDES REMOVAL OF ANCHORS, ADHESIVES, HARDWARE, CONDUIT, WIRE, PIPING, ETC. FOR A COMPLETE REMOVAL OF THE ITEMS OR SYSTEMS.
- 18. WHERE NEW CEILINGS ARE SHOWN OR NOTED, COMPLETELY REMOVE EXISTING CEILING AND SUSPENSION SYSTEM. SUSPEND NEW CEILING FROM CONSTRUCTION ABOVE.
- 19. WHEREVER WATER CLOSETS, FLOOR SINKS OR OTHER EQUIPMENT AND RELATED PIPING ARE TO BE REMOVED, PATCH FLOOR SLAB WITH CONCRETE AS REQUIRED. 20. ALL DEMOLITION WORK REQUIRED IS NOT LIMITED TO WHAT IS SHOWN
- ON THE DEMOLITION PLANS. THE INTENT IS TO REMOVE ALL MECHANICAL, ELECTRICAL AND ARCHITECTURAL ITEMS AS REQUIRED TO FACILITATE NEW CONSTRUCTION. SEE MECHANICAL AND ELECTRICAL 21. DEMOLITION DRAWINGS FOR ADDITIONAL SCOPE OF DEMOLITION WORK.
- 22. REFER TO FINISH SCHEDULE FOR ADDITIONAL FINISH WORK REQUIRED IN OTHER AREAS THAT ARE NOT DOCUMENTED TO RECEIVE DEMOLITION/ REMOVAL WORK (TYPICAL). 23. REFER TO SPECIFICATIONS FOR ADDITIONAL REQUIREMENTS.

NOTES: REMOVE WALL COVERING AND RESILIENT BASE AT EXISTING WALLS TO REMAIN THAT ARE SCHEDULED TO RECEIVE NEW FINISHES. PREPARE WALL TO RECEIVE NEW FINISHES. COORDINATE EXTENT OF DEMOLITION WITH ROOM FINISH SCHEDULE TO ACCOMMODATE NEW MECHANICAL AND ELECTRICAL WORK. FIELD VERIFY EXISTING CONDITIONS. PATCH AND REPAIR WALLS TO MATCH EXISTING. MAINTAIN EXISTING FIRE RATINGS.

DEMOLITION LEGEND

1-HR FIRE RATED PARTITION FOR TEMPORARY CONSTRUCTION PROTECTION – – – – – – EXISTING TO BE REMOVED

EXISTING TO REMAIN

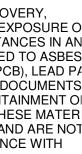
EXISTING SLAB-ON-GRADE. PREPARED AREA FOR NEW DEPRESSED SLAB ON GRADE. ALL DEMOLITION WORK REQUIRED IS NOT NECESSARILY LIMITED

TO WHAT IS SHOWN ON THE DEMOLITION PLANS. THE INTENT IS TO REMOVE ALL MECHANICAL, ELECTRICAL AND ARCHITECTURAL ITEMS AS REQUIRED TO FACILITATE NEW CONSTRUCTION.

REFER TO FINISH SCHEDULE FOR ANY ADDITIONAL FINISH WORK REQUIRED IN OTHER AREAS THAT ARE NOT DOCUMENTED TO RECEIVE ANY DEMOLITION/ REMOVAL WORK AS INDICATED ON DEMOLITION PLANS (TYPICAL).

DEMOLITION KEYNOTES

- (A) PROVIDE TEMPORARY 1-HR FIRE RATED CONSTRUCTION PROTECTION PARTITION - FULL HEIGHT TO BOTTOM OF EXISTING ROOF STRUCTURAL DECK WITH 3/4 HOUR MINIMUM RATED ACCESS DOOR
- (1) REMOVE EXISTING DOUBLE DOOR AND FRAME. PATCH WALL OPENING TO MATCH (E) PARTITION.
- (2) REMOVE EXISTING BORROWED LITE AND FRAME. PATCH WALL **OPENING TO MATCH (E) PARTITION.**
- (3) REMOVE EXISTING ROLLING SERVICE DOOR AND FRAME. PATCH WALL OPENING TO MATCH (E) PARTITION.
- (4) REMOVE PORTION OF EXISTING PARTITION. PATCH AND
- PREPARE WALL OPENING FOR NEW DOOR. (4A) REMOVE PORTION OF EXISTING PARTIAL HEIGHT PARTITION.
- PATCH AND REPAIR EXISTING WALL AS REQUIRED. (5) REMOVE PORTION OF EXISTING EXTERIOR CONC. MASONRY
- WALL. PREPARE WALL OPENING TO RECEIVE NEW WORK.
- 6 DISCONNECT & SALVAGE (E) EMERGENCY EYEWASH / SHOWER UNIT. REFER TO SHEET A-161 "EQUIPMENT LIST" AND PLAN FOR RE-USE / NEW LOCATION.
-) REMOVE & SALVAGE (E) BASE CABINET. REFER TO SHEET A-161 "EQUIPMENT LIST" AND PLAN FOR RE-USE / NEW
- LOCATION. (7A) REMOVE (E) SOLID SERVICE COUNTER AND SINK / FAUCET.
- (8) REMOVE, DISCONNECT & SALVAGE (E) BASE CABINET AND FUMEHOOD. REFER TO SHEET A-161 "EQUIPMENT LIST" AND
- PLAN FOR RE-USE / NEW LOCATION.) REMOVE (E) SERVICE SINK AND FAUCET.
-) DISCONNECT & SALVAGE (E) GAS CABINET. REFER TO SHEET A-161 "EQUIPMENT LIST" AND PLAN FOR RE-USE / NEW LOCATION.



FOR ENTIRE FLOOR IN SHADED AREA SAWCUT AND COMPLETELY REMOVE ALL



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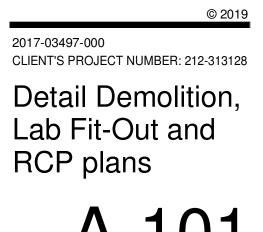
I2C MRI Installation -Lab 5 Fit-Out

461 Burroughs St. Detroit, MI 48202

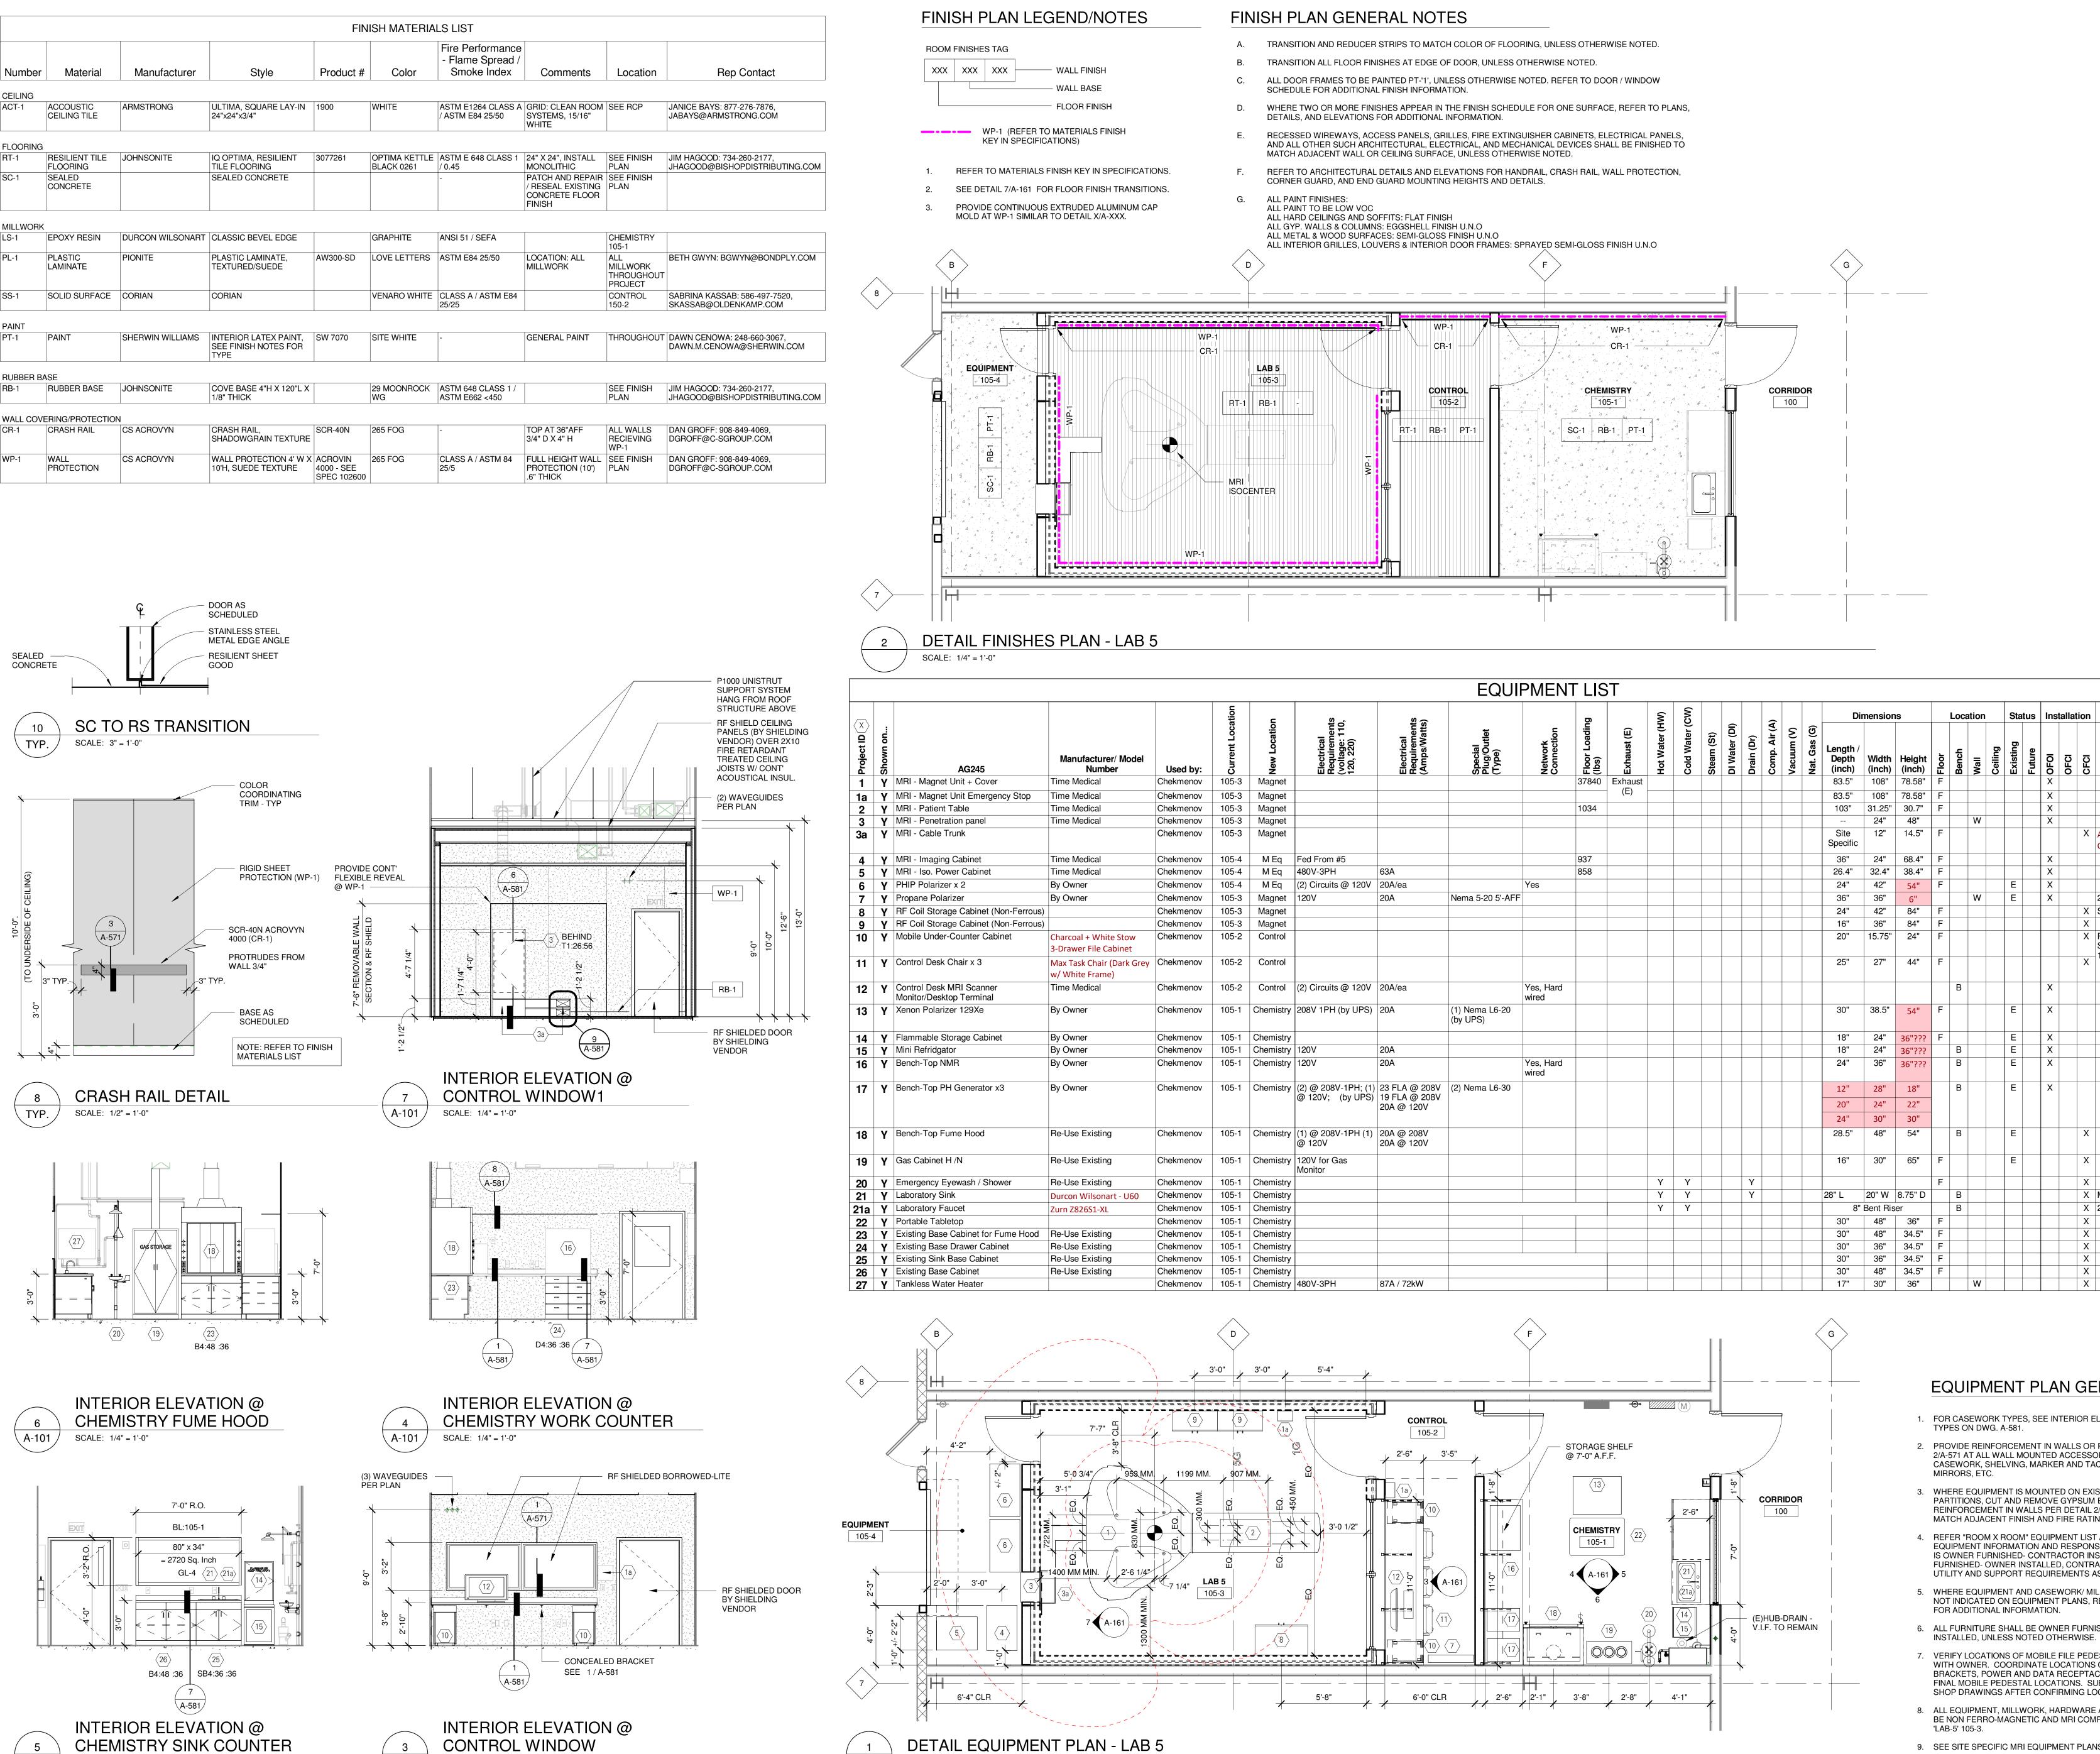
| Issued For |
|--------------------|
| Design Development |
| Owner Review |
| Bids / Permits |
| Addendum 1 |
| Addendum 2 |
| |



Southfield, Michigan 48033 USA (248) 262-1500 WWW.HED.DESIGN



| | | | | FIN | IISH MATERIA | LS LIST | | |
|----------|----------------------------|------------------|---|-----------|-----------------------------|---|---|---|
| Number | Material | Manufacturer | Style | Product # | Color | Fire Performance - Flame Spread / Smoke Index | Comments | Location |
| CEILING | | | | | | | | |
| ACT-1 | ACCOUSTIC CEILING TILE | ARMSTRONG | ULTIMA, SQUARE LAY-IN 24"x24"x3/4" | 1900 | WHITE | ASTM E1264 CLASS A / ASTM E84 25/50 | GRID: CLEAN ROOM SYSTEMS, 15/16" WHITE | SEE RCP |
| FLOORING | | | | | | • | | |
| RT-1 | RESILIENT TILE FLOORING | JOHNSONITE | IQ OPTIMA, RESILIENT TILE FLOORING | 3077261 | OPTIMA KETTLE BLACK 0261 | ASTM E 648 CLASS 1 / 0.45 | 24" X 24", INSTALL MONOLITHIC | SEE FINISH PLAN |
| SC-1 | SEALED CONCRETE | | SEALED CONCRETE | | | - | PATCH AND REPAIR / RESEAL EXISTING CONCRETE FLOOR FINISH | |
| MILLWORK | < | | | | | | | |
| LS-1 | EPOXY RESIN | DURCON WILSONART | CLASSIC BEVEL EDGE | | GRAPHITE | ANSI 51 / SEFA | | CHEMISTRY 105-1 |
| PL-1 | PLASTIC LAMINATE | PIONITE | PLASTIC LAMINATE, TEXTURED/SUEDE | AW300-SD | LOVE LETTERS | ASTM E84 25/50 | LOCATION: ALL MILLWORK | ALL MILLWORK THROUGHOL PROJECT |
| SS-1 | SOLID SURFACE | CORIAN | CORIAN | | VENARO WHITE | CLASS A / ASTM E84 25/25 | | CONTROL 150-2 |
| PAINT | | | | | | | | |
| PT-1 | PAINT | SHERWIN WILLIAMS | INTERIOR LATEX PAINT, SEE FINISH NOTES FOR TYPE | SW 7070 | SITE WHITE | - | GENERAL PAINT | THROUGHOL |
| RUBBER B | ASE | | | | | | | |
| RB-1 | RUBBER BASE | JOHNSONITE | COVE BASE 4"H X 120"L X 1/8" THICK | | 29 MOONROCK WG | ASTM 648 CLASS 1 / ASTM E662 <450 | | SEE FINISH PLAN |
| WALL COV | ERING/PROTECTIO | N | | | | | | |
| CR-1 | CRASH RAIL | CS ACROVYN | CRASH RAIL, SHADOWGRAIN TEXTURE | SCR-40N | 265 FOG | - | TOP AT 36"AFF 3/4" D X 4" H | ALL WALLS RECIEVING WP-1 |
| WP-1 | WALL | CS ACROVYN | WALL PROTECTION 4' W X | ACROVIN | 265 FOG | CLASS A / ASTM 84 | FULL HEIGHT WALL | SEE FINISH |



∖A-101

SCALE: 1/4" = 1'-0"

∖ A-101

SCALE: 1/4" = 1'-0"

DETAIL EQUIPMENT PLAN - LAB 5 SCALE: 1/4" = 1'-0"

1

| \$ \$ | | | 5 | | ŝ | (MC | | | | | | | Di | mension | IS | | Locatio | n | Sta | atus | Inst | tallat | ion | |
|------------------------------|----------------------------------|-----------------------|------------------------|----------------|----------------|-----------------|------------|---------------|------------|---------------|------------|--------------|-----------------------------|-----------------|------------|----------|---------------|---------|----------|--------|------|--------|------|---|
| Hequirements (Amps/Watts) | Special Plug/Outlet (Type) | Network Connection | Floor Loading (Ibs) | Exhaust (E) | Hot Water (HW) | Cold Water (CW) | Steam (St) | DI Water (DI) | Drain (Dr) | Comp. Air (A) | Vacuum (V) | Nat. Gas (G) | Length / Depth (inch) | Width (inch) | (inch) | Ĭ | Bench Wall | Ceiling | Existing | Future | OFOI | OFCI | CFCI | Special Requirements/ Comments |
| | | | 37840 | Exhaust (E) | | | | | | | | | 83.5" | 108" | 78.58" | F | | | | | Х | | | |
| | | | | (=) | | | | | | | | | 83.5" | 108" | 78.58" | F | | | | | X | | | |
| | | | 1034 | | | | | | | | | | 103" | 31.25" | 30.7" | F | | | | | X | | | |
| | | | | | | | | | | | | | | 24" | 48" | <u> </u> | W | | | | X | | | |
| | | | | | | | | | | | | | Site Specific | 12" | 14.5" | F | | | | | | | | Above Floor Cable Truck, w/ Access Cabinet Type "T1" CFCI |
| | | | 937 | | | | | | | | | | 36" | 24" | 68.4" | F | | | | | Х | | | |
| | | | 858 | | | | | | | | | | 26.4" | 32.4" | 38.4" | F | | | | | X | | | |
| | | Yes | | | | | | | | | | | 24" | 42" | 54" | F | | | E | | X | | | |
| | Nema 5-20 5'-AFF | | | | | | | | | | | | 36" | 36" | 6" | | W | | E | | X | | | 2 pieces |
| | | | | | | | | | | | | | 24" | 42" | 84" | F | | | | | | | Х | See Detail 5/A-581 @ Type "T2" |
| | | | | | | | | | | | | | 16" | 36" | 84" | F | | | | | | | Х | |
| | | | | | | | | | | | | | 20" | 15.75" | 24" | F | | | | | | | Х | FLAGSHIP SHOWROOM: 16 Madiso Square West, 3rd Fl. New York, NY 10010 www.poppin.com |
| | | | | | | | | | | | | | 25" | 27" | 44" | F | | | | | | | Х | |
| | | Yes, Hard wired | | | | | | | | | | | | | | | В | | | | X | | | |
| | (1) Nema L6-20 (by UPS) | | | | | | | | | | | | 30" | 38.5" | 54" | F | | | E | | X | | | |
| | | | | | | | | | | | | | 18" | 24" | 36"??? | F | | | E | | X | | | |
| | | | | | | | | | | | | | 18" | 24" | 36"??? | | В | | E | | X | | | |
| | | Yes, Hard wired | | | | | | | | | | | 24" | 36" | 36"??? | | В | | E | | X | | | |
| @ 208V | (2) Nema L6-30 | | | | | | | | | | | | 12" | 28" | 18" | | В | | E | | X | | | |
| @ 208V 208V | | | | | | | | | | | | | 20" | 24" | 22" | - | | | | | | | | |
| 120V | | | | | | | | | | | | | | | | - | | | | | | | | |
| 208V 120V | | | | | | | | | | | | | 24" 28.5" | 30" 48" | 30" 54" | | B | | E | | | | Х | |
| 201 | | | | | | | | | | | | | 16" | 30" | 65" | F | | | E | | | | Х | |
| | | | | | | ~~~ | | | | | | | | | | - | | | | | | | ~ | |
| | | | | | Y | Y | | | Y | | | | 00" | 00") (| 0 75" 5 | F | | _ | | | | | X | |
| | | | | | Y | Y | | | Y | | | | 28" L | | 8.75" D | | B | | - | - | | | | Match Epoxy Resin Countertop Finish |
| | | | | | Y | Y | | | | | | | | Bent Ris | | | В | | | | | | | 2.2 GPM, Polished Chrome |
| | | | | | | | | | | | | | 30" | 48" | 36" | F | | | | | | | Х | |
| | | | | | | | | | | | | | 30" | 48" | 34.5" | F | | | | | | | Х | |
| | | | | | | | | | | | | | 30" | 36" | 34.5" | F | | | | | | | Х | |
| | | | | | | | | | | | | | 30" | 36" | 34.5" | F | | | | | | | Х | |
| | | | | | | | | | | | | | 30" | 48" | 34.5" | F | | | | | | | Х | |
| kW | | | | | 1 | | 1 | I E | | | | | 17" | 30" | 36" | 1 | W | 1 | 1 | | 1 | | X | |

EQUIPMENT PLAN GENERAL NOTES

- 1. FOR CASEWORK TYPES, SEE INTERIOR ELEVATIONS AND CABINET TYPES ON DWG. A-581.
- PROVIDE REINFORCEMENT IN WALLS OR PARTITIONS PER DETAIL 2/A-571 AT ALL WALL MOUNTED ACCESSORIES, EQUIPMENT, CASEWORK, SHELVING, MARKER AND TACKBOARDS, CLOCKS, MIRRORS, ETC.
- 3. WHERE EQUIPMENT IS MOUNTED ON EXISTING WALLS OR PARTITIONS, CUT AND REMOVE GYPSUM BOARD TO INSTALL REINFORCEMENT IN WALLS PER DETAIL 2/A-571. FINISH WALL TO MATCH ADJACENT FINISH AND FIRE RATING.
- 4. REFER "ROOM X ROOM" EQUIPMENT LIST AS INDICATED FOR EQUIPMENT INFORMATION AND RESPONSIBILITY. WHERE EQUIPMENT IS OWNER FURNISHED- CONTRACTOR INSTALLED AND OWNER FURNISHED- OWNER INSTALLED, CONTRACTOR SHALL PROVIDE ALL UTILITY AND SUPPORT REQUIREMENTS AS NECESSARY.
- WHERE EQUIPMENT AND CASEWORK/ MILLWORK INFORMATION IS NOT INDICATED ON EQUIPMENT PLANS, REFER INTERIOR ELEVATIONS FOR ADDITIONAL INFORMATION.
- 6. ALL FURNITURE SHALL BE OWNER FURNISHED CONTRACTOR INSTALLED, UNLESS NOTED OTHERWISE.
- 7. VERIFY LOCATIONS OF MOBILE FILE PEDESTALS (C.F.C.I.) IN FIELD WITH OWNER. COORDINATE LOCATIONS OF COUNTERTOP SUPPORT BRACKETS, POWER AND DATA RECEPTACLES AND GROMMETS WITH FINAL MOBILE PEDESTAL LOCATIONS. SUBMIT MILLWORK/CASEWORK SHOP DRAWINGS AFTER CONFIRMING LOCATIONS WITH OWNER.
- 8. ALL EQUIPMENT, MILLWORK, HARDWARE AND ACCESSORIES MUST BE NON FERRO-MAGNETIC AND MRI COMPATIBLE WITHIN ROOM 'LAB-5' 105-3.
- 9. SEE SITE SPECIFIC MRI EQUIPMENT PLANS FOR MORE INFORMATION.



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HED

26913 Northwestern Hwy Suite 200 Southfield, Michigan 48033 USA (248) 262-1500 WWW.HED.DESIGN





SCALE: 3/8" = 1'-0"

SCALE: 1 1/2" = 1'-0"

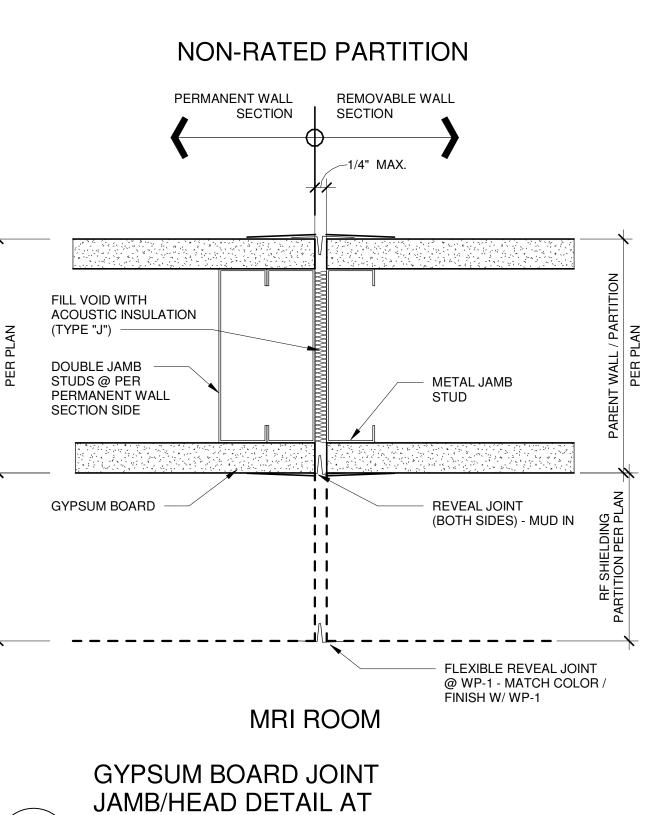
FILL VOID WITH (TYPE "J") -

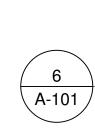
METAL STUD GYPSUM BOARD

SCALE: 6" = 1'-0"

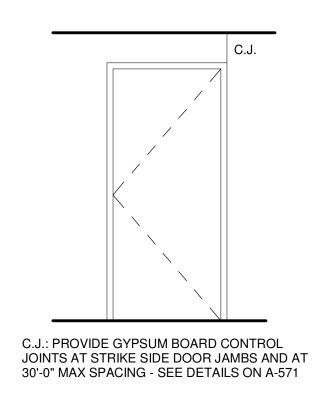
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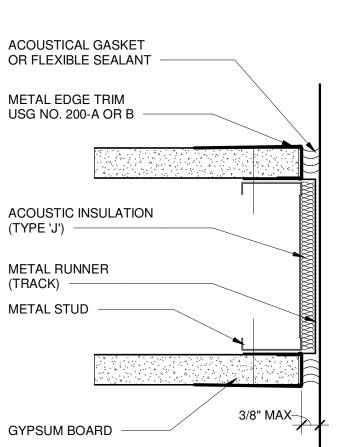




REMOVABLE WALL SECTION SCALE: 6" = 1'-0"

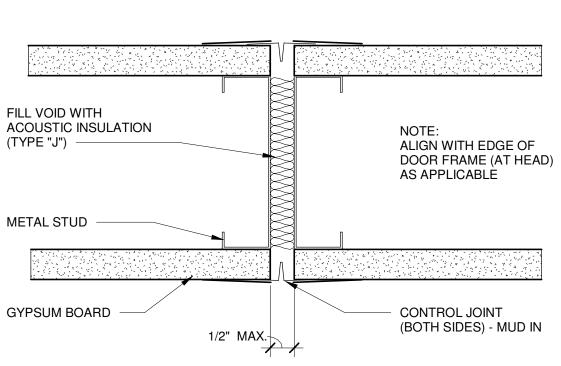


GYPSUM BOARD CONTROL JOINT AT DOOR



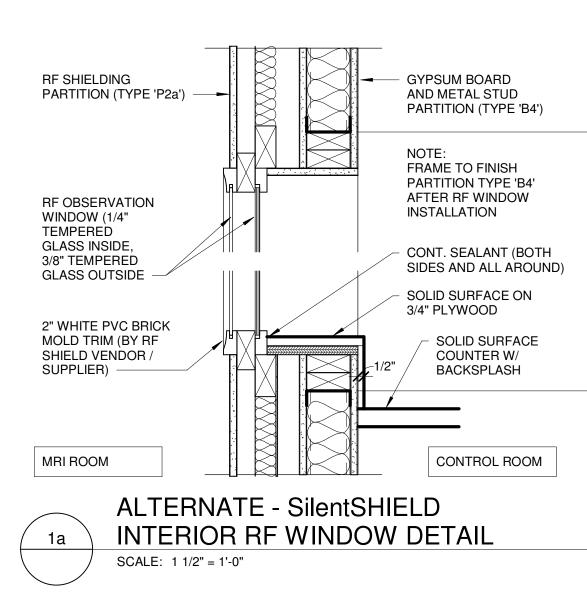
REFERENCE GYPSUM ASSOCIATIONS GA-600-2006 FIRE RESISTANCE DESIGN MANUAL (18th EDITION) PERIMETER RELIEF DETAILS (Figure 9)

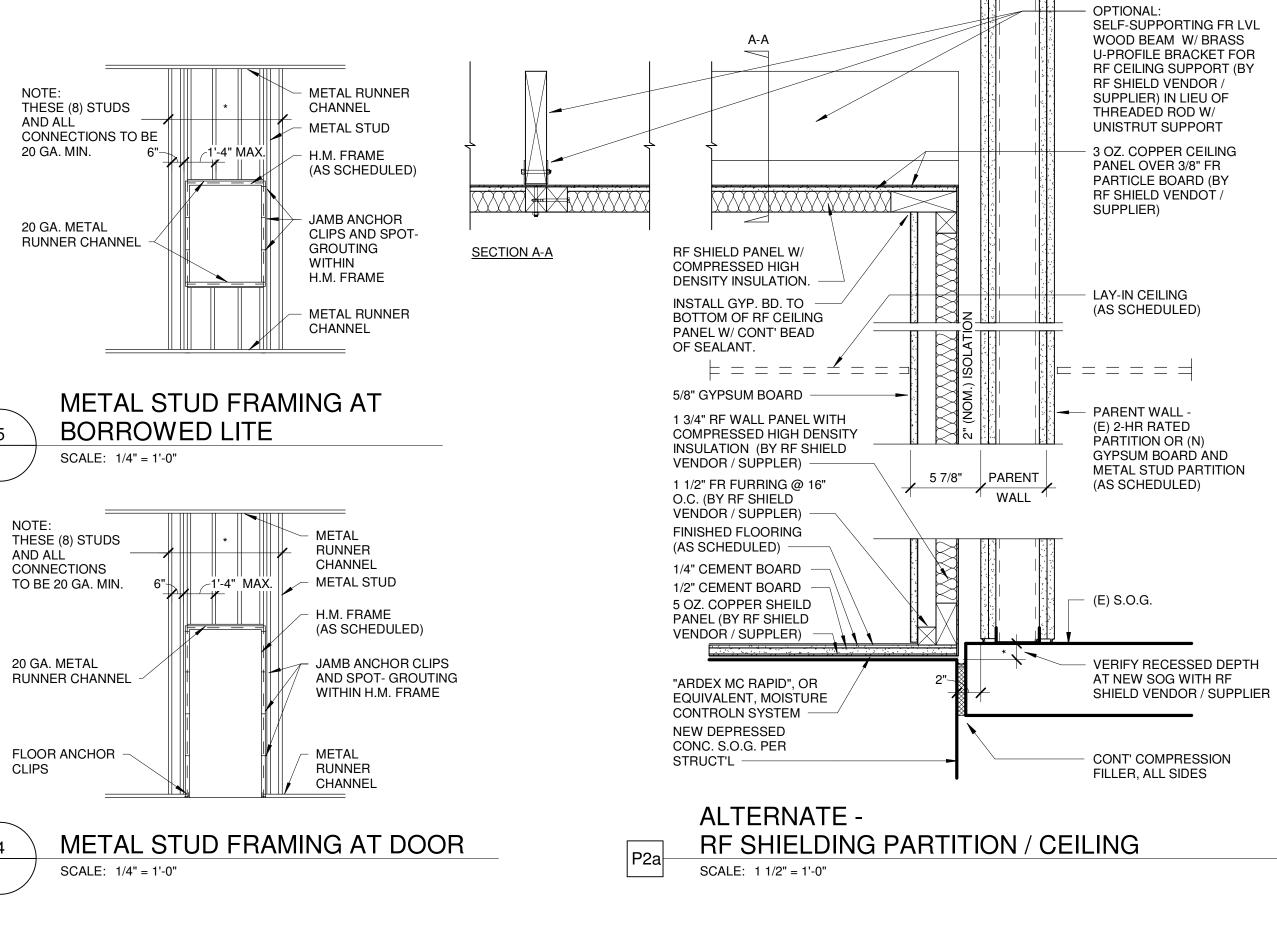


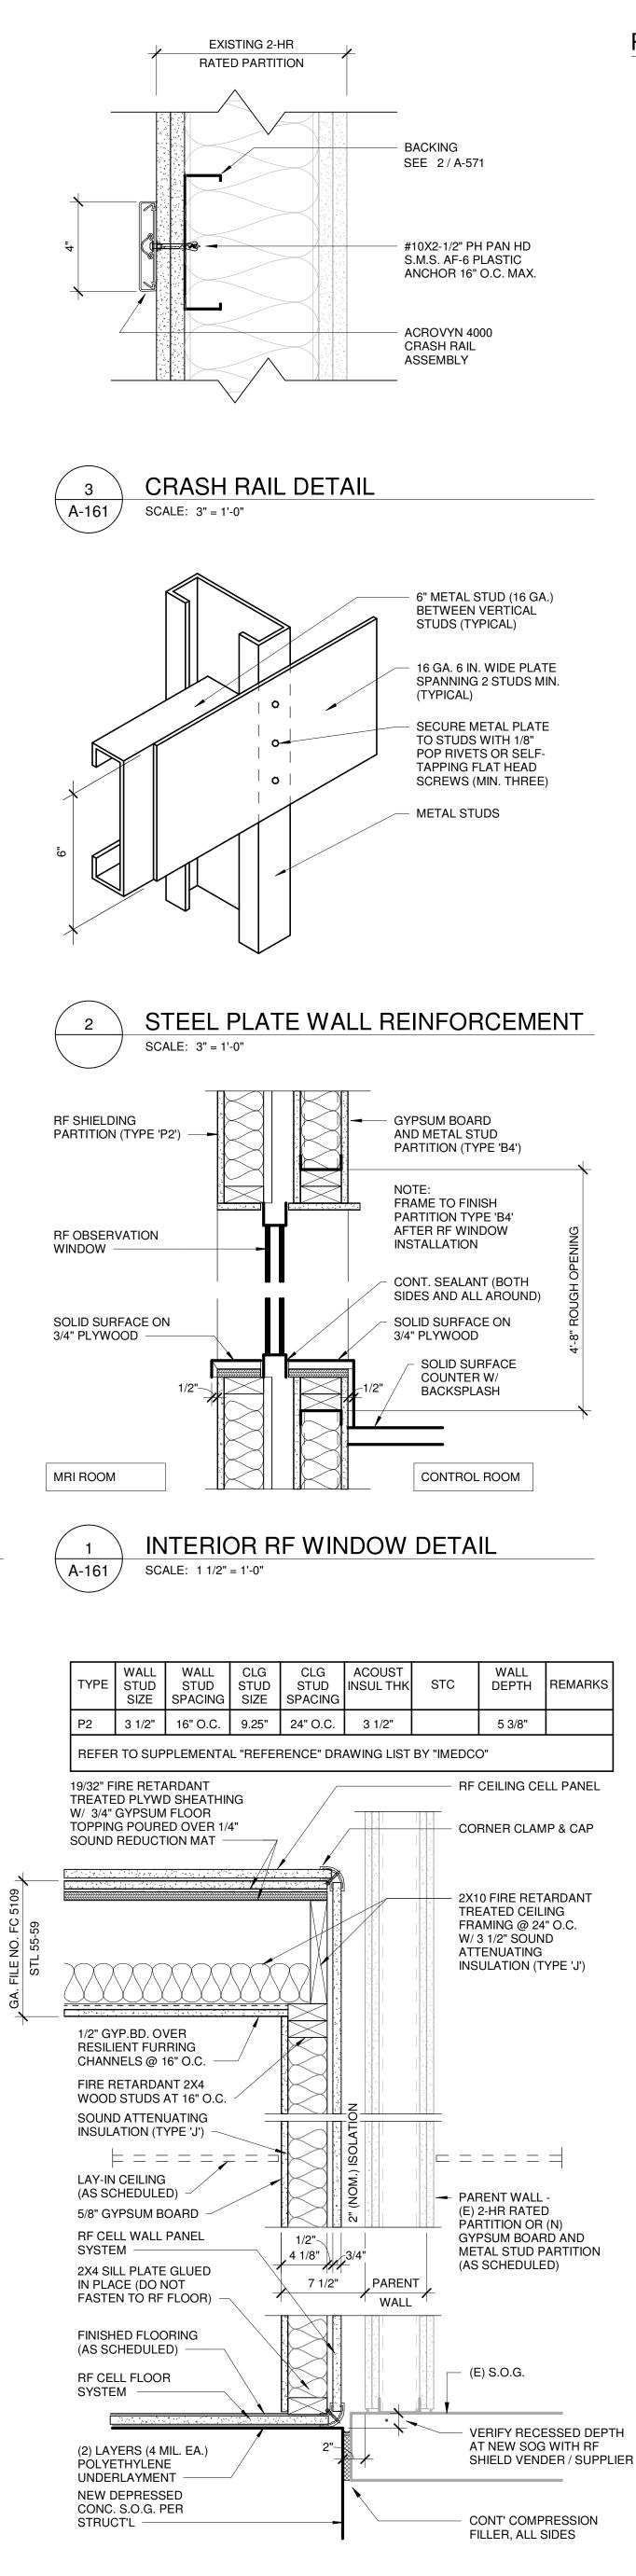


NON-RATED PARTITION

GYPSUM BOARD CONTROL JOINT (C.J.) DETAIL



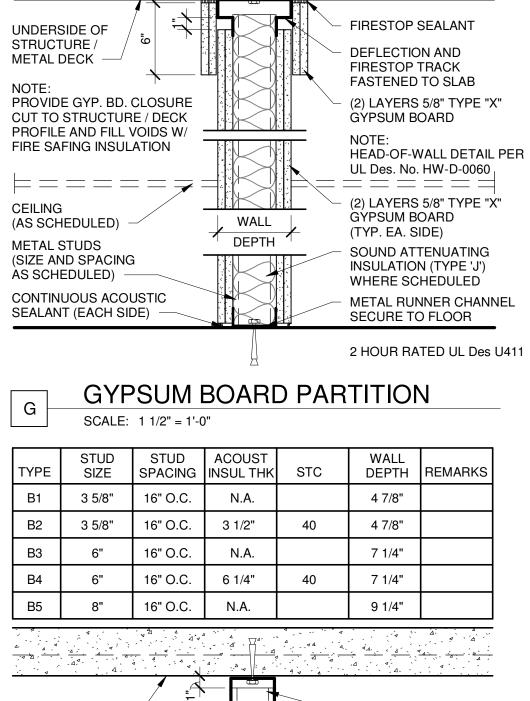




PARTITION GENERAL NOTES

- 1. SEE A-61X SERIES DRAWINGS FOR ROOM FINISH SCHEDULE.
- 2. PROVIDE NON-COMPOSITE METAL FRAMING ASSEMBLIES OF METAL STUD DEPTH AND SPACING AS INDICATED FOR PROJECT SPECIFIC SPANS MEETING A ALLOWABLE DEFLECTION OF L/240 WITH MINIMUM LATERAL LOAD OF 5 PSF FOR LIMITING HEIGHTS. PROVIDE 20 GA. STUDS (MINIMUM) ON ALL FLOORS. PROVIDE HEAVIER GAUGE AND/OR WIDER FLANGE WIDTH TO MEET STATED PERFORMANCE REQUIREMENTS FOR LIMITING HEIGHTS. COMPLY WITH METAL FRAMING SUPPLIERS REQUIREMENTS FOR BRACING STUD FLANGES AND PROVIDING HORIZONTAL MECHANICAL BRIDGING AT 48" O.C. MAXIMUM VERTICA SPACING
- 3. WALL TYPES SHOW ONLY BASE WALL CONSTRUCTION. WOOD TRIM, ACOUSTICAL PANELS, ETC. MAY BE ADDED AS SCHEDULED OR DETAILED.
- 4. LOCATE VERTICAL CONTROL JOINTS AT 30'-0" 0.C.(MAX.) OR AS SHOWN ON PLANS OR "CJ" ON ELEVATIONS.
- 5. SEE FLOOR PLANS (A-10X SERIES DRAWINGS) FOR SPECIFIC LOCATIONS OF PARTITION WALLS
- 6. AT FULL- HEIGHT PARTITIONS WHERE DUCTWORK OR OTHER OBSTACLES PREVENT EXTENSION OF ALL STUDS TO DECK, FRAME STUDS AROUND OBSTACLES WITH HEADERS AND BRACING AS NECESSARY. ATTACH DOUBLED STUDS AT ENDS TO DECK ABOVE.
- 7. AT PARTITIONS THAT ARE NOT FULL HEIGHT, PROVIDE FULL HEIGHT STUDS AT 4'-0" O.C.
- 8. PROVIDE 5/8" CEMENTITIOUS BACKER BOARD IN LIEU OF GYPSUM BOARD AT TILE LOCATIONS (REFERENCE ROOM FINISH SCHEDULE FOR LOCATIONS AND HEIGHT). AT CONTRACTOR'S OPTION, PROVIDE 5/8" DENSE SHIELD TILE BACKER BOARD AT PARTITIONS SCHEDULED TO RECEIVE TILE IN NON-WET AREAS. TILED SHOWER AREAS SHALL RECEIVE CEMENTITIOUS BACKER BOARD ONLY.
- 9. SECURELY ATTACHED STEEL FRAMING TOP AND BOTTOM RUNNERS WITH STUB NAILS, POWER-DRIVEN FASTENERS OR TAPCON CONCRETE FASTENING SYSTEM AT 24" O.C. MAX.

| TYPE | STUD SIZE | STUD SPACING | ACOUST | STC | WALL DEPTH | REMARKS |
|------|--------------|-----------------|--------|-----|---------------|---------|
| G1 | 3 5/8" | 16" O.C. | N.A. | | 6 1/8" | |
| G2 | 3 5/8" | 16" O.C. | 3 1/2" | 52 | 6 1/8" | |
| G3 | 6" | 16" O.C. | N.A. | | 8 1/2" | |
| G4 | 6" | 16" O.C. | 6 1/4" | 52 | 8 1/2" | |
| G5 | 8" | 16" O.C. | N.A. | | 10 1/2" | |



| UNDERSIDE OF STRUCTURE / METAL DECK | | 3" HIGH LEG ME TRACK FASTEN TO SLAB |
|---|------|--|
| PROVIDE FULL HEIGHT STUDS AT 4'-0".C. | | ; |
| PROVIDE TRACK BETWEEN | | |
| CEILING | WALL | \ |
| (AS SCHEDULED) - | | 5/8" GYPSUM BC (TYP. EA. SIDE) |
| METAL STUDS (SIZE AND SPACING AS SCHEDULED) | | SOUND ATTENU INSULATION (TY WHERE SCHEDU |
| CONTINUOUS ACOUSTIC SEALANT (EACH SIDE) | | METAL RUNNER SECURE TO FLC |
| | | |

GYPSUM BOARD PARTITION B SCALE: 1 1/2" = 1'-0"

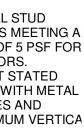
| TYPE | STUD SIZE | STUD SPACING | ACOUST INSUL THK | STC | WALL DEPTH | REMARKS | | | | | |
|--|----------------------------------|-----------------|---------------------|---|---------------------------|--------------------------------------|--|--|--|--|--|
| A1 | 3 5/8" | 16" O.C. | N.A. | | 4 7/8" | | | | | | |
| A2 | 3 5/8" | 16" O.C. | 3 1/2" | 4 | 4 7/8" | | | | | | |
| A3 | 6" | 16" O.C. | N.A. | 0 | 7 1/4" | | | | | | |
| A4 | 6" | 16" O.C. | 6 1/4" | 40 | 7 1/4" | | | | | | |
| A5 | 8" | 16" O.C. | N.A. | | 9 1/4" | | | | | | |
| 1 4 4 4 | | | | 4 44° 4 4 4 4 4 4 4 4 4 4 4 4 4 4 4 4 4 | | | | | | | |
| UNDERSIDE OF STRUCTURE / METAL DECK DO NOT SECURE STUDS AND/OR GYPSUM BOARD TO HIGH LEG TRACK | | | | | | | | | | | |
| ├── ── CEILING (AS SCF | | | WALL PEPTH | | 5/8" GYPSU (TYP. EA. S | - | | | | | |
| | STUDS ND SPACING EDULED) — | ì | | | | TENUATING N (TYPE 'J') HEDULED | | | | | |
| | UOUS ACOU IT (EACH SII | | | | METAL RUN SECURE TO | NNER CHAN D FLOOR | | | | | |
| | | | | | | | | | | | |
| A | GYPSUM BOARD PARTITION | | | | | | | | | | |

A –

SCALE: 1 1/2" = 1'-0"

P2

RF SHIELDING PARTITION / CEILING SCALE: 1 1/2" = 1'-0"





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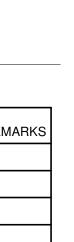
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ETAL NED

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OARD IUATING

TYPE 'J') DULED **R CHANNEL** LOOR



L WOOL ETAL DECK ETAL JED

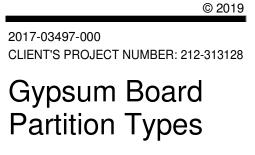
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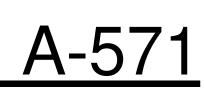
JATING YPE 'J') ULED

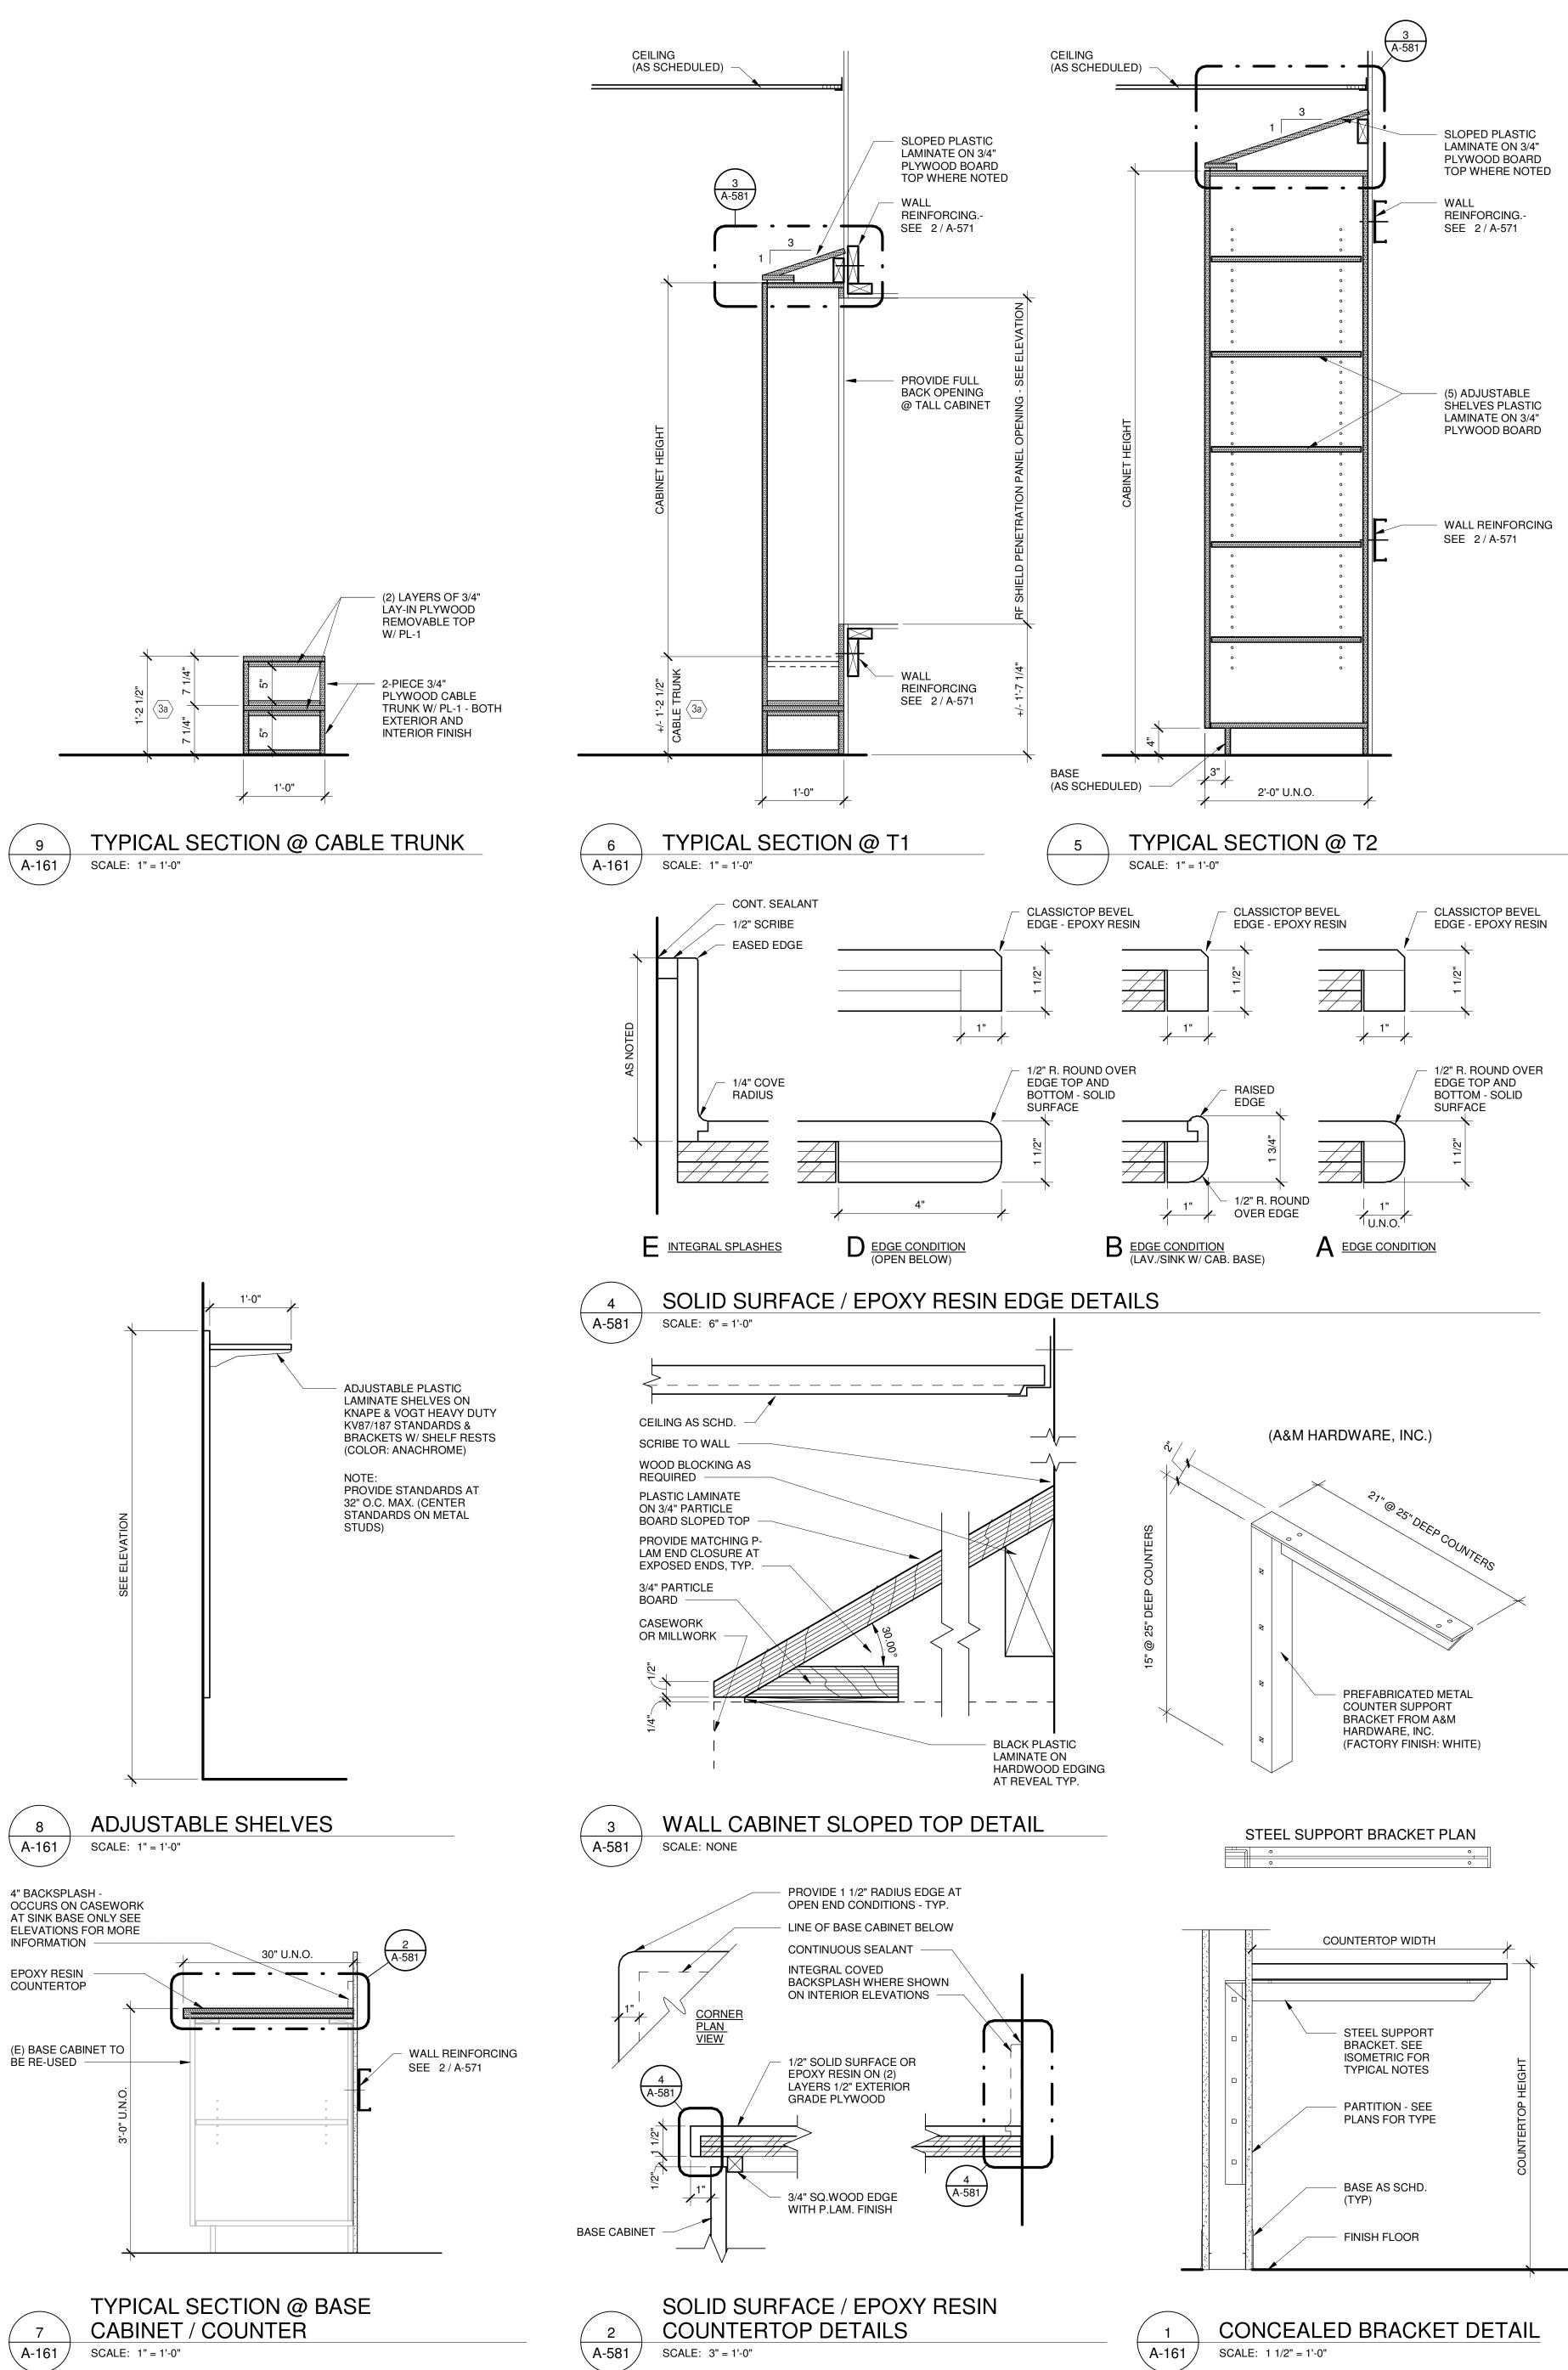
R CHANNEI .OOR

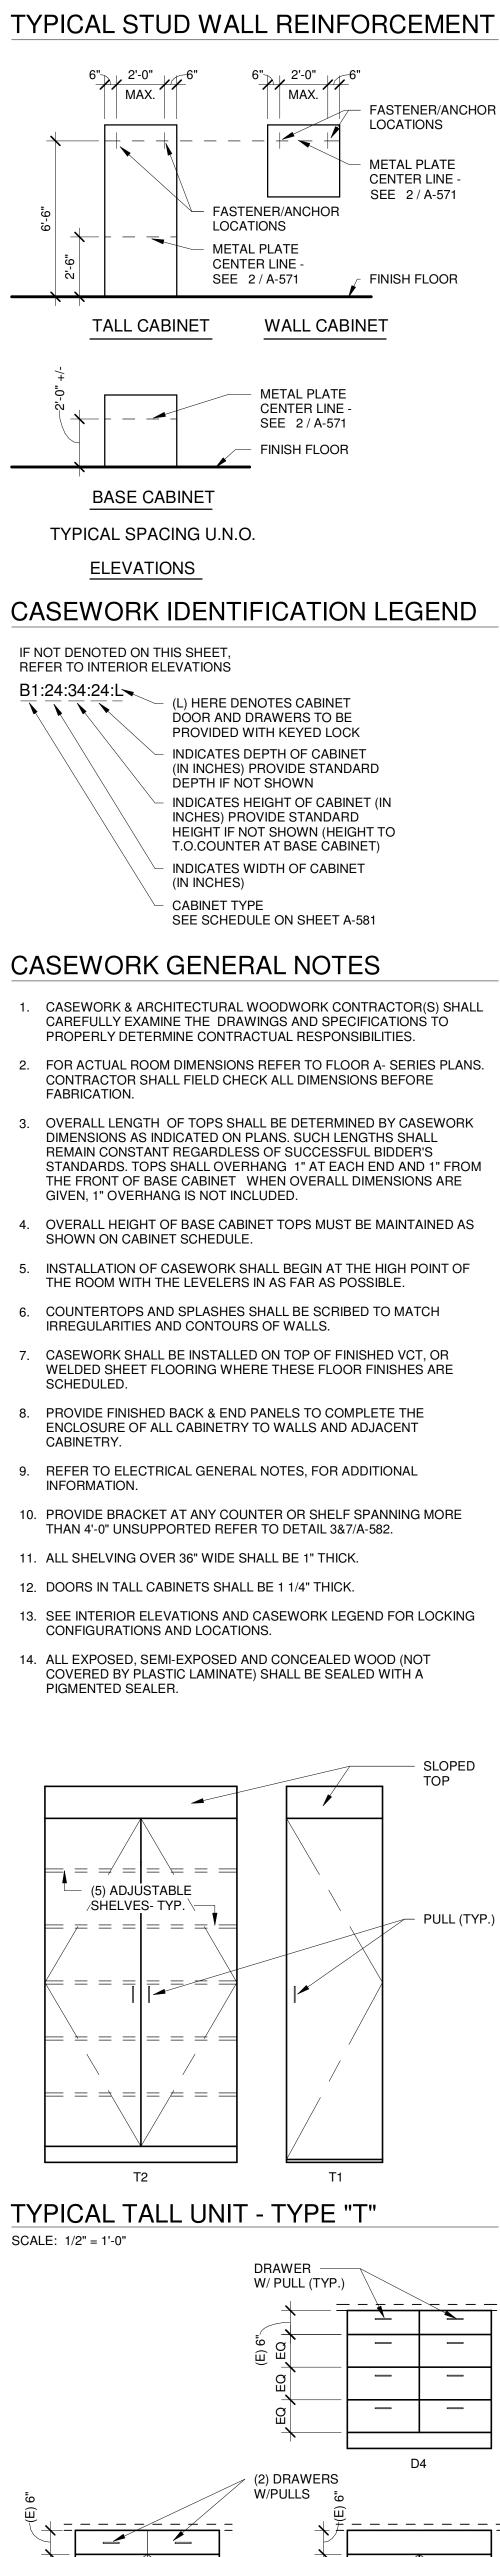


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EXISTING BASE UNIT - TYPE "B" AND "D"

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B4

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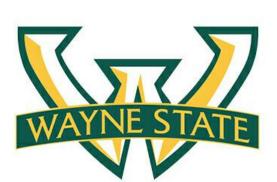
PULL

LOCK

WHERE

INDICATED ADJ.SHELF (TYPICAL)

(TYPICAL)



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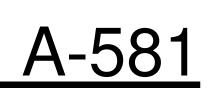
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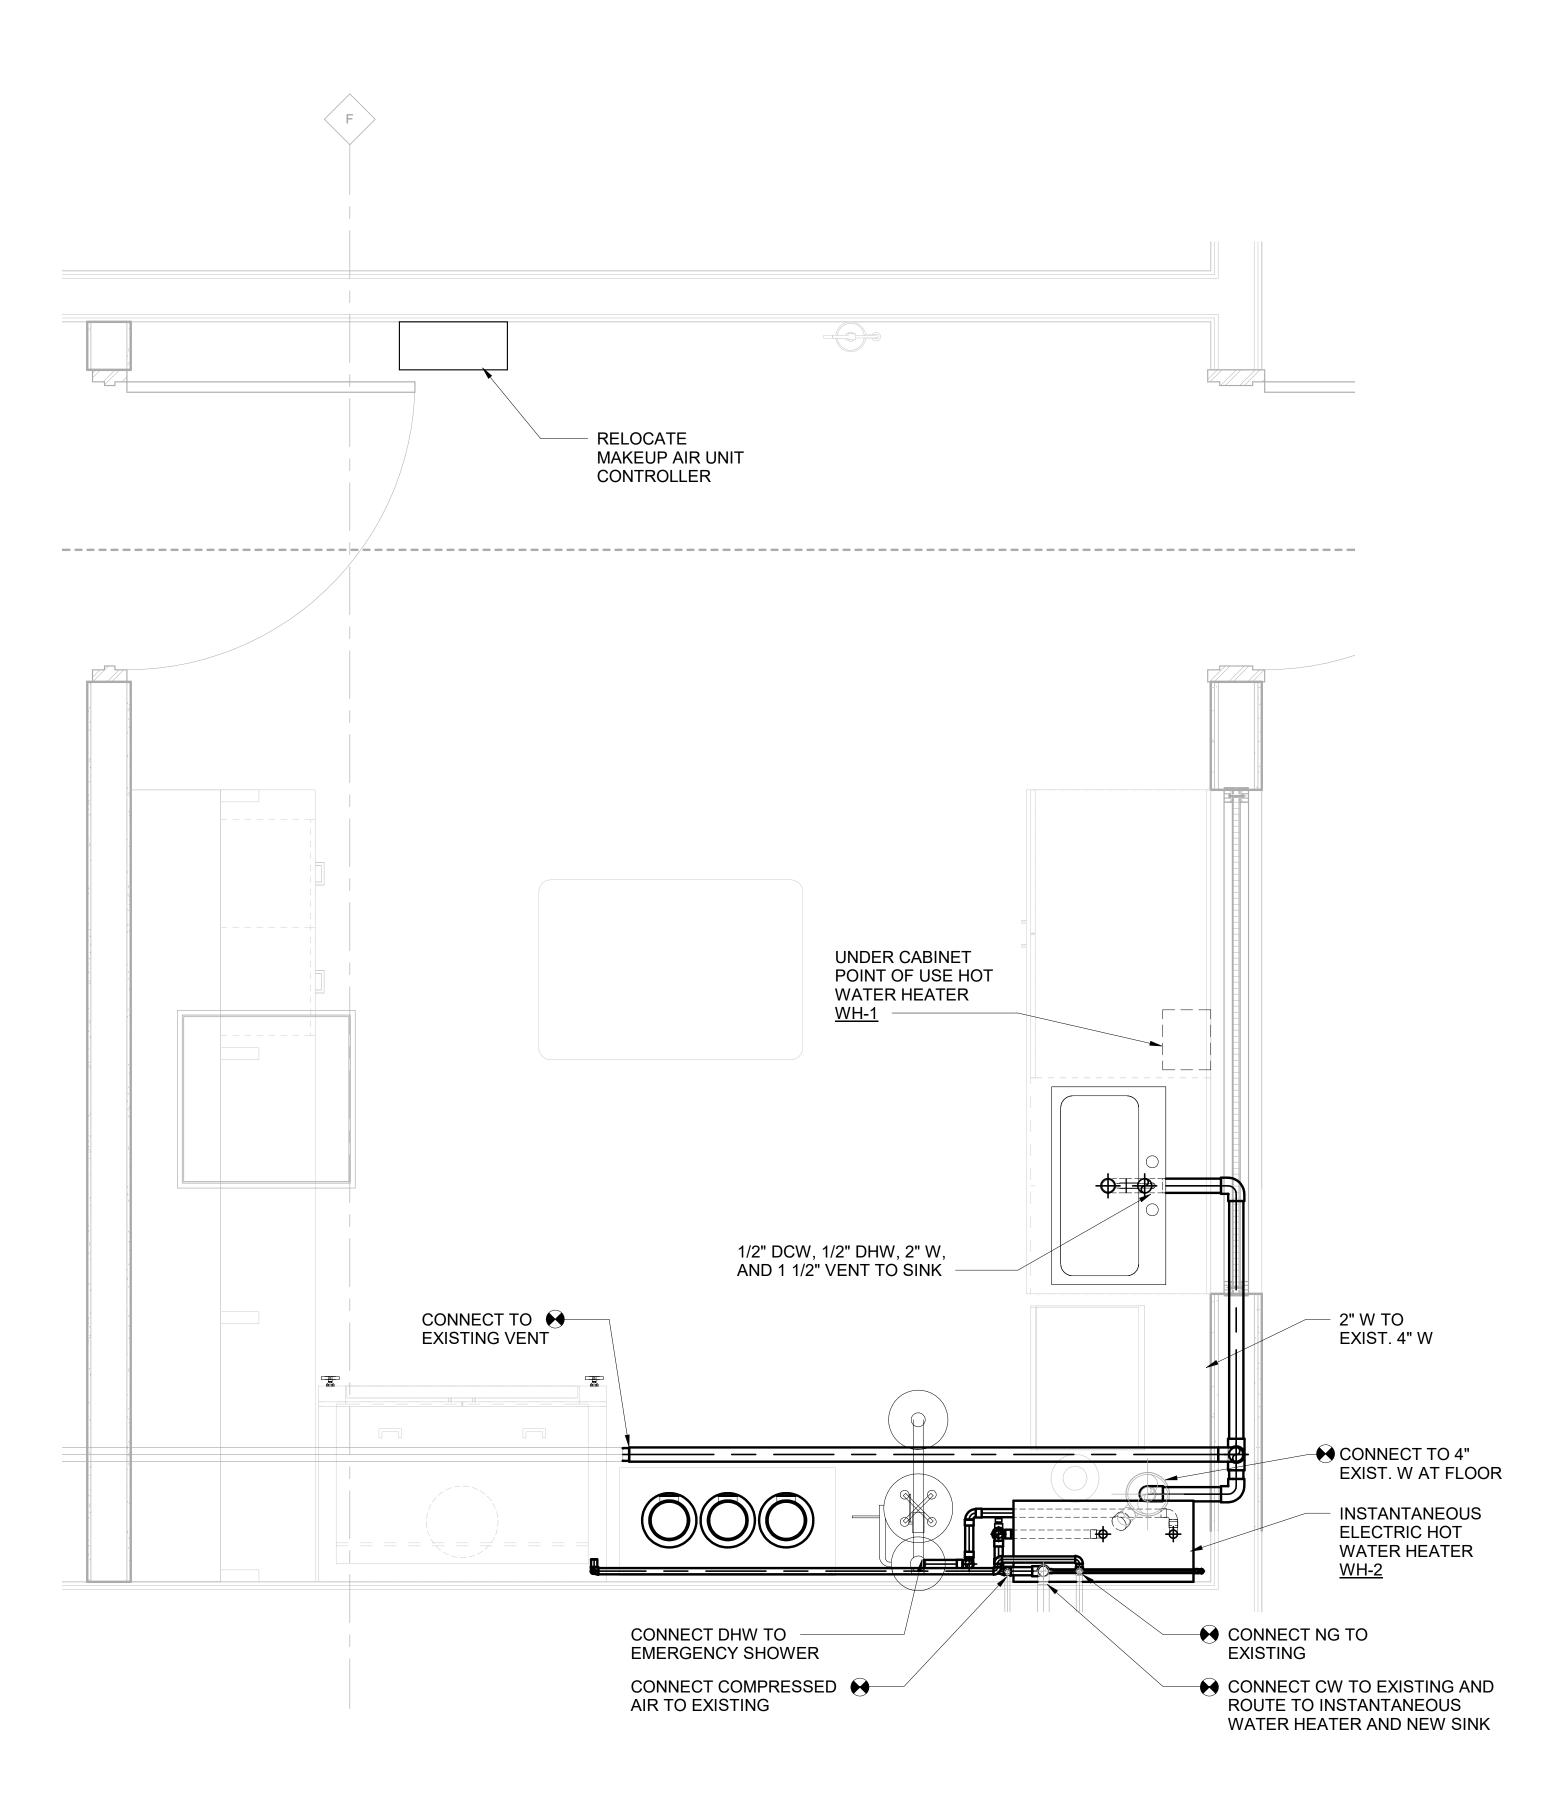
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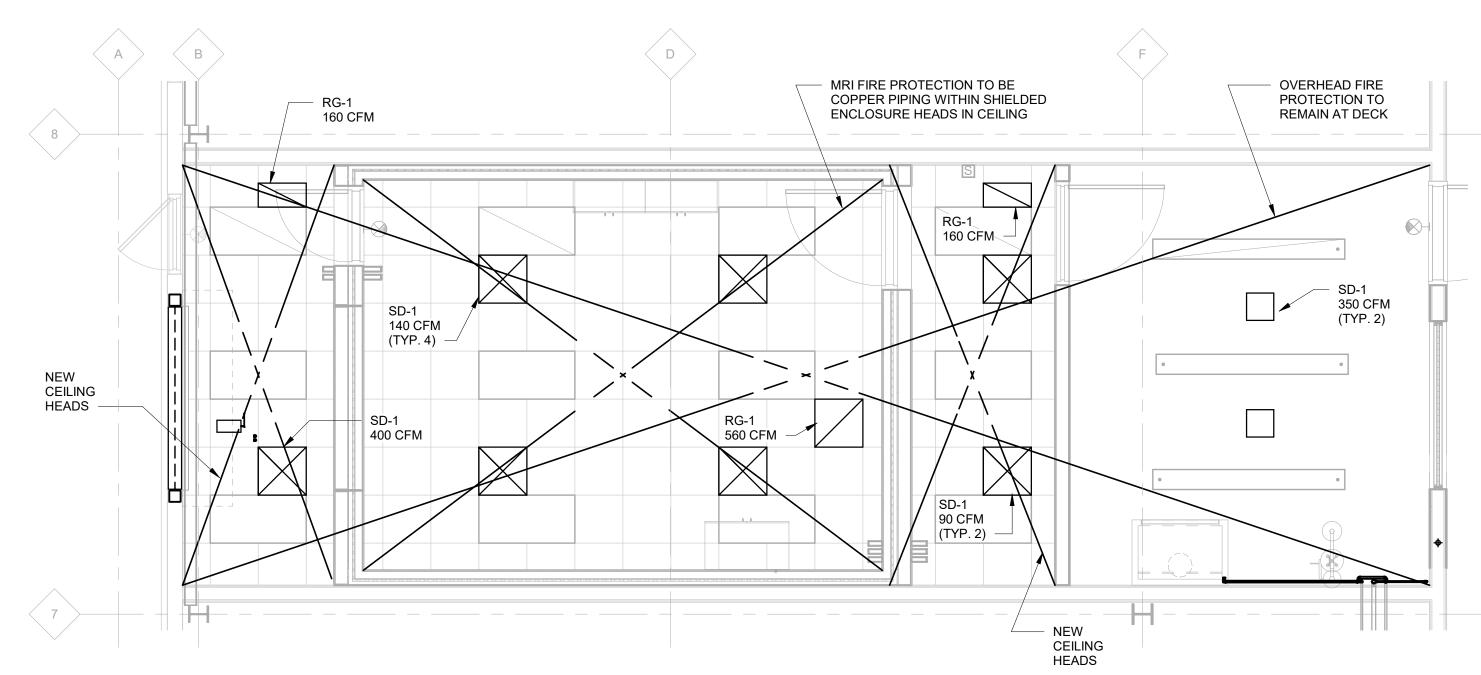
SB4

© 2019 2017-03497-000 CLIENT'S PROJECT NUMBER: 212-313128 Casework/Millwork Details

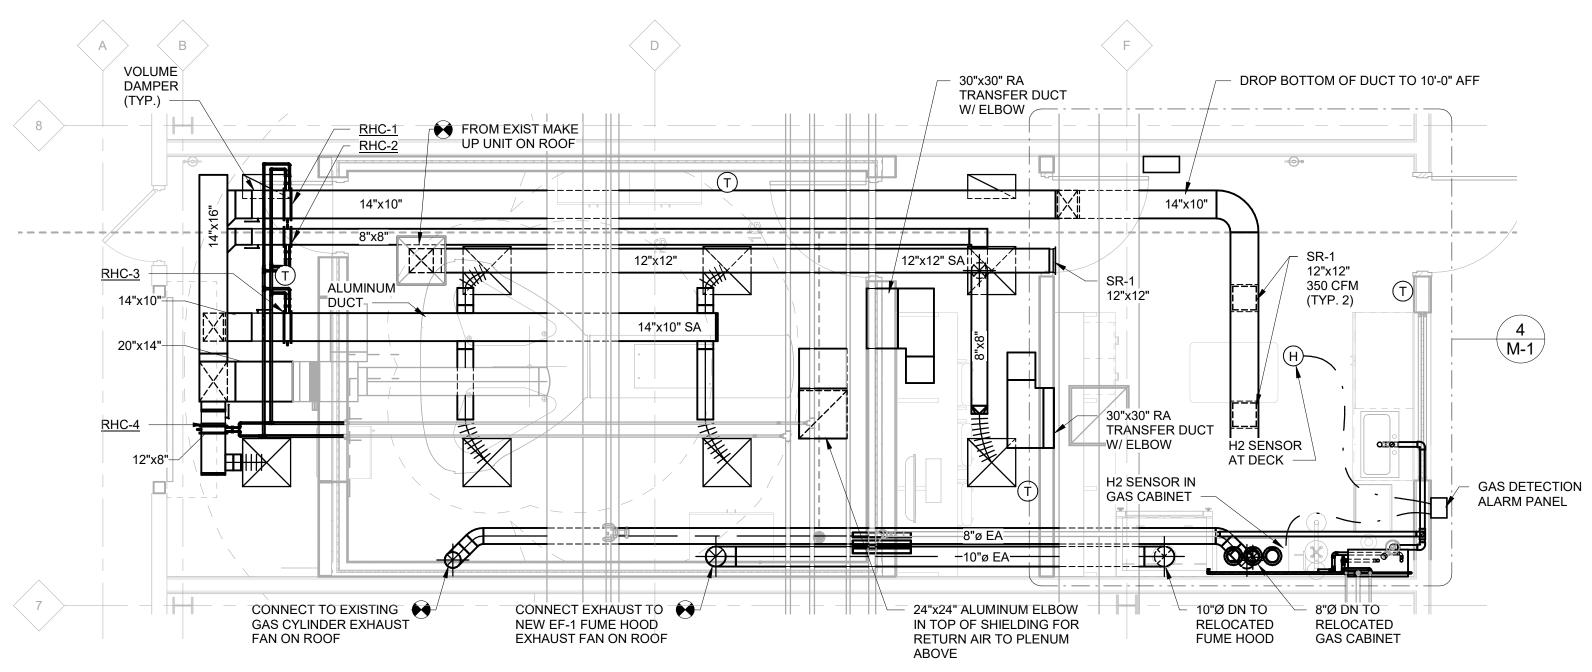




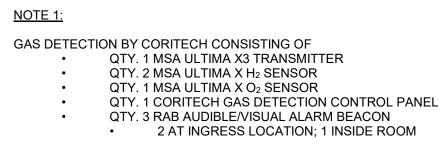
CHEMISTRY ENLARGED PLUMBING PLAN SCALE: 3/4" = 1'-0"

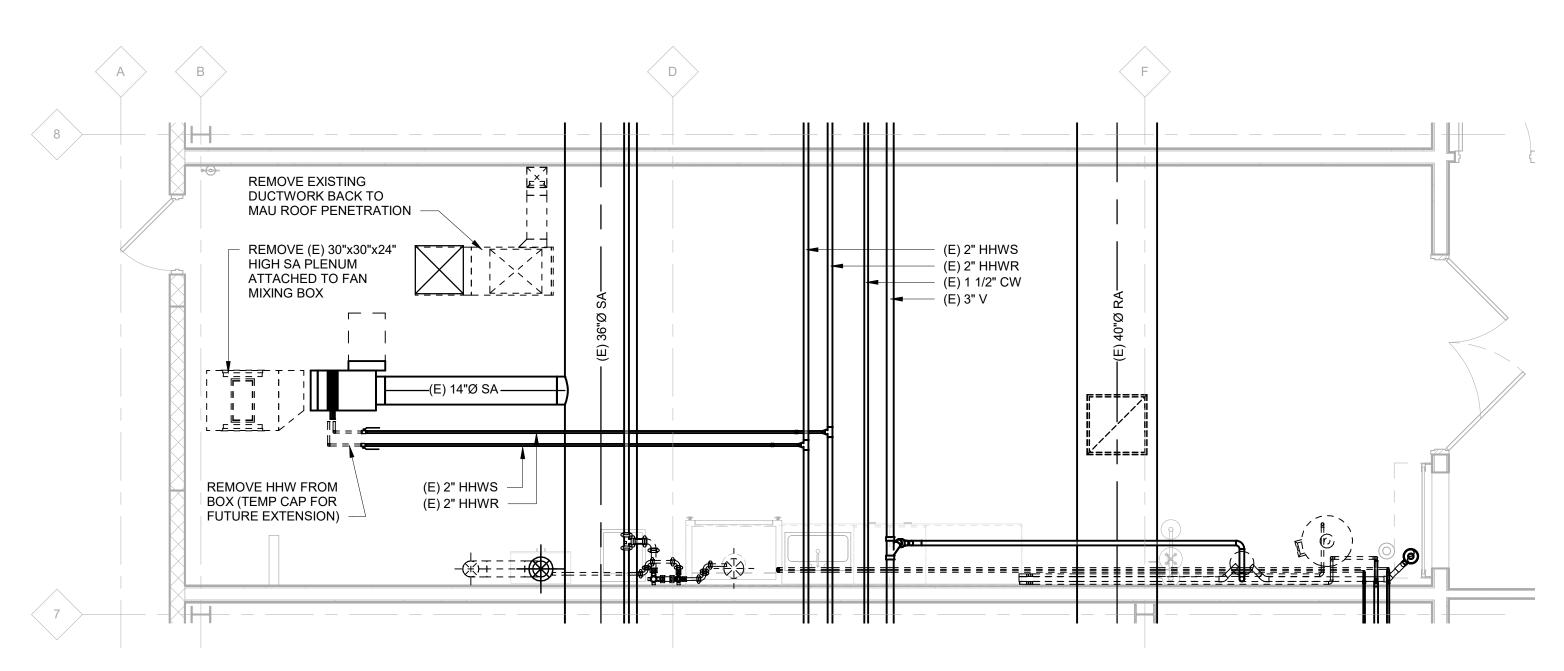


FIRST FLOOR REFLECTED CEILING PLAN/FIRE PROTECTION SCALE: 1/4" = 1'-0"



FIRST FLOOR COMBINED NEW WORK PLAN SCALE: 1/4" = 1'-0"





FIRST FLOOR COMBINED DEMO PLAN SCALE: 1/4" = 1'-0"

<u>NOTE 2:</u> REPLACE BELT ON GAS CABINET EXHAUST FAN

<u>NOTE 3:</u> PERFORM WINTER HEATING VERIFICATION OF EXISTING MAKE UP AIR UNIT



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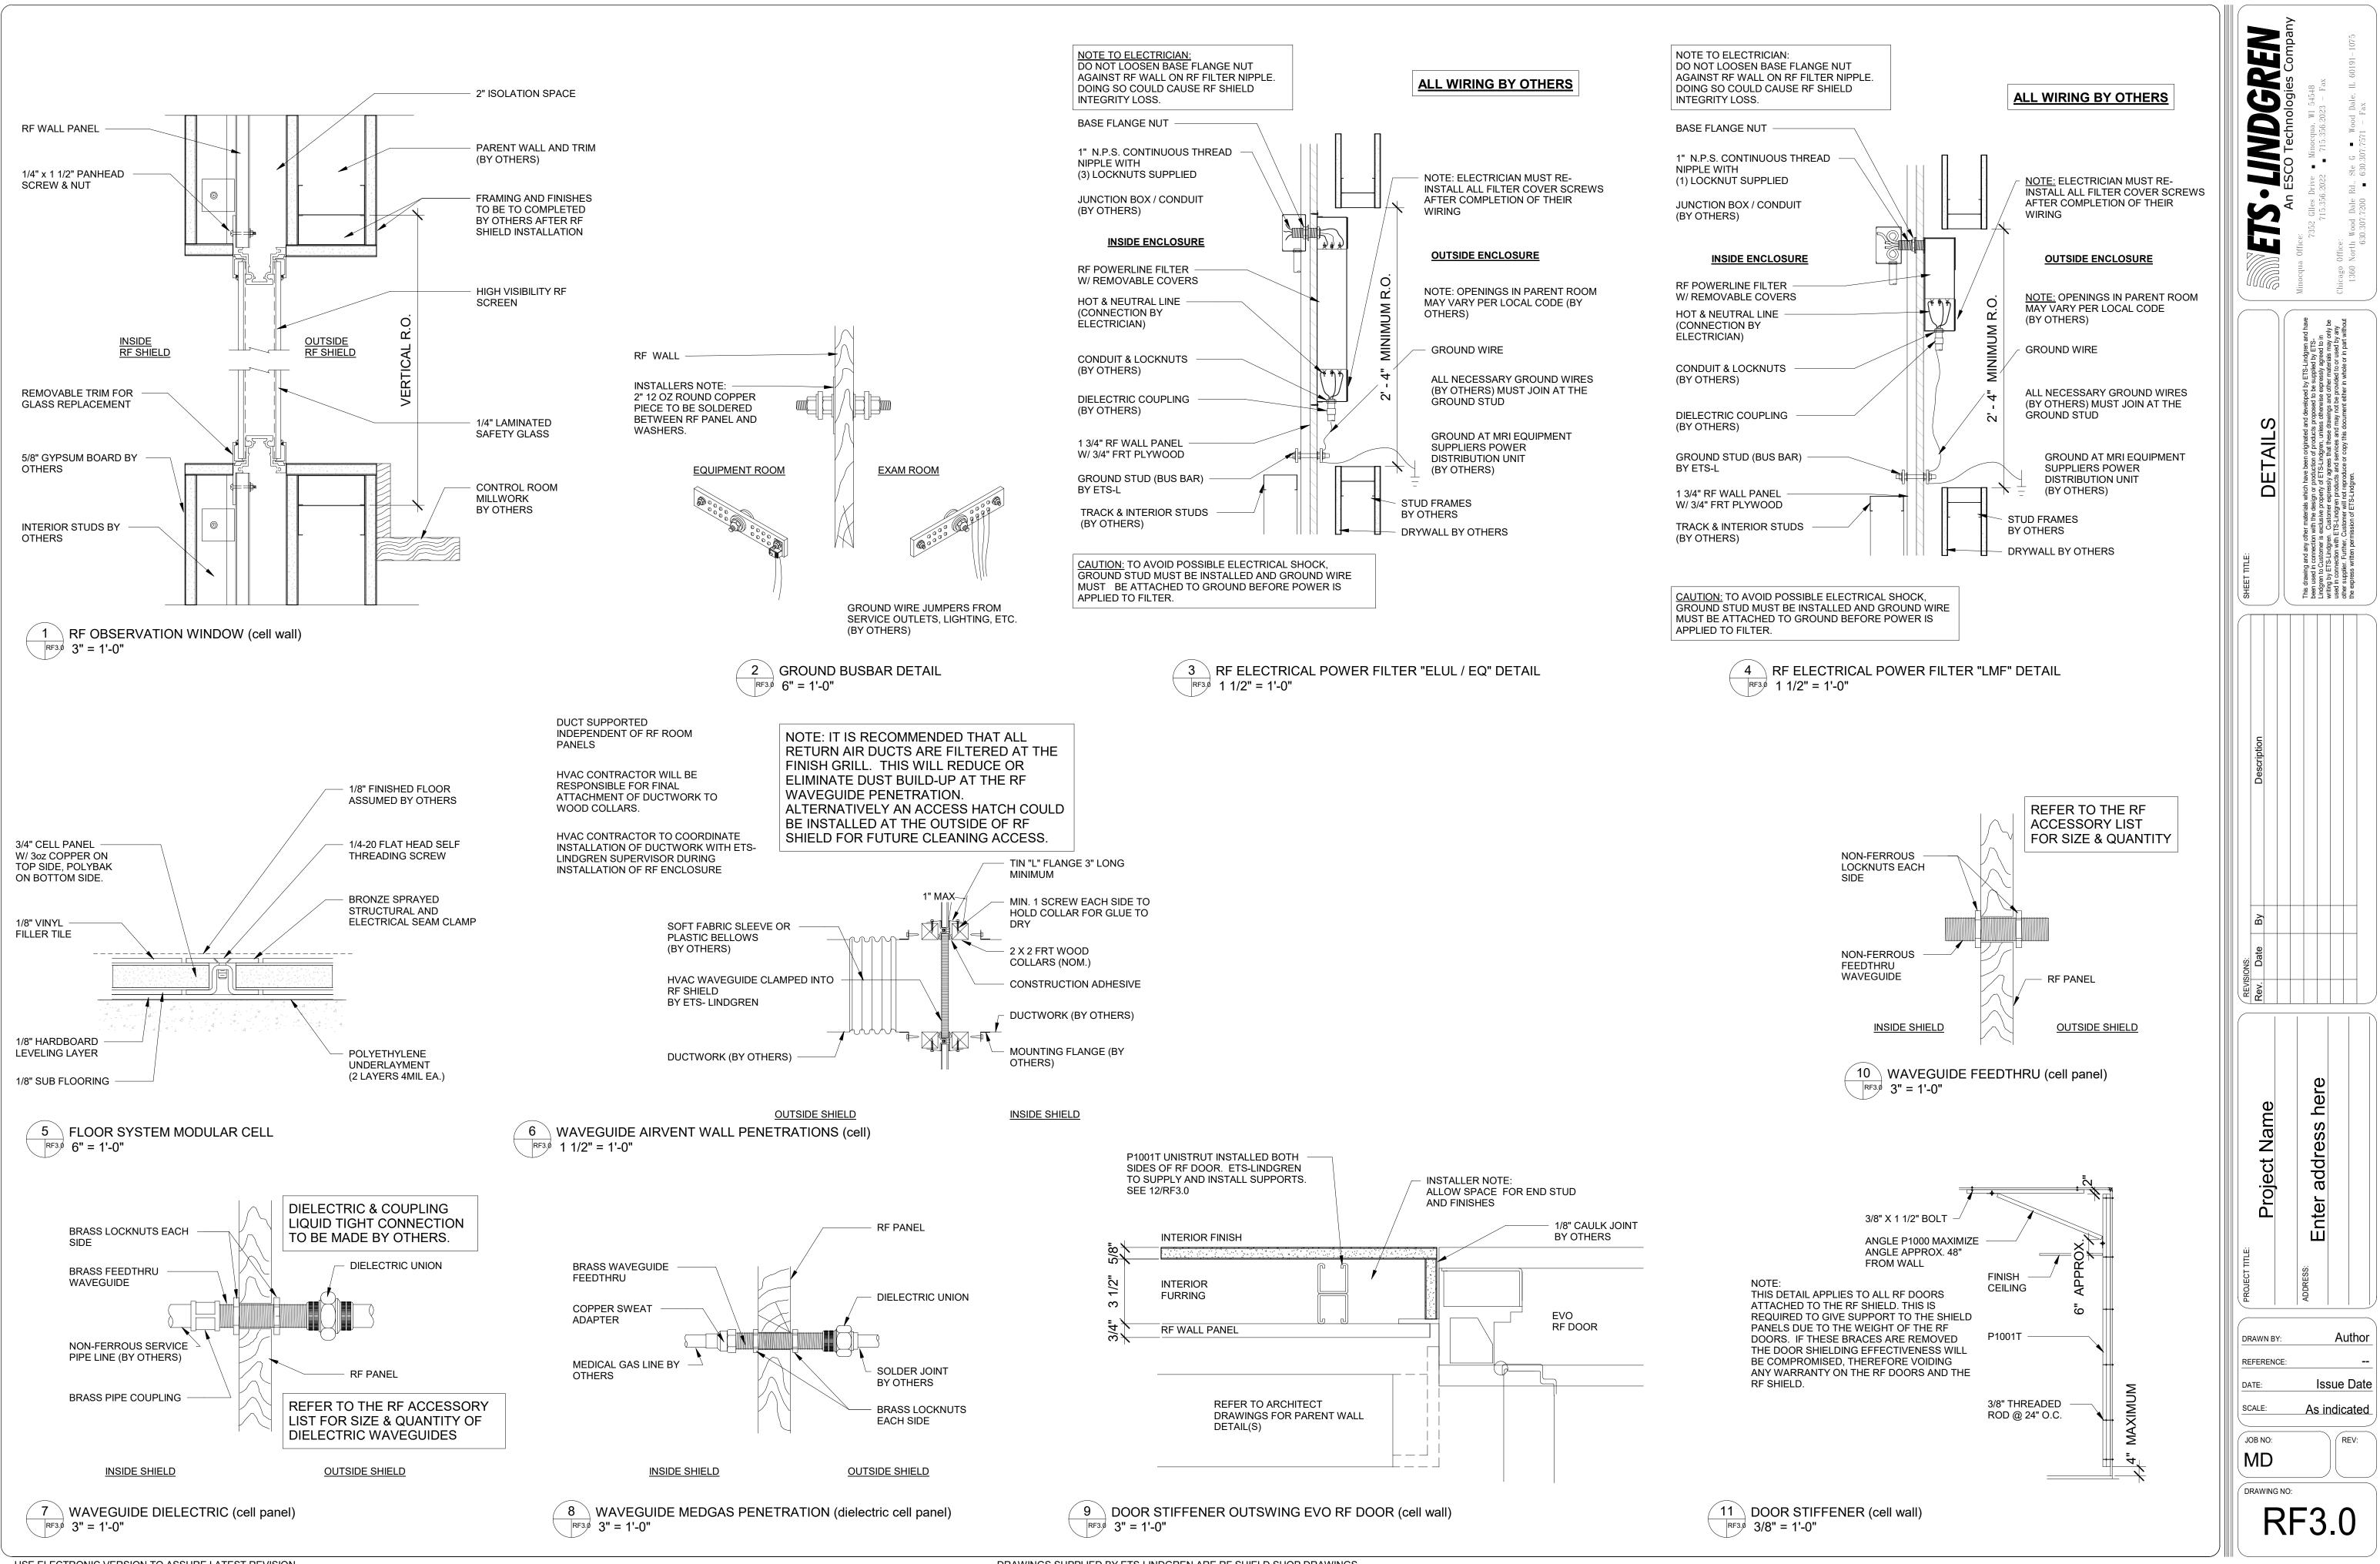
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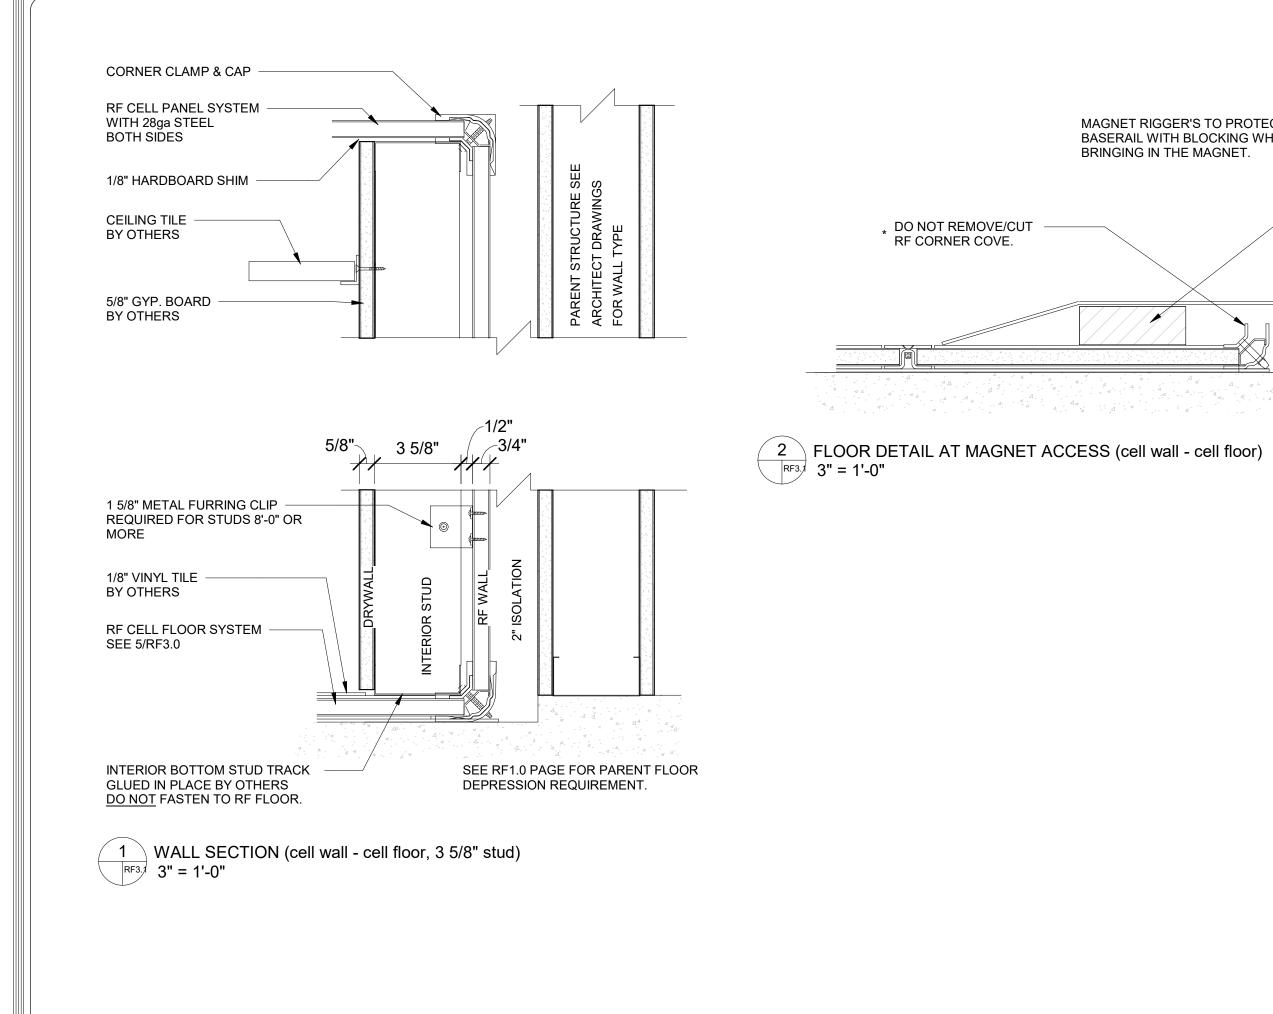
461 Burroughs St. Detroit, MI 48202

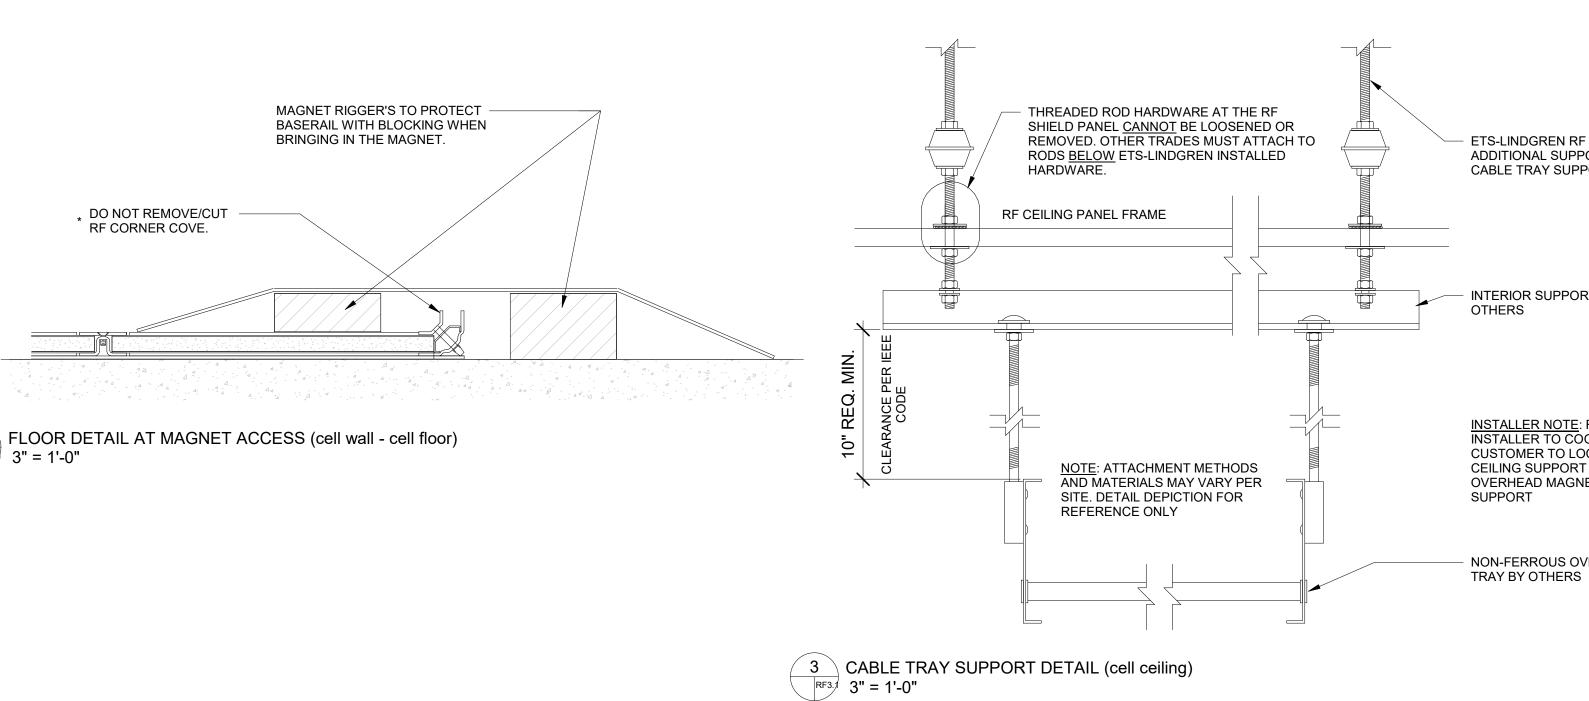
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USE ELECTRONIC VERSION TO ASSURE LATEST REVISION





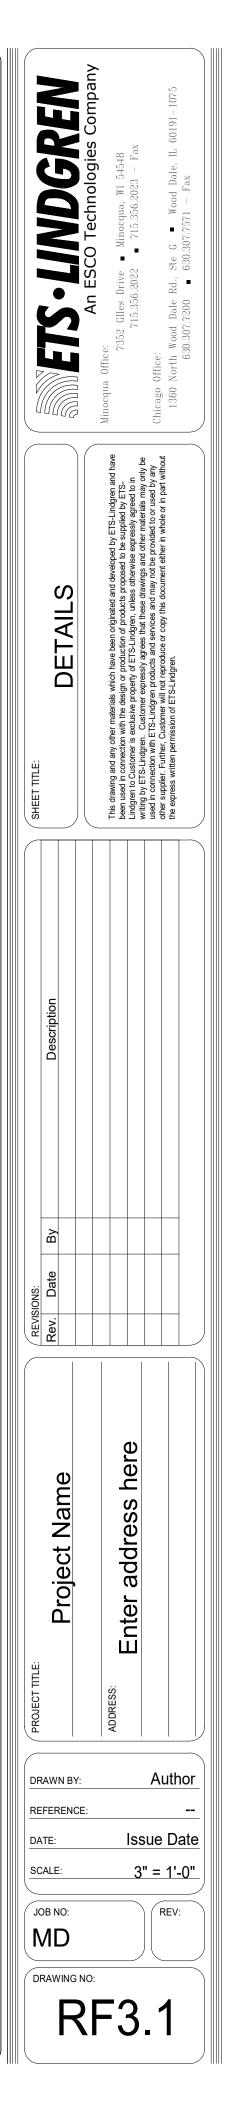
- ETS-LINDGREN RF CEILING SUPPORT. NOTE: ADDITIONAL SUPPORTS REQUIRED FOR CABLE TRAY SUPPORT. -FIELD LOCATE-

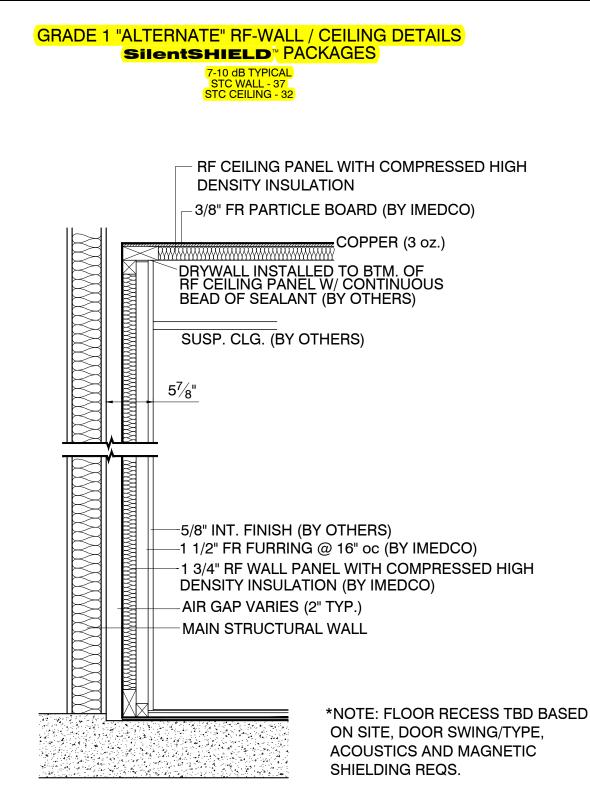
INTERIOR SUPPORT PIECES BY

INSTALLER NOTE: RF SHIELD CUSTOMER TO LOCATE ADDITIONAL CEILING SUPPORT DROPS FOR OVERHEAD MAGNET CABLE TRAY

NON-FERROUS OVERHEAD CABLE

IMPORTANT: ALL OVERHEAD SUPPORTS WILL HAVE TO BE CONNECTED DIRECTLY TO THE THREADED ROD RF SUPPORTS AND/OR ANY ADDITIONAL SUPPORTS REQUIRED MUST BE LAID-OUT AT TIME OF RF INSTALL SO ETS-LINDGREN PERSONEL CAN INSTALL AND RF SEAL THE PENETRATION. <u>DO NOT PENETRATE THE RF</u> SHIELD WITHOUT PRIOR APPROVAL FROM ETS-LINDGREN

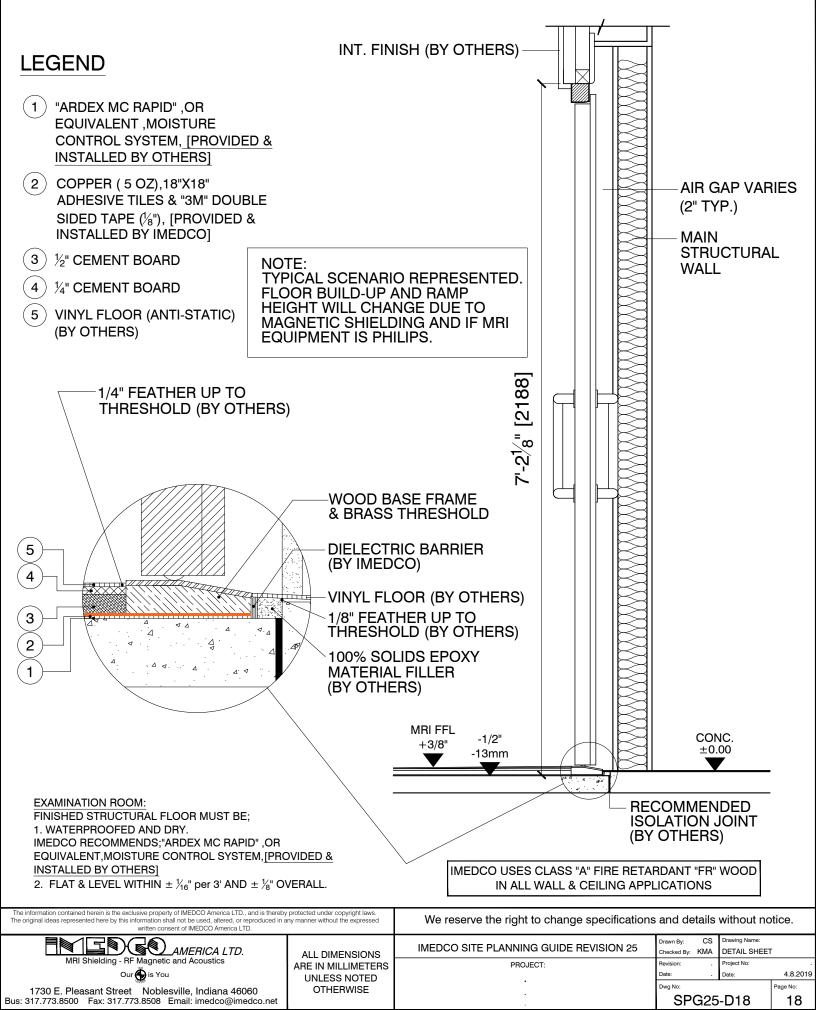




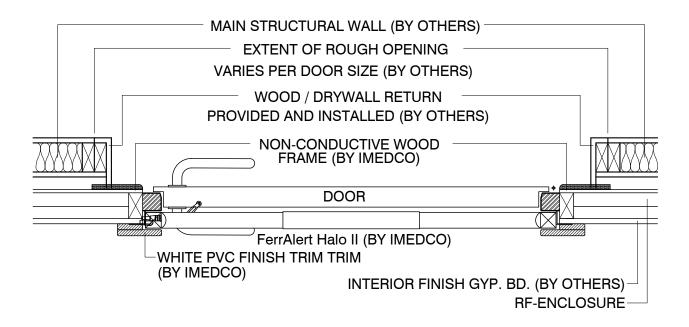
IMEDCO USES CLASS "A" FIRE RETARDANT "FR" COATED OR IMPREGNATED WOOD IN ALL WALL & CEILING APPLICATIONS.

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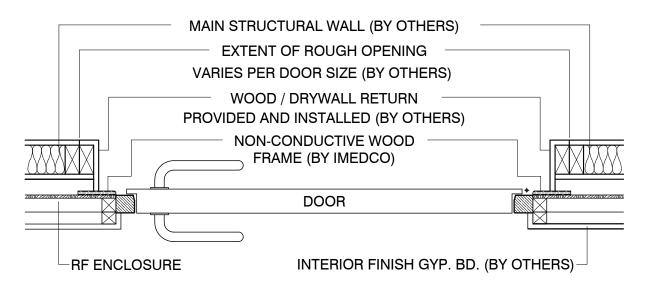
COPPER RF ENCLOSURE: Floor & SilentSHIELD Door (Outswing) w/ Recess



Copper SilentSHIELD[™] Outswing Door w/ FerrAlert Halo II Detector

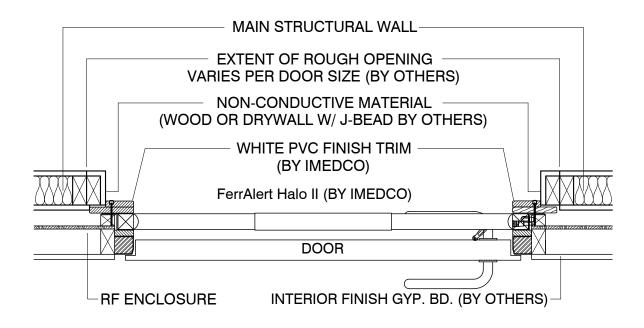


Copper SilentSHIELD[™] Outswing door

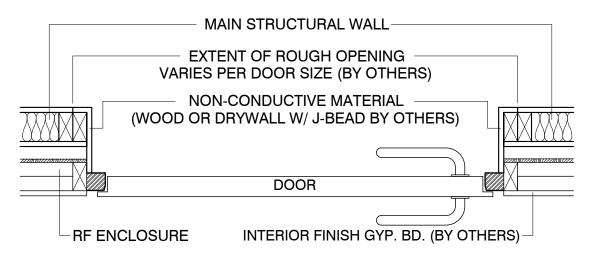


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Copper SilentSHIELD[™] Inswing Door w/ FerrAlert Halo II Detector



Copper SilentSHIELD[™] Inswing door



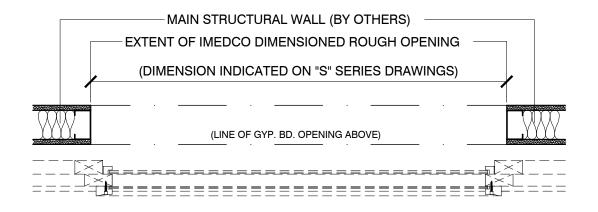
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WINDOW FINISH DETAILS

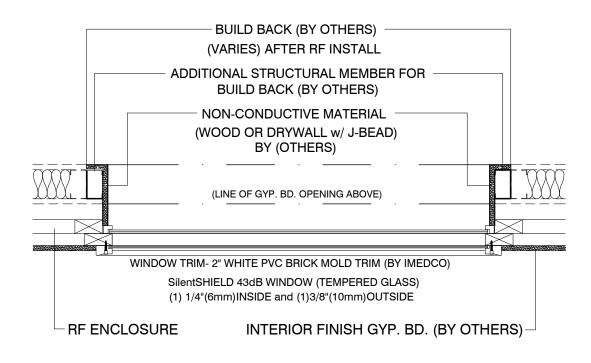
TYPICAL SILENTSHIELD[®] 43dB Technician RF Window Detail

NOTE: LARGER WINDOWS WILL REQUIRE A MULLION FOR SUPPORT.

* BEFORE RF ENCLOSURE INSTALLATION *

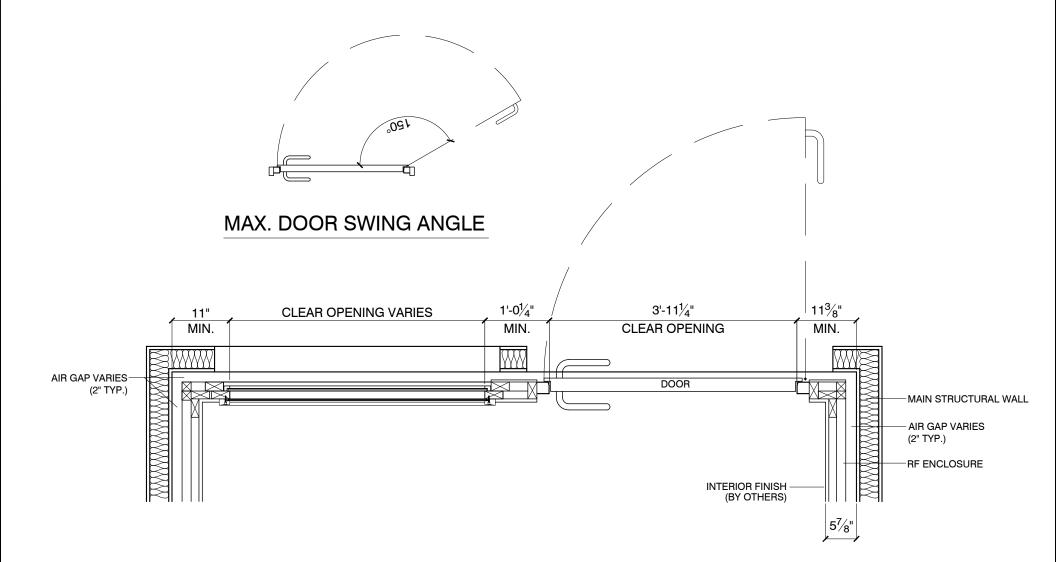


* AFTER PHASE 1 INSTALLATION OF RF ENCLOSURE *



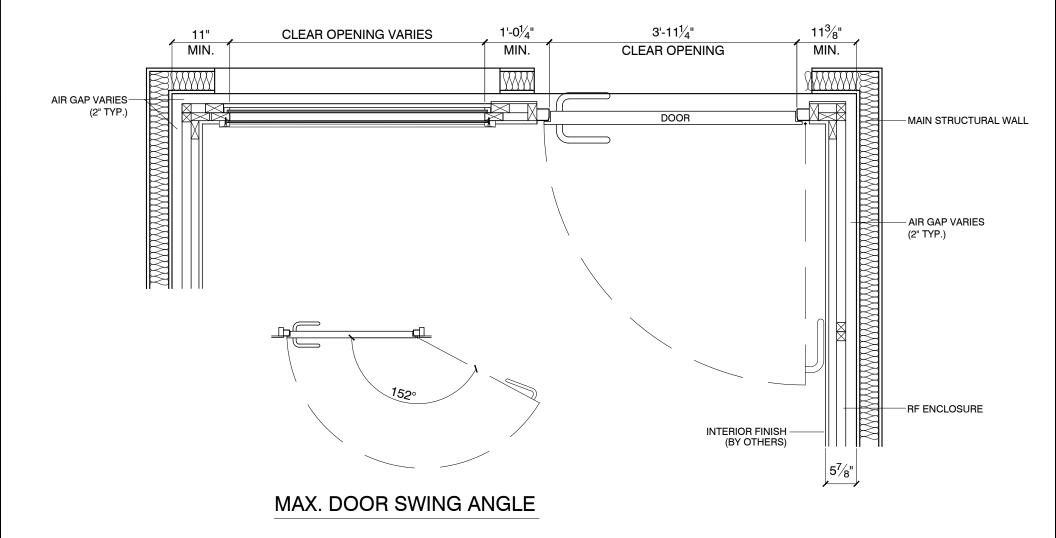
*CUSTOM SOLUTIONS AVAILABLE FOR MATCHING STOREFRONT WINDOWS IN THE MRI ROOM.

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| | | | SPG25 | -D35 | 35 |

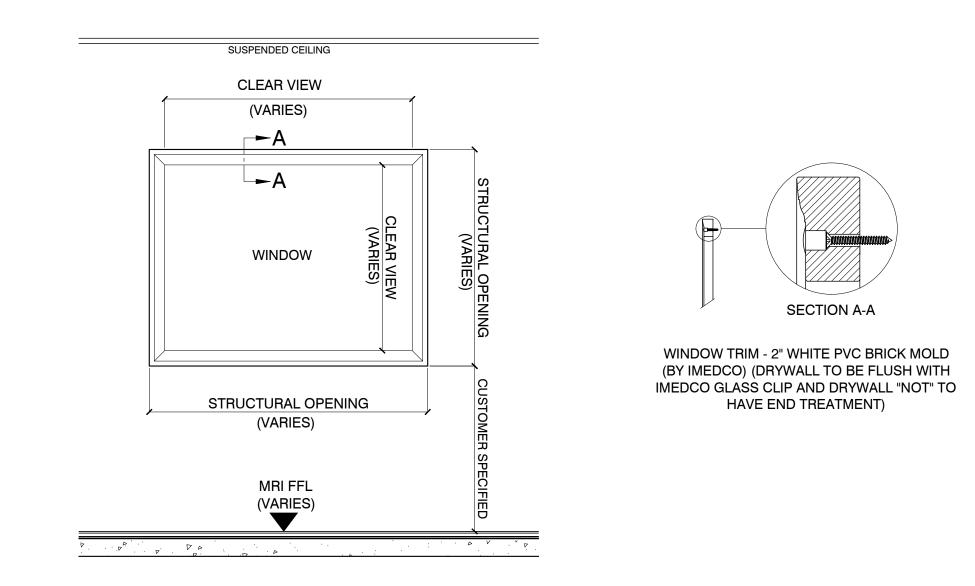
COPPER RF ENCLOSURE: Inswing SilentSHIELD[™] Door and Window Detail



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COPPER RF ENCLOSURE: Window Elevation Detail

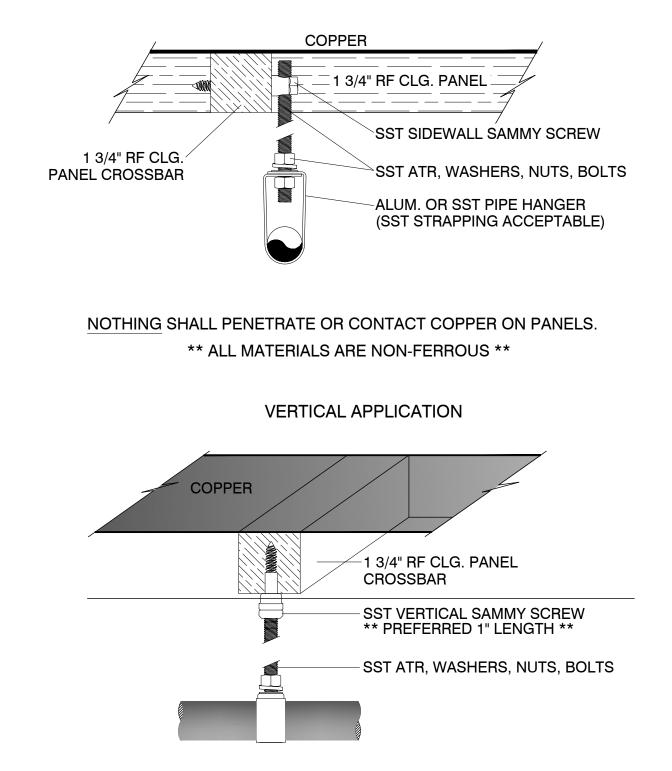
RF ENCLOSURE



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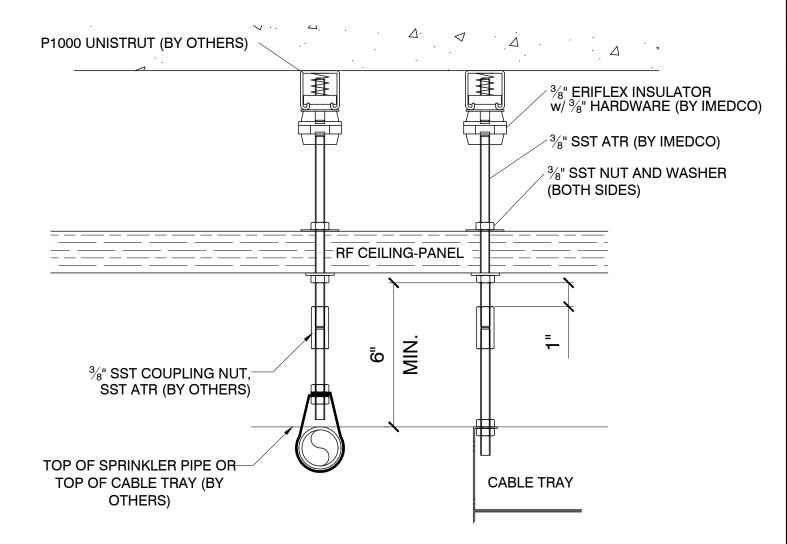
IMEDCO PREFERRED RF CEILING ATTACHMENTS ** PLEASE CONSULT IMEDCO PM FOR OTHER ACCEPTABLE METHODS **

HORIZONTAL APPLICATION



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IMEDCO PREFERRED ATTACHMENT TO ISOLATOR ** PLEASE CONSULT IMEDCO PM FOR OTHER ACCEPTABLE METHODS **



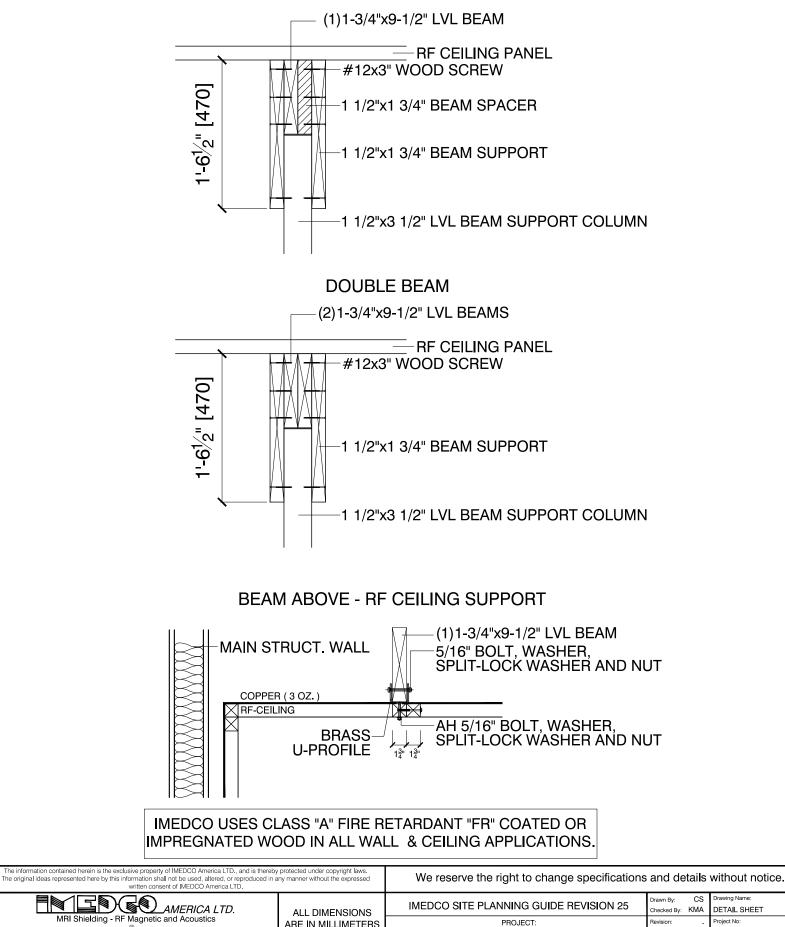
NOTE:

IMEDCO HAS NOT EVALUATED THE STRUCTURAL CAPACITY OF THE ATR SYSTEM USED TO SUPPORT AND BRACE THE RF-ENCLOSURE CEILING SYSTEM. RF-PANELS HAVE BEEN DESIGNED TO MAINTAIN STRUCTURAL INTEGRITY WITHOUT REGARD TO THIRD PARTY ITEMS SUPPORTED FROM THE ATR SYSTEM.

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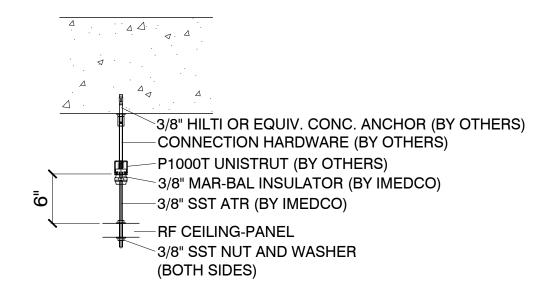
SELF-SUPPORT WOOD BEAM DETAILS

SINGLE BEAM



Drawing Nam CS Drawn By: DETAIL SHEET Checked By KMA MRI Shielding - RF Magnetic and Acoustics Project No PROJECT: ARE IN MILLIMETERS Our 💮 is You 4.8.2019 Date UNLESS NOTED 1730 E. Pleasant Street Noblesville, Indiana 46060 Bus: 317.773.8500 Fax: 317.773.8508 Email: imedco@imedco.net OTHERWISE Dwg No: Page No SPG25-D43 43

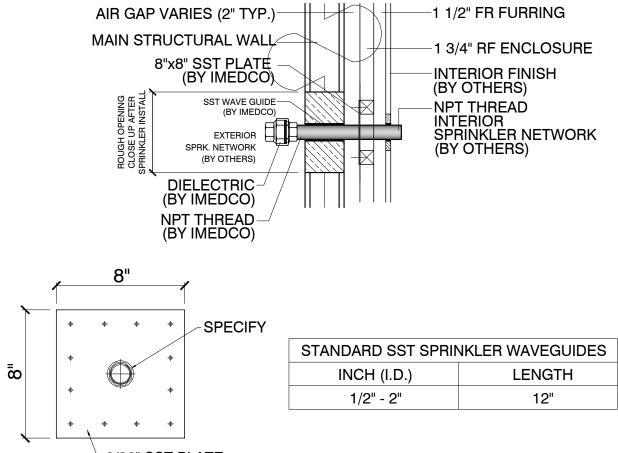
ANCHOR DETAIL - UNISTRUT TO RF CEILING



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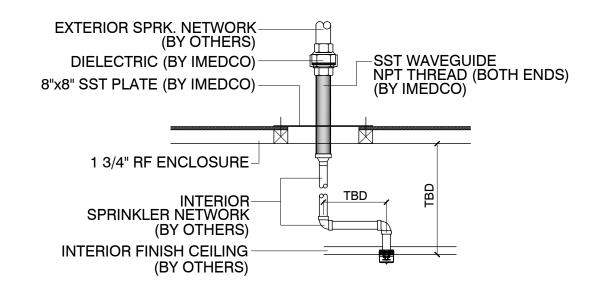
SPRINKLER WAVEGUIDE PENETRATIONS

DIELECTRIC SPRINKLER THRU WALL



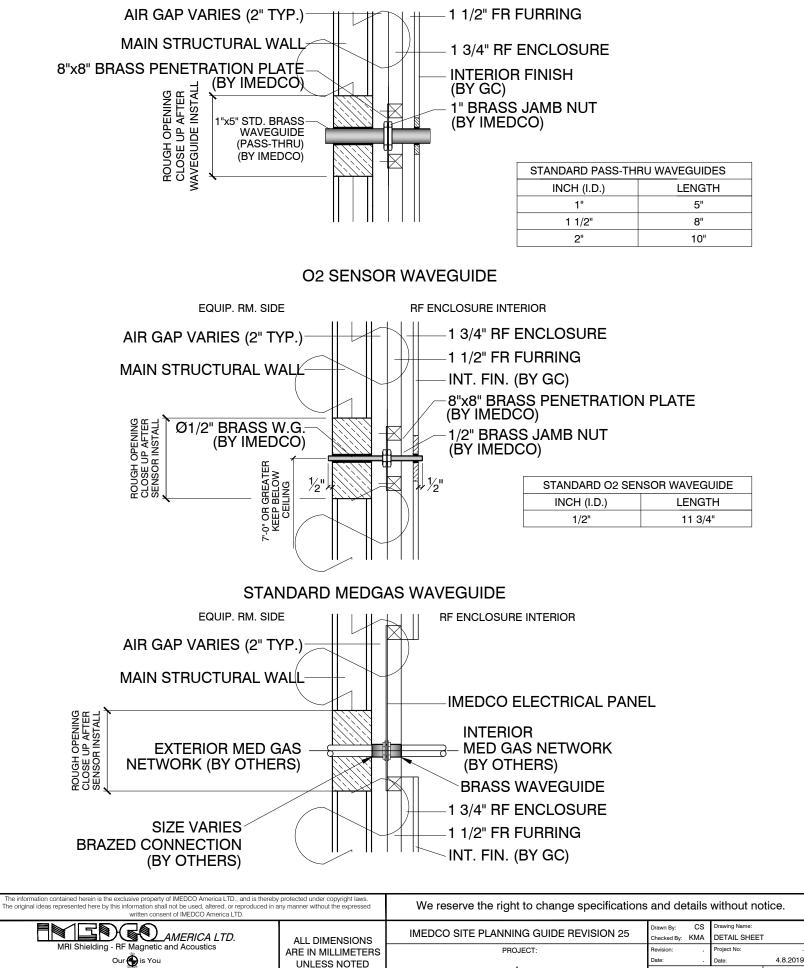
3/32" SST PLATE

DIELECTRIC SPRINKLER THRU CEILING



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STANDARD PASS-THRU WAVEGUIDE



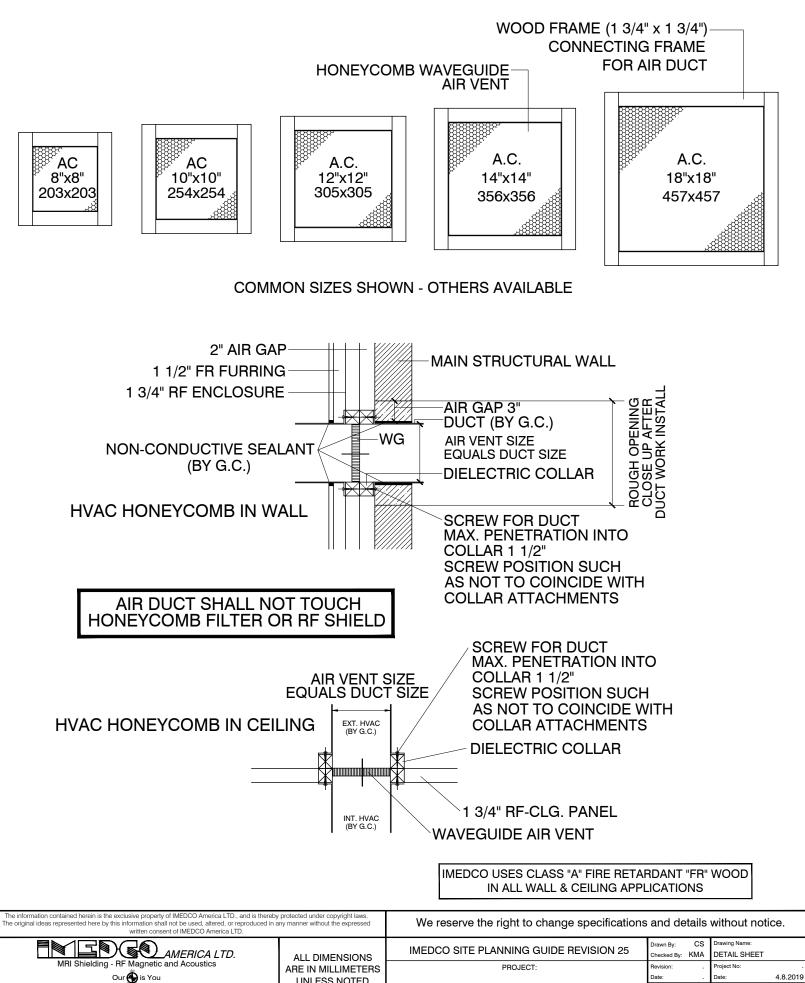
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Page No: 49

SPG25-D49

HVAC HONEYCOMB DETAILS



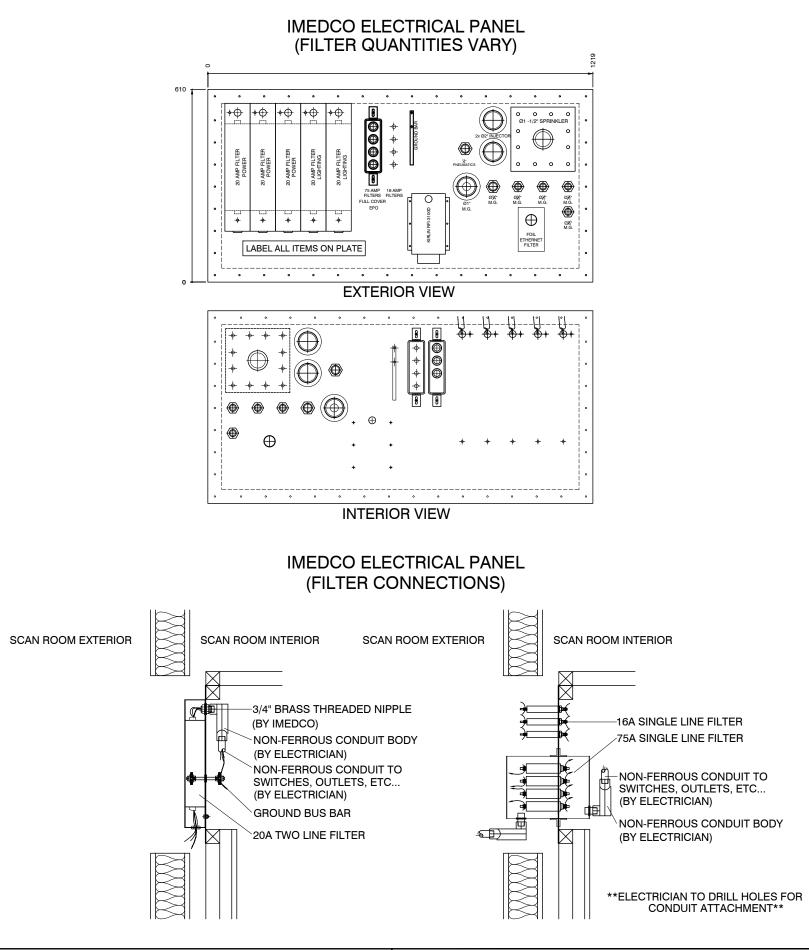
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