



A05-01 SCALE: 1 1/2" = 1'-0"

	DOOR & FRAME SCHEDULE										
PARAMETERS						OPEN	IING PARAN	<b>IETERS</b>			
-	MATL	GLASS TYPE	FINISH	COLOR	Opening FRR	HDWR SET	ELEC	ACCESS CONTROL	SIGNAGE	WALL WIDTH	COMMENTS
	HM WELD	GL-1	PTD	PT-2	45	1		Yes	NAME, NUMBER	0' - 6 1/8"	
	HM WELD	GL-1	PTD	PT-2	45	1		Yes	NAME, NUMBER	0' - 6 1/8"	
	HM WELD	GL-1	PTD	PT-2	45	2		Yes	NAME, NUMBER	0' - 6 1/8"	

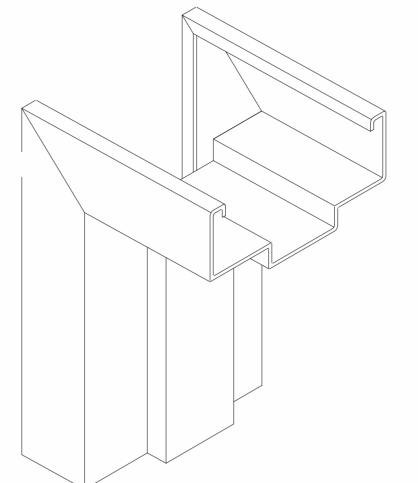

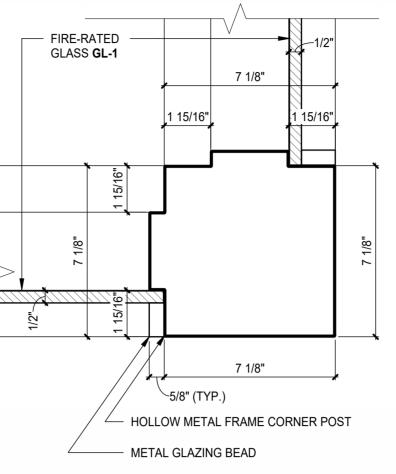

## **GENERAL NOTES - DOORS**

A. ALL GLASS IN FIRE-RATED FRAMES SHALL BE FIRE GLASS. B. COORDINATE DOOR HEAD HEIGHT WITH DOOR MANUFACTURER AND DOOR SILL DETAILS. C. REFER TO FINISH SCHEDULES FOR INTERIOR DOOR PAINT OR FINISH COLORS.


### HARDWARE SCHEDULE

FOR HARDWARE SET #1 & #2, REFER TO SPECIFICATIONS SECTION 080671 DOOR HARDWARE SCHEDULE.

# RELOCATED KEYPAD AND CARD READER COORDINATE WITH AV/TECHNOLOGY & ELECTRICAL DRAWINGS

- SEAL BETWEEN DUCT AND SLEEVE 5/8" GLASS FIBRE IN 5/8" WIDE AND HIGH GAP DUCT SIZES VARY. FIELD VERIFY

**TYPICAL ACOUSTIC PARTITION PENETRATION DETAILS** 

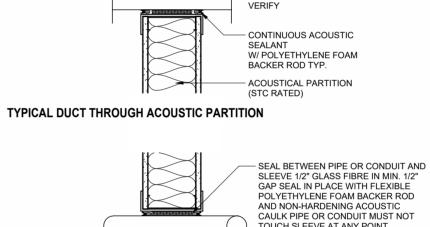


AND NON-HARDENING ACOUSTIC CAULK PIPE OR CONDUIT MUST NOT TOUCH SLEEVE AT ANY POINT PIPE OR CONDUIT SUSPENDED IN
 PLACE ON BOTH SIDES OF
 ACOUSTICAL WALL FIELD VERIFY.

- ACOUSTICAL PARTITION (STC RATED)


### **TYPICAL FIRE RATED PARTITION DETAILS**

TYPICAL PIPE OR CONDUIT THROUGH ACOUSTIC PARTITION

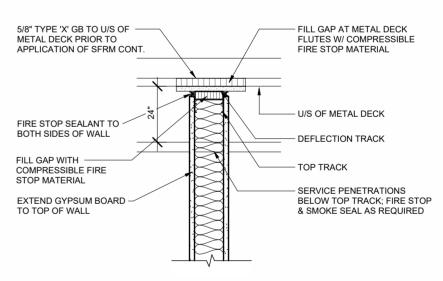

ALL GB FASTENED TO METAL DECK TO BE 5/8" TYPE 'X' UNLESS NOTED OTHERWISE. 1. ALL GB FASTENED TO METAL DECK TO BE INSTALLED PRIOR TO WALL ASSEMBLY PARTITION PERPENDICULAR TO FLUTES


# 5/8" TYPE 'X' GB TO U/S OF METAL DECK PRIOR TO APPLICATION OF SFRM CONT.

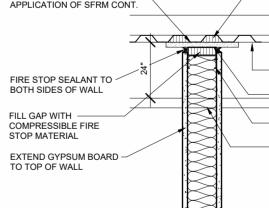

----- FILL GAP AT METAL DECK FLUTES W/ COMPRESSIBLE FIRE STOP MATERIAL

- DEFLECTION TRACK — TOP TRACK SERVICE PENETRATIONS
 BELOW TOP TRACK; FIRE STOP
 & SMOKE SEAL AS REQUIRED

ALL GB FASTENED TO METAL DECK TO BE 5/8" TYPE 'X' UNLESS NOTED OTHERWISE. 1. ALL GB FASTENED TO METAL DECK TO BE INSTALLED PRIOR TO WALL ASSEMBLY PARTITION PARALLEL TO FLUTES

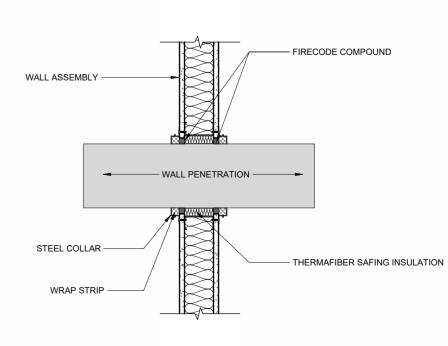

FIRE RATED WALL PENETRATION DETAIL

# **TYPICAL PARTITION DETAILS**

SCALE: 1" = 1'-0"

	2024-05-16   2024-06-06   2024-06-27	ssued for 50% ssued for 95% ssued for 100	SUED FOR CD Client Review CD Client Review CD Client Review and Building Permit endum 2	REV       1       2       3       4       5				
4								
3	STATE UNIVE	RSITY and the IORR to any p	red solely for the use of ere are no representatior party with whom NORR h	ns of any				
			d for construction purpo signed and dated by the					
	Project Compor Key Plan	nent						
	Consultants Architecture: Structural: Mechanical: Electrical: Interiors: AV/Technolog	NORR NORR NORR NORR NORR NORR Sy: HEAPY						
2	Seal(s)	Lice	MICHIGAN athe ond hse No. O * 072575 ARCHIGHT					
			R					
	Project Manage Valentino Manc Project Leader Chaderique Me Client WAYN	ini nard	Drawn Cem Muyan Checked Valentino Mancini	SITY				
1	Project WSU - COLLEGE OF NURSING RENOVATIONS DETROIT, MICHIGAN, US							
		TYPE	S & SCHED IYPES	ULE				
	Scale	As indic	ated					
	Project No. Drawing No.	ED2024						

# THIS DRAWING SET MUST COMPLY WITH WSU'S STANDARDS FOR TELECOMMUNICATIONS INFRASTRUCTURE: (HTTPS://TECH.WAYNE.EDU/DOCS/WSU-COMMUNICATIONS-STANDARDS.PDF).

# **TECHNOLOGY SCOPE MATRIX**

System	Furnished		Installed		Programming		Notes
	Owner	Contractor	Owner	Contractor	Owner	Contractor	
Data/Voice System							
Rough-In Boxes and Conduits		Х		X			
Pathway Hardware		Х		Х			
Cabling & Required Hardware		Х		Х			
Faceplates and Jacks		Х		X			
Patch Panels		Х		X			
Patch Cables		Х	Х				
Network Electronics - WSU Network	Х		Х		Х		
Wireless Network							
Rough-In Boxes and Conduits		Х		X			
Pathway Hardware		Х		X			
Cabling & Required Hardware		Х		Х			
Faceplates and Jacks		Х		Х			
Patch Panels		Х		Х			
Patch Cables - Device Side		Х		Х			
Patch Cables - Patch Panel Side		Х	Х				
Wireless Access Points	Х			Х	Х		
A/V System							
Rough-In Boxes and Conduits		Х		X			
Pathway Hardware		Х		Х			
Cabling & Required Hardware	Х		Х				
Faceplates and Jacks	Х		Х				
Display Monitors and Mounts	Х		Х		Х		
Audio Equipment	Х		Х		Х		
Non-Monitor Video Equipment	Х		Х		Х		
Network Electronics - Local AV Network	Х		Х		Х		
Access Control							
Rough-In Boxes and Conduits		Х		X			
Pathway Hardware		Х		Х			
Cabling & Required Hardware		X		X			
Endpoint Devices (Card Readers)	Х			X	Х		
Head-End Equipment (Cbord control boards, reader boards, enclosures)	Х			X	Х		
Video Surveillance							
Rough-In Boxes and Conduits		Х		Х			
Pathway Hardware		Х		Х			
Cabling & Required Hardware		Х		X			
Cameras & Mounting Hardware		X		X		Х	
Camera Licensing	Х		Х				

	INOLOGY SYMBOLS
AP	CEILING MOUNTED WIRELESS ACCESS POINT WITH DATA DROP ABOVE CEILING. PROVIDE 10' COIL IN DATA CABLE TO FACILITATE RELOCATION OF WAP. WAP PROVIDED BY OWNER, INSTALLED BY CONTRACTOR.
	WIREMOLD RACEWAY, AS NOTED ON PLANS.
ECH	NOLOGY SYMBOLS WITH ELEC. REQUIREMENTS
	CONDUIT SLEEVE / FIRE RATED SLEEVE ASSEMBLY THRU WALL (1-2" SLEEVE UNLESS NOTED OTHERWISE) PER DIV 26.
×	WALL MOUNTED DATA OUTLET (18" MH UNLESS NOTED OTHERWISE). BOX WITH CONDUIT(S) TO ABOVE CORRIDOR CEILING PER DIV 26. JACKS, FACEPLATE AND CABLING PER DIV 27. SUBSCRIPT "X" DESIGNATES QUANTITY OF DATA CABLES. REFER TO FACEPLATE DETAILS.
$\overset{\times}{\bigotimes}$	DATA OUTLET LOCATED ABOVE ACCESSIBLE CEILING. JACKS, PLENUM RATED SURFACE MOUNT BOX AND CABLING PER DIV 27. SUBSCRIPT "X" DESIGNATES QUANTITY OF DATA CABLES.
€x	WALL MOUNTED AV OUTLET. BOX WITH CONDUITS TO ABOVE ACCESSIBLE CEILING PER DIV 26. REFER TO FACEPLATE DETAILS. JACKS, FACEPLATE AND CABLING PER DIV 27. SUBSCRIPT "X" INDICATES ALTERNATE CONFIGURATION.
⟨≫ <sub>x</sub>	WALL MOUNTED AV OUTLET. BOX WITH CONDUIT PER DIV 26. REFER TO FACEPLATE DETAILS. JACKS, FACEPLATE AND CABLING PER DIV 27. SUBSCRIPT "X" INDICATES ALTERNATE CONFIGURATION.
(#	POKE-THRU PER DIV 26 SHOWN FOR REFERENCE, REFER TO OUTLET DETAILS.
V S	YMBOLS WITH ELECTRICAL REQUIREMENTS
AV	AV SYSTEM CONTROL INTERFACE. REFER TO SYSTEM DIAGRAMS. WHEN WALL MOUNTED PROVIDE BACKBOX (46" MH UNLES NOTED OTHERWISE) WITH 1" CONDUIT TO ABOVE ACCESSIBLE CEILING PER DIV 26. CONTROLLER WITH CABLING PER DIV 27.
	WALL MOUNTED TELECONFERENCE / AV SYSTEM CAMERA. REFER TO SYSTEM DIAGRAMS. BACKBOX WITH 1" CONDUIT TO ABOVE ACCESSIBLE CEILING, CAMERA AND CABLING. CEILING MOUNT ELECTRIC PROJECTION SCREEN. 1-GANG BOX WITH 1" CONDUIT TO ABOVE ACCESSIBLE CEILING, SCREEN
	SINGLE FACED WALL MOUNTED CLOCK. ANALOG CLOCK UNLESS SUBSCRIPT "LED" FOR LED DIGITAL CLOCK. 1-GANG BOX WITH 0.75" CONDUIT TO ABOVE ACCESSIBLE CEILING.
ν S	YMBOLS
42	FLAT PANEL DISPLAY WITH WALL MOUNTING HARDWARE AND SUPPORTING OUTLET(S) (84" MH UNLESS NOTED OTHERWISE). # INDICATES NOMINAL SCREEN DIAGONAL SIZE.
MC	CEILING MOUNTED MICROPHONE. REFER TO DETAILS.
$\overline{\bigcirc}$	CEILING MOUNTED PTZ CONFERENCING CAMERA. REFER TO DETAILS.
PR	CEILING MOUNTED PROJECTOR. REFER TO DETAILS.
PS	CEILING MOUNTED MANUAL PROJECTION SCREEN.
$\mathbb{W}$	INTERACTIVE WHITE BOARD.
-PS	WALL MOUNTED MANUAL PROJECTION SCREEN.
SF	CEILING MOUNTED SOUND FIELD SYSTEM SPEAKER.
(SR)	CEILING MOUNTED SOUND REINFORCEMENT SYSTEM SPEAKER.
ECL	IRITY SYMBOLS WITH ELECTRICAL REQUIREMENTS
CR	WALL MOUNTED PROXIMITY CARD READER (46" MH UNLESS NOTED OTHERWISE). 1-GANG BOX WITH CONDUIT TO COMMON SMS JUNCTION BOX ABOVE ACCESSIBLE CEILING PER DIV 26. CARD READER AND CABLING PER DIV 28. REFER TO SECURITY ROUGH-IN DETAILS.
EDC	ELECTRONIC DOOR CONTROL. REFER TO ELECTRONIC DOOR CONTROL DETAILS FOR REQUIREMENTS.
HA	WALL/PEDESTAL MOUNT HANDICAP DOOR ACTUATOR BUTTON, FURNISHED BY OTHERS. BOX AS REQUIRED BY SYSTEM MANUFACTURER WITH INSTALLATION AND CONDUIT TO COMMON SMS JUNCTION BOX ABOVE ACCESSIBLE CEILING PER DIV 26. ALL LOW VOLTAGE WIRING AND INTERFACE WITH SMS AND DOOR MOTOR PER DIV 28. REFER TO SECURITY ROUGH-IN DETAILS.
KC	WALL MOUNTED COMBINATION KEYPAD/CARD READER (46" MH UNLESS NOTED OTHERWISE). 2-GANG BOX WITH 0.75" CONDUIT TO COMMON SMS JUNCTION BOX ABOVE ACCESSIBLE CEILING PER DIV 26. DEVICE BY OWNER AND CABLING PER DIV 28.
MD	CEILING MOUNTED MOTION DETECTOR. 1-GANG BOX MOUNTED IN CEILING PER DIV 26. DETECTOR AND CABLING PER DIV 28.
SECL	IRITY SYMBOLS
	CCTV SYSTEM CEILING MOUNTED CAMERA.
ENE	RAL FLOOR PLAN NOTES
(	B T2 DETAIL: B = DETAIL DESIGNATION T2 = SHEET WHERE DETAIL IS LOCATED
	1     SECTION: 1 = SECTION DESIGNATION       T2     T2 = SHEET WHERE SECTION IS LOCATED
	T2 1 ELEVATION: 1 = ELEVATION DESIGNATION T2 = SHEET WHERE ELEVATION IS LOCATED
L	3     PLAN NOTE. APPLIES ONLY TO THE SHEET WHICH IT IS SHOWN.
	3 DETAIL NOTE. APPLIES ONLY TO THE ASSOCIATED DETAIL.

IECH	INOLOGY SYMBOLS						
AP	CEILING MOUNTED WIRELESS ACCESS POINT WITH DATA DROP ABOVE CEILING. PROVIDE 10' COIL IN DATA CABLE TO FACILITATE RELOCATION OF WAP. WAP PROVIDED BY OWNER, INSTALLED BY CONTRACTOR.						
	WIREMOLD RACEWAY, AS NOTED ON PLANS.						
ECF	INOLOGY SYMBOLS WITH ELEC. REQUIREMENTS						
	CONDUIT SLEEVE / FIRE RATED SLEEVE ASSEMBLY THRU WALL (1-2" SLEEVE UNLESS NOTED OTHERWISE) PER DIV 26. WALL MOUNTED DATA OUTLET (18" MH UNLESS NOTED OTHERWISE). BOX WITH CONDUIT(S) TO ABOVE CORRIDOR						
$\stackrel{X}{\nabla}$	CEILING PER DIV 26. JACKS, FACEPLATE AND CABLING PER DIV 27. SUBSCRIPT "X" DESIGNATES QUANTITY OF DATA CABLES. REFER TO FACEPLATE DETAILS.						
$\bigotimes^{\times}$	DATA OUTLET LOCATED ABOVE ACCESSIBLE CEILING. JACKS, PLENUM RATED SURFACE MOUNT BOX AND CABLING PER DIV 27. SUBSCRIPT "X" DESIGNATES QUANTITY OF DATA CABLES.						
¢	WALL MOUNTED AV OUTLET. BOX WITH CONDUITS TO ABOVE ACCESSIBLE CEILING PER DIV 26. REFER TO FACEPLATE DETAILS. JACKS, FACEPLATE AND CABLING PER DIV 27. SUBSCRIPT "X" INDICATES ALTERNATE CONFIGURATION.						
⟨ŷ <sub>x</sub>	WALL MOUNTED AV OUTLET. BOX WITH CONDUIT PER DIV 26. REFER TO FACEPLATE DETAILS. JACKS, FACEPLATE AND CABLING PER DIV 27. SUBSCRIPT "X" INDICATES ALTERNATE CONFIGURATION.						
	POKE-THRU PER DIV 26 SHOWN FOR REFERENCE, REFER TO OUTLET DETAILS.						
	YMBOLS WITH ELECTRICAL REQUIREMENTS						
(AV)	AV SYSTEM CONTROL INTERFACE. REFER TO SYSTEM DIAGRAMS. WHEN WALL MOUNTED PROVIDE BACKBOX (46" MH UNLESS						
	NOTED OTHERWISE) WITH 1" CONDUIT TO ABOVE ACCESSIBLE CEILING PER DIV 26. CONTROLLER WITH CABLING PER DIV 27. WALL MOUNTED TELECONFERENCE / AV SYSTEM CAMERA. REFER TO SYSTEM DIAGRAMS. BACKBOX WITH 1" CONDUIT TO						
	ABOVE ACCESSIBLE CEILING, CAMERA AND CABLING. CEILING MOUNT ELECTRIC PROJECTION SCREEN. 1-GANG BOX WITH 1" CONDUIT TO ABOVE ACCESSIBLE CEILING, SCREEN						
	AND AND AGE SONTROL SINGLE FACED WALL MOUNTED CLOCK. ANALOG CLOCK UNLESS SUBSCRIPT "LED" FOR LED DIGITAL CLOCK. 1-GANG BOX WITH 0.75" CONDUIT TO ABOVE ACCESSIBLE CEILING.						
ĂV Š	YMBOLS						
42	FLAT PANEL DISPLAY WITH WALL MOUNTING HARDWARE AND SUPPORTING OUTLET(S) (84" MH UNLESS NOTED OTHERWISE). # INDICATES NOMINAL SCREEN DIAGONAL SIZE.						
MC	CEILING MOUNTED MICROPHONE. REFER TO DETAILS.						
<u> </u>	CEILING MOUNTED PTZ CONFERENCING CAMERA. REFER TO DETAILS.						
<u> </u>	CEILING MOUNTED PROJECTOR. REFER TO DETAILS.						
PS	CEILING MOUNTED MANUAL PROJECTION SCREEN.						
	INTERACTIVE WHITE BOARD.						
<u> </u>	WALL MOUNTED MANUAL PROJECTION SCREEN.						
(SF)	CEILING MOUNTED SOUND FIELD SYSTEM SPEAKER.						
<u>(</u> (SR)	CEILING MOUNTED SOUND REINFORCEMENT SYSTEM SPEAKER.						
	CEILING MOUNTED SOUND REINFORGEMENT STSTEM SPEAKER.						
<b>SECI</b>	JRITY SYMBOLS WITH ELECTRICAL REQUIREMENTS						
CR	WALL MOUNTED PROXIMITY CARD READER (46" MH UNLESS NOTED OTHERWISE). 1-GANG BOX WITH CONDUIT TO COMMON SMS JUNCTION BOX ABOVE ACCESSIBLE CEILING PER DIV 26. CARD READER AND CABLING PER DIV 28. REFER TO SECURITY ROUGH-IN DETAILS.						
EDC	ELECTRONIC DOOR CONTROL. REFER TO ELECTRONIC DOOR CONTROL DETAILS FOR REQUIREMENTS.						
HA	WALL/PEDESTAL MOUNT HANDICAP DOOR ACTUATOR BUTTON, FURNISHED BY OTHERS. BOX AS REQUIRED BY SYSTEM MANUFACTURER WITH INSTALLATION AND CONDUIT TO COMMON SMS JUNCTION BOX ABOVE ACCESSIBLE CEILING PER DIV 26. ALL LOW VOLTAGE WIRING AND INTERFACE WITH SMS AND DOOR MOTOR PER DIV 28. REFER TO SECURITY ROUGH-IN DETAILS.						
KC	WALL MOUNTED COMBINATION KEYPAD/CARD READER (46" MH UNLESS NOTED OTHERWISE). 2-GANG BOX WITH 0.75" CONDUIT TO COMMON SMS JUNCTION BOX ABOVE ACCESSIBLE CEILING PER DIV 26. DEVICE BY OWNER AND CABLING PER DIV 28.						
MD	CEILING MOUNTED MOTION DETECTOR. 1-GANG BOX MOUNTED IN CEILING PER DIV 26. DETECTOR AND CABLING PER DIV 28.						
SECI	JRITY SYMBOLS						
$\bigcirc$	CCTV SYSTEM CEILING MOUNTED CAMERA.						
GEN	ERAL FLOOR PLAN NOTES						
	B DETAIL: B = DETAIL DESIGNATION						
	T2 T2 = SHEET WHERE DETAIL IS LOCATED						
	1     SECTION: 1 = SECTION DESIGNATION       T2     T2 = SHEET WHERE SECTION IS LOCATED						
	T2 1 ELEVATION: 1 = ELEVATION DESIGNATION T2 = SHEET WHERE ELEVATION IS LOCATED						
	3 PLAN NOTE. APPLIES ONLY TO THE SHEET WHICH IT IS SHOWN.						
	(3) DETAIL NOTE. APPLIES ONLY TO THE ASSOCIATED DETAIL.						

IECF	INOLOGY	SYMBOLS					
AP		WIRELESS ACCESS POINT WITH DATA DROP ABOVE CEILING. PROVIDE 10' COIL IN DATA CABLE TO ATION OF WAP. WAP PROVIDED BY OWNER, INSTALLED BY CONTRACTOR.					
	WIREMOLD RACEW	AY, AS NOTED ON PLANS.					
ГЕСН	INOLOGY	SYMBOLS WITH ELEC. REQUIREMENTS					
	CONDUIT SLEEVE /	FIRE RATED SLEEVE ASSEMBLY THRU WALL (1-2" SLEEVE UNLESS NOTED OTHERWISE) PER DIV 26.					
X       WALL MOUNTED DATA OUTLET (18" MH UNLESS NOTED OTHERWISE). BOX WITH CONDUIT(S) TO ABOVE CEILING PER DIV 26. JACKS, FACEPLATE AND CABLING PER DIV 27. SUBSCRIPT "X" DESIGNATES QUANT CABLES. REFER TO FACEPLATE DETAILS.							
Š	ATED ABOVE ACCESSIBLE CEILING. JACKS, PLENUM RATED SURFACE MOUNT BOX AND CABLING PER "X" DESIGNATES QUANTITY OF DATA CABLES.						
€x		OUTLET. BOX WITH CONDUITS TO ABOVE ACCESSIBLE CEILING PER DIV 26. REFER TO FACEPLATE ACEPLATE AND CABLING PER DIV 27. SUBSCRIPT "X" INDICATES ALTERNATE CONFIGURATION.					
⟨ŷ <sub>X</sub>		OUTLET. BOX WITH CONDUIT PER DIV 26. REFER TO FACEPLATE DETAILS. JACKS, FACEPLATE AND 7. SUBSCRIPT "X" INDICATES ALTERNATE CONFIGURATION.					
	POKE-THRU PER DI	V 26 SHOWN FOR REFERENCE, REFER TO OUTLET DETAILS.					
	YMBOLS	WITH ELECTRICAL REQUIREMENTS					
(AV)	AV SYSTEM CONTR	OL INTERFACE. REFER TO SYSTEM DIAGRAMS. WHEN WALL MOUNTED PROVIDE BACKBOX (46" MH UNLES E) WITH 1" CONDUIT TO ABOVE ACCESSIBLE CEILING PER DIV 26. CONTROLLER WITH CABLING PER DIV 27.					
	WALL MOUNTED TE	LECONFERENCE / AV SYSTEM CAMERA. REFER TO SYSTEM DIAGRAMS. BACKBOX WITH 1" CONDUIT TO					
	CEILING MOUNT EL	E CEILING, CAMERA AND CABLING. ECTRIC PROJECTION SCREEN. 1-GANG BOX WITH 1" CONDUIT TO ABOVE ACCESSIBLE CEILING, SCREEN					
	SINGLE FACED WAI	L MOUNTED CLOCK. ANALOG CLOCK UNLESS SUBSCRIPT "LED" FOR LED DIGITAL CLOCK. 1-GANG BOX T TO ABOVE ACCESSIBLE CEILING.					
AV S	YMBOLS						
42		AY WITH WALL MOUNTING HARDWARE AND SUPPORTING OUTLET(S) (84" MH UNLESS NOTED OTHERWISE). IAL SCREEN DIAGONAL SIZE.					
MC	CEILING MOUNTED	MICROPHONE. REFER TO DETAILS.					
<u></u>	CEILING MOUNTED	PTZ CONFERENCING CAMERA. REFER TO DETAILS.					
(PR)	CEILING MOUNTED	PROJECTOR. REFER TO DETAILS.					
PS	CEILING MOUNTED	MANUAL PROJECTION SCREEN.					
$\overline{\mathbb{W}}$	INTERACTIVE WHIT	E BOARD.					
Les	WALL MOUNTED M	ANUAL PROJECTION SCREEN.					
SF		SOUND FIELD SYSTEM SPEAKER.					
© ®		SOUND REINFORCEMENT SYSTEM SPEAKER.					
<u> </u>		<b>WBOLS WITH ELECTRICAL REQUIREMENTS</b> ROXIMITY CARD READER (46" MH UNLESS NOTED OTHERWISE). 1-GANG BOX WITH CONDUIT TO					
CR		CTION BOX ABOVE ACCESSIBLE CEILING PER DIV 26. CARD READER AND CABLING PER DIV 28. REFER					
EDC		CONTROL. REFER TO ELECTRONIC DOOR CONTROL DETAILS FOR REQUIREMENTS.					
HA	MANUFACTURER W	OUNT HANDICAP DOOR ACTUATOR BUTTON, FURNISHED BY OTHERS. BOX AS REQUIRED BY SYSTEM /ITH INSTALLATION AND CONDUIT TO COMMON SMS JUNCTION BOX ABOVE ACCESSIBLE CEILING PER DLTAGE WIRING AND INTERFACE WITH SMS AND DOOR MOTOR PER DIV 28. REFER TO SECURITY					
KC	WALL MOUNTED CO	DMBINATION KEYPAD/CARD READER (46" MH UNLESS NOTED OTHERWISE). 2-GANG BOX WITH 0.75" ION SMS JUNCTION BOX ABOVE ACCESSIBLE CEILING PER DIV 26. DEVICE BY OWNER AND CABLING PER					
MD		MOTION DETECTOR. 1-GANG BOX MOUNTED IN CEILING PER DIV 26. DETECTOR AND CABLING PER					
SECL	JRITY SYI	MBOLS					
	CCTV SYSTEM CEIL	ING MOUNTED CAMERA.					
GENE		OR PLAN NOTES					
	В	DETAIL: B = DETAIL DESIGNATION					
t		T2 = SHEET WHERE DETAIL IS LOCATED					
	1 T2	SECTION: 1 = SECTION DESIGNATION T2 = SHEET WHERE SECTION IS LOCATED					
	T2 1	ELEVATION: 1 = ELEVATION DESIGNATION T2 = SHEET WHERE ELEVATION IS LOCATED					
	3	PLAN NOTE. APPLIES ONLY TO THE SHEET WHICH IT IS SHOWN.					
	(3)	DETAIL NOTE. APPLIES ONLY TO THE ASSOCIATED DETAIL.					

B T2	DETAIL: B = DETAIL DESIGNATION T2 = SHEET WHERE DETAIL IS LOCATED
1 T2	SECTION: 1 = SECTION DESIGNATION T2 = SHEET WHERE SECTION IS LOCATED
T2 1	ELEVATION: 1 = ELEVATION DESIGNATION T2 = SHEET WHERE ELEVATION IS LOCATED
$\langle 3 \rangle$	PLAN NOTE. APPLIES ONLY TO THE SHEET WHICH IT IS SHOWN.
3	DETAIL NOTE. APPLIES ONLY TO THE ASSOCIATED DETAIL.
<u></u>	LADDER TRAY, 12" x 4" DEEP UNLESS NOTED OTHERWISE.
	CABLE TRAY, 12" x 4" DEEP UNLESS NOTED OTHERWISE.
4"	CONDUIT RUN IN WALL OR ABOVE CEILING.
	CONDUIT RUN IN SLAB OR UNDERGROUND.
CM	CABLE MANAGEMENT SYSTEM PATHWAY.
$\bigotimes \nabla [x]$	DASH SYMBOL INDICATES PARTICULAR OUTLET, DEVICE, OR EQUIPMENT TO BE REMOVED AND SUPPORTING CABLING TO BE REMOVED BACK TO SOURCE OF ORIGIN UNLESS NOTED OTHERWISE.
$\mathbf{X}$ $\nabla$ $\mathbf{X}$	EXISTING OUTLET, DEVICE, OR EQUIPMENT TO REMAIN. MAINTAIN EXISTING CABLING.
▼ ♦	SURFACE MOUNTED OUTLET OR DEVICE. REFER TO PLANS AND DETAILS.

SHEET
T00-00
T00-02
T10-02
T50-01
T50-02
T50-03
T50-04
Total Co

# **TECHNOLOGY SYMBOLS**

# <u>NOTE:</u> ALL SYMBOLS AND ABBREVIATIONS ARE SUBJECT TO MODIFICATIONS ON OTHER DRAWINGS.

# ALL SYMBOLS OR ABBREVIATIONS MIGHT NOT NECESSARILY BE USED ON THIS PROJECT.


TECHNOLOGY SHEET LIST							
NUMBER SHEET NAME							
	TECHNOLOGY LEGEND						
	DEMOLITION PLAN						
	FLOOR PLAN						
	TECHNOLOGY DETAILS						
	TECHNOLOGY DETAILS						
	AV SCHEMATIC - LARGE CLASSROOM						
	AV SCHEMATIC - SMALL CLASSROOM						
unt: 7							

# ABBREVIATIONS

<b>ADDI</b>	REVIATIONS
AAP ACC ADJ AF AFCI AFG ALT APPROX ARCH ASSY ATS	<ul> <li>AREA ALARM PANEL - MEDICAL GAS</li> <li>ACCESS</li> <li>ADJUSTABLE</li> <li>ARC FAULT CIRCUIT INTERRUPTER</li> <li>ARC FAULT CIRCUIT INTERRUPTER</li> <li>ABOVE FINISHED FLOOR TO BOTTOM OF ITEM</li> <li>ABOVE FINISHED GRADE TO BOTTOM OF ITEM</li> <li>ALTERNATE</li> <li>ACCESS PANEL</li> <li>APPROXIMATE</li> <li>ARCHITECT OR ARCHITECTURAL</li> <li>ASSEMBLY</li> <li>AUTOMATIC TRANSFER SWITCH</li> </ul>
BLDG BOE BOT BTWN	- BUILDING - BOTTOM OF EQUIPMENT - BOTTOM - BETWEEN
CFCI CKT CLG CMU CONN CONTR CORR CTR	- CONTRACTOR FURNISHED CONTRACTOR INSTALLED - CIRCUIT - CEILING - CONCRETE MASONRY UNIT - CONNECT OR CONNECTION - CONTRACTOR - CORRIDOR - CENTER
) Det Dia Dim Div Div Div Div Div	- DEPTH - DETAIL - DIAMETER - DIMENSION - DIVISION - DOWN - DRAWING
A ELEC ELEV EM EQ EQS EQUIP ERCS ETR EX EXP EXT	<ul> <li>EACH</li> <li>ELECTRICAL CONTRACTOR (DIVISION 26)</li> <li>EXPANSION JOINT</li> <li>ELECTRICAL</li> <li>ELEVATION OR ELEVATOR</li> <li>EMERGENCY</li> <li>EQUAL</li> <li>EQUIPMENT SUPPLIER</li> <li>EQUIPMENT</li> <li>EMERGENCY RESPONDER RADIO COVERAGE SYSTEM</li> <li>EXISTING TO REMAIN</li> <li>EXISTING</li> <li>EXPANSION</li> <li>EXTERIOR</li> </ul>
FCE FF FLR FSC FT FTG	- FIRE CONTROL EQUIPMENT - FINISHED FLOOR ELEVATION - FLOOR - FIRE SUPPRESSION CONTRACTOR (DIVISION 21) - FEET - FOOTING
GC GF GFCI GFFT	- GENERAL CONTRACTOR - GROUND FAULT CIRCUIT INTERRUPTER - GROUND FAULT CIRCUIT INTERRUPTER OR GOVERNMENT FURNISHED CONTRACTOR INSTALLED - GROUND FAULT FEED THRU
IC IP IVAC	- HVAC CONTRACTOR (DIVISION 23) - HORSE POWER OR HIGH POINT - HEATING, VENTILATING, AND AIR CONDITIONING
D N	- INSIDE DIAMETER - INCHES
KEC	- KITCHEN EQUIPMENT CONTRACTOR
BS	- LENGTH - POUNDS
MAP MAX MEZZ MFR MH MIN MISC MISC MTD MTG	<ul> <li>MASTER ALARM PANEL (MEDICAL GAS)</li> <li>MAXIMUM</li> <li>MEZZANINE</li> <li>MANUFACTURER</li> <li>MANHOLE OR MOUNTING HEIGHT TO CENTER LINE OF ITEM</li> <li>MINIMUM OR MINUTE</li> <li>MISCELLANEOUS</li> <li>MOUNTED</li> <li>MOUNTING</li> </ul>
NIC NOM NTS	- NOT IN CONTRACT - NOMINAL - NOT TO SCALE
DD DFCI DFOI	- OUTSIDE DIAMETER - OWNER FURNISHED CONTRACTOR INSTALLED - OWNER FURNISHED OWNER INSTALLED
PC PLBG	- PLUMBING CONTRACTOR (DIVISION 22) - PLUMBING
RAD REC REQD RI	- RADIUS - RECESSED - REQUIRED - ROUGH-IN
SC SCH SHT SMS SPEC SQ SS STD	- SURFACE MOUNTED - SECURITY CONTRACTOR - SCHEDULE - SHEET - SECURITY MANAGEMENT SYSTEM - SPECIFICATIONS - SQUARE - STAINLESS STEEL - STANDARD - STRUCTURAL OR STRUCTURE - SITE UTILITY CONTRACTOR
EMP	- TECHNOLOGY CONTRACTOR - TEMPERATURE - TOP OF EQUIPMENT - TYPICAL
JNO	- UNLESS NOTED OTHERWISE
/FD /OL N/	- VARIABLE FREQUENCY DRIVE - VOLUME - WITH
N/O NP	- WITH - WITHOUT - WEATHERPROOF
ZVC	- ZONE VALVE CABINET



20	DATE			DEV
	<b>DATE</b> 024 04 23 024 05 16	50% Construc	tion Set Owners Review 6 CD Client Review	REV
20 20	024 06 06 024 06 27	Issued for 100 Issued for Bid	% CD Client Review and Building Permit	
20	024 07 31	Addendum #2		1
S	STATE UNIVE	ERSITY and the	red solely for the use of V ere are no representations	s of any
k		NORR to any p	party with whom NORR ha	
Т	his drawing s	shall not be use	d for construction purpos	es until
tł			signed and dated by the <i>i</i>	
Ρ	Project Compo	onent		
K	ey Plan			
C	Consultants Survey:			
	Civil: Architecture: Structural:	NORR		
	Mechanical: Electrical: Interiors:	NORR NORR NORR		
	Landscape:			
S	Seal(s)	~1		
		NICATI	UNS DISTRIB	
		AD		
		Bi	CSI II	
	FREDCOL	Jeffrey BICSI I	M Schloffel D # 102917	
	LAFRED CO.	Jeffrey BICSI I EXPIR	M Schloffel D # 102917 ES 12-31-25	
	LAFRED CO.	Jeffrey BICSI I EXPIR	ONS DISTRIBUTION DESTINATIONS DISTRIBUTION DESTINATION	
		Jeffrey BICSI I EXPIR		
	<b>N</b>	<b>OR</b>	R	
	<b>N</b>	OR	R	
	150 W. Jef Detroit, MI	<b>OR</b>	R	
	150 W. Jef Detroit, MI	<b>OR</b>	R	
	150 W. Jef Detroit, MI	OR fferson Avenue, US 48226	e., Suite 1300 Drawn	
	150 W. Jef Detroit, MI norr.com	OR fferson Avenue , US 48226	e., Suite 1300 Drawn PJB Checked	
P	150 W. Jef Detroit, MI norr.com	OR fferson Avenue , US 48226	R e., Suite 1300 Drawn PJB Checked JDK	
P	150 W. Jef Detroit, MI norr.com	OR fferson Avenue , US 48226	e., Suite 1300 Drawn PJB Checked	SITY
P	150 W. Jef Detroit, MI norr.com	OR fferson Avenue , US 48226	R e., Suite 1300 Drawn PJB Checked JDK	SITY
P	150 W. Jef Detroit, MI, norr.com	OR fferson Avenue US 48226	R e., Suite 1300 Drawn PJB Checked JDK TE UNIVER	SITY
P	150 W. Jef Detroit, MI, norr.com Project Manage Project Leade Client WAYN	OR fferson Avenue US 48226 Jer r NE STA - COLL	R e., Suite 1300 Drawn PJB Checked JDK	
P	150 W. Jef Detroit, MI, norr.com Project Manage Project Leader Client WAYN	OR fferson Avenue US 48226 ger r NE STA - COLL SING RE	R e., Suite 1300	
P	150 W. Jef Detroit, MI norr.com Project Manage Project Leader Client WAYN Project WSU NURS DETROIT, I	OR fferson Avenue US 48226 yer r NE STA - COLL SING RE WICHIGAN, US	R e., Suite 1300 Drawn PJB Checked JDK TE UNIVER EGE OF ENOVATION	S
P	150 W. Jef Detroit, MI norr.com Project Manage Project Leader Client WAYN Project WSU NURS DETROIT, I	OR fferson Avenue US 48226 yer r NE STA - COLL SING RE WICHIGAN, US	R e., Suite 1300	S
P	150 W. Jef Detroit, MI norr.com Project Manage Project Leader Client WAYN Project WSU NURS DETROIT, I	OR fferson Avenue US 48226 yer r NE STA - COLL SING RE WICHIGAN, US	R e., Suite 1300 Drawn PJB Checked JDK TE UNIVER EGE OF ENOVATION	S
P	150 W. Jef Detroit, MI norr.com Project Manage Project Leader Client WAYN Project WSU NURS DETROIT, I	OR fferson Avenue US 48226 yer r NE STA - COLL SING RE WICHIGAN, US	R e., Suite 1300 Drawn PJB Checked JDK TE UNIVER EGE OF ENOVATION	S
P	150 W. Jef Detroit, MI norr.com Project Manage Project Leader Client WAYN Project WSU NURS DETROIT, I	OR fferson Avenue US 48226 yer r NE STA - COLL SING RE WICHIGAN, US	R e., Suite 1300 Drawn PJB Checked JDK TE UNIVER EGE OF ENOVATION	S
P	150 W. Jef Detroit, MI, norr.com Project Manage Project Leader Client WAYN Project WSU NURS DETROIT, I Drawing Title TECH	OR fferson Avenue US 48226 yer r NE STA - COLL SING RE WICHIGAN, US	R e., Suite 1300	S
P C P	Toject Manage Project Leader Client WAYN Project Leader DETROIT, I DETROIT, I DETROIT, I DETROIT, I DETROIT, I	OR fferson Avenue US 48226 ger r NE STA - COLL SING RE MICHIGAN, US INOLO	PJB Checked JDK TEUNIVER EGEOF SNOVATION GY LEGEND	S

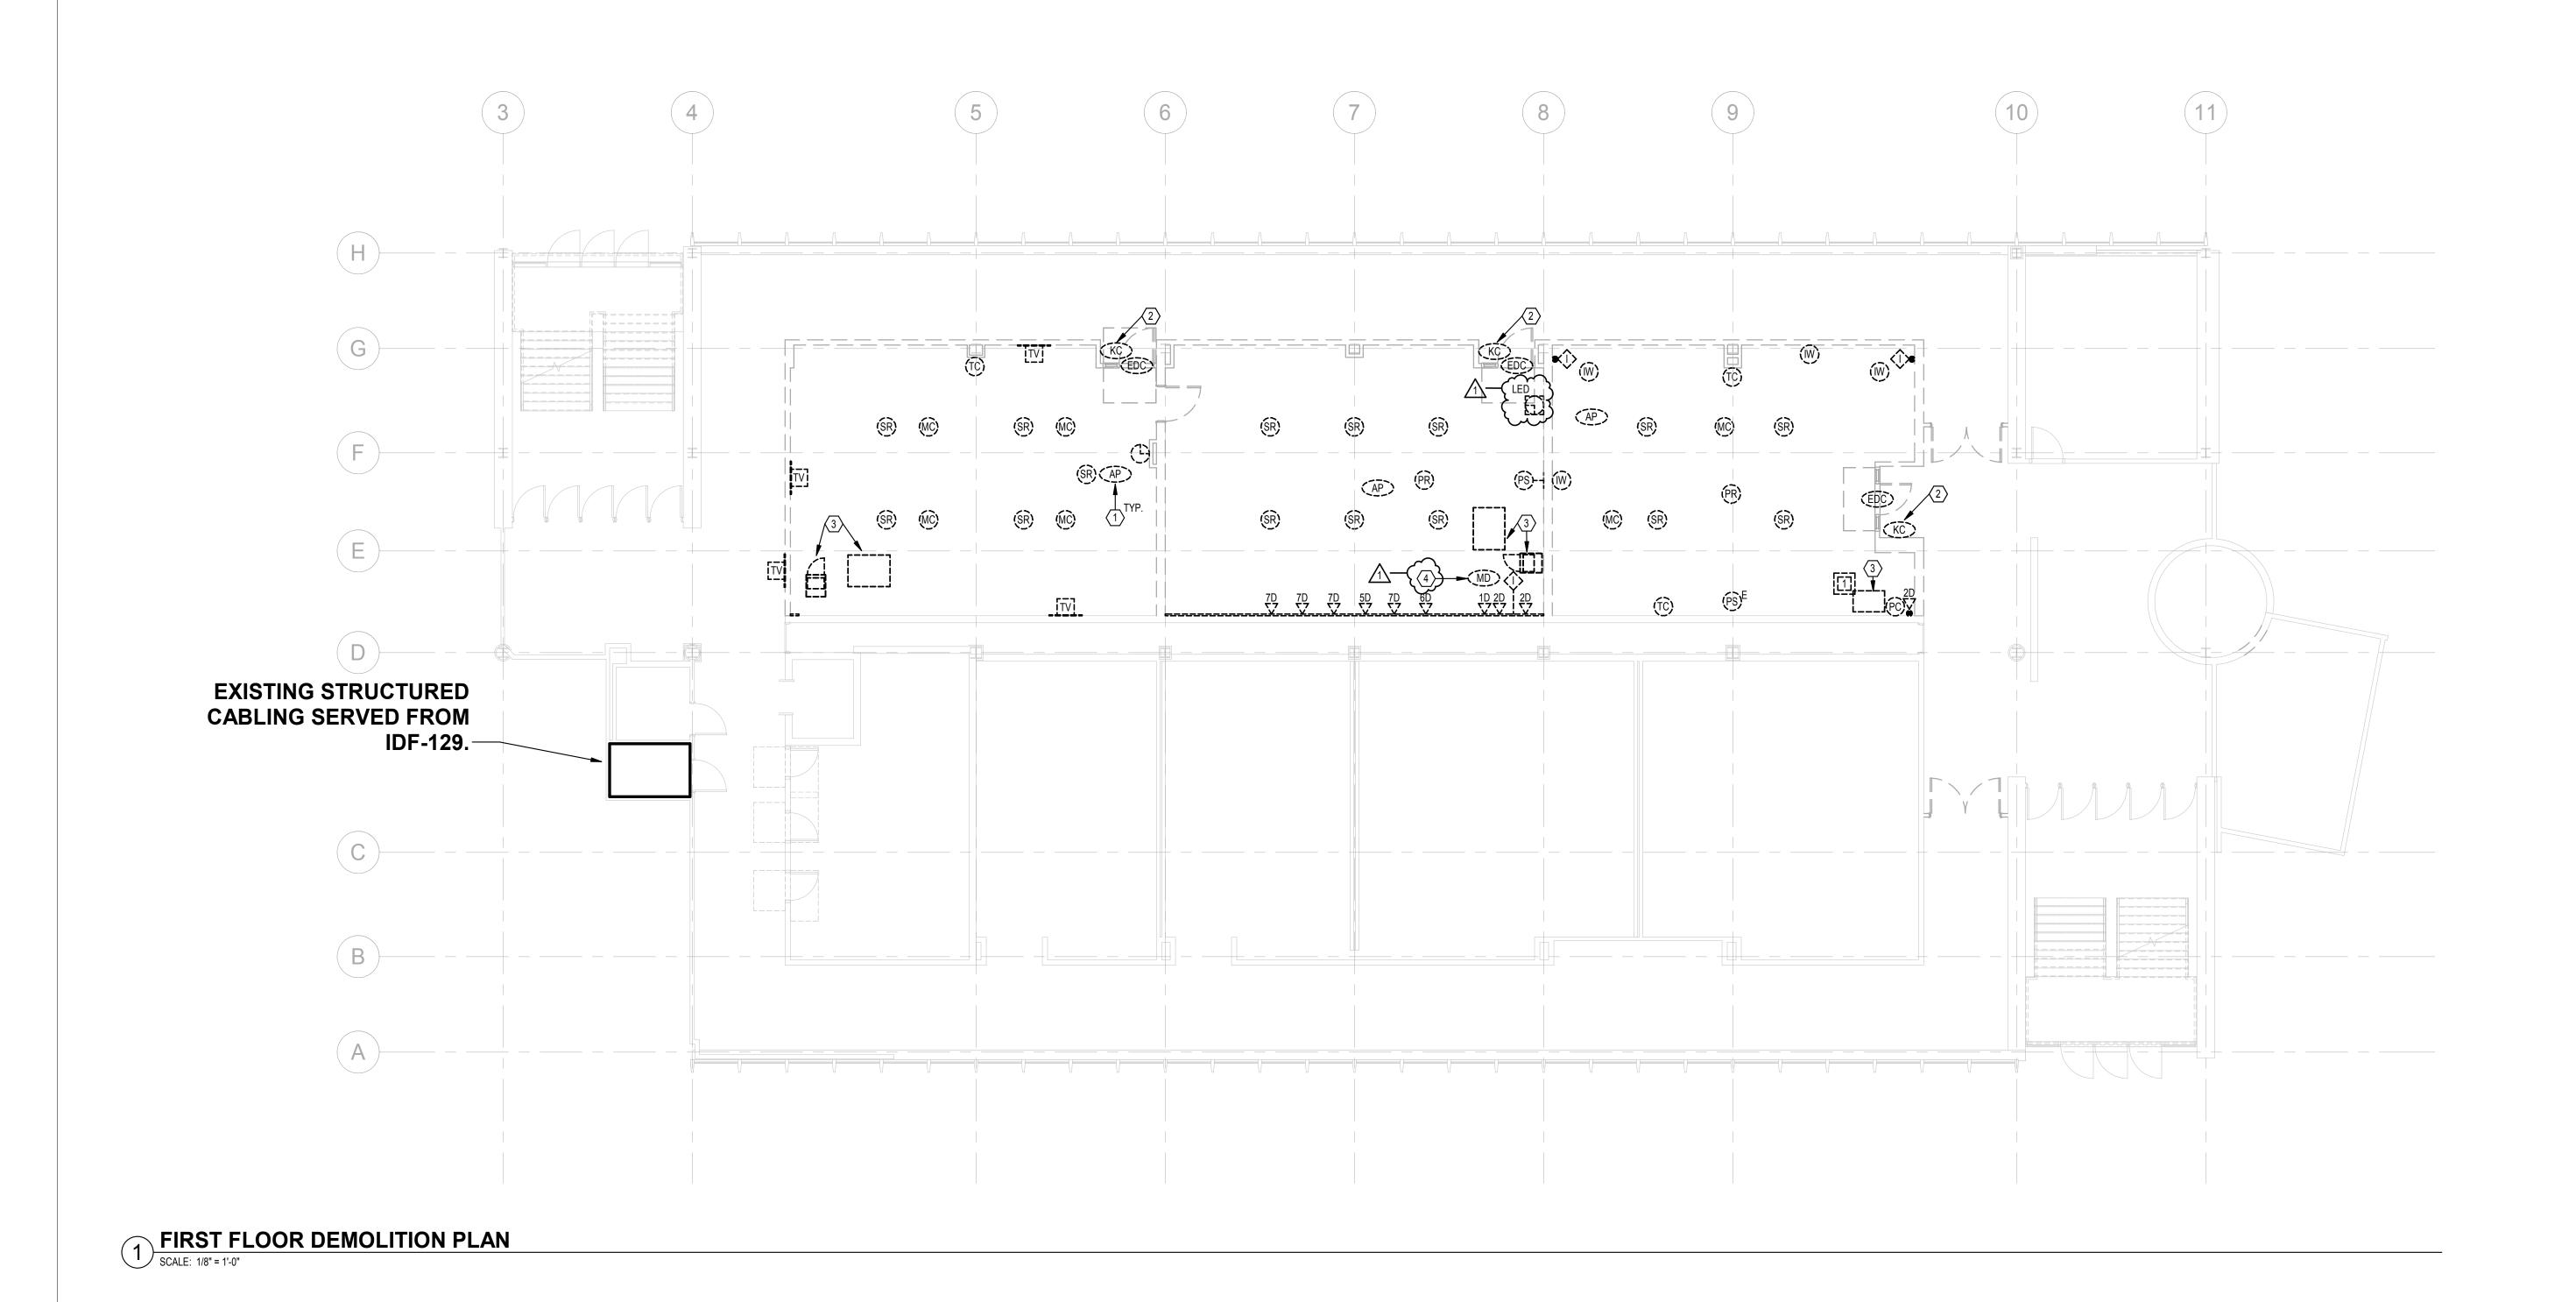

k Docs://WSU - Nursing School Renovations/2024-91003-T-Central.rvt

# GENERAL DEMOLITION NOTES


A. RE-SUPPORT ANY EXISTING WIRING OR CONDUITS TO REMAIN.

- B. REMOVAL PLANS MAY NOT NECESSARILY SHOW ALL ITEMS REQUIRED TO BE REMOVED. EACH BIDDER SHALL VISIT THE SITE PRIOR TO BID TO DETERMINE THE FULL EXTENT OF REMOVALS REQUIRED. MAINTAIN FUNCTIONALITY OF EXISTING TELECOMMUNICATIONS SYSTEMS CUT OFF BY REMOVALS.
- C. THE EXISTING CEILING SPACES MAY CONTAIN NUMEROUS EXISTING OPEN-WIRED CABLES SERVING TELEPHONE, CCTV, INTERCOM, DATA, PAGING, ETC. CABLES THAT ARE TO REMAIN SHALL BE TEMPORARILY SUPPORTED FROM THE STRUCTURE TO ALLOW FOR THE REMOVAL AND / OR REPLACEMENT OF THE EXISTING CEILINGS.
- D. COORDINATE WITH THE OWNER IN REGARD TO REMOVALS. SALVAGE EQUIPMENT AS DIRECTED BY THE OWNER AND STORE IN A LOCATION DESIGNATED BY OWNER. ALL OTHER EQUIPMENT AND MATERIALS NOT SALVAGED SHALL BE REMOVED FROM THE PREMISE.
- E. ALL CONDUITS AND TELECOMMUNICATIONS CABLING LOCATED INSIDE DEMO WALLS SERVING ITEMS OUTSIDE OF THE PROJECT SCOPE SHALL BE REROUTED TO INSURE A COMPLETE AND FUNCTIONAL SYSTEM WHILE ACCOMMODATING THE WALL REMOVAL.
- F. REFER TO THE ARCHITECTURAL DOCUMENTS FOR CONSTRUCTION PHASING SEQUENCE.
- G. ALL ABANDONED EXTRANEOUS CONDUITS AND SUPPORTS SHALL BE REMOVED.H. REMOVALS OF TELEPHONE / DATA OUTLETS INCLUDE REMOVAL OF THE DEVICE, BACKBOX,
- CONDUIT AND CABLING BACK TO THE POINT OF ORIGINATION. I. EXISTING CONDITIONS SHOWN ON THIS DRAWING ARE TAKEN FROM ORIGINAL DRAWINGS
- AND FIELD INVESTIGATION. ALL EXISTING CONDITIONS SHALL BE VERIFIED PRIOR TO BID.
- J. ALL EXISTING CONDUIT, EQUIPMENT, AND DEVICES SHOWN DASHED SHALL BE REMOVED. REMOVE ALL INCIDENTAL ITEMS ASSOCIATED WITH THE DEMOLITION WORK.
   K. CONTRACTOR SHALL PROVIDE AUDIT OF THE DEMOLISHED / EXISTING DATA. AUDIT SHALL
- TAKE PLACE PRIOR TO DEMOLITION ACTIVITIES. C&IT MUST APPROVE BEFORE COMMENCEMENT OF ANY WORK. AN EXAMPLE TEMPLATE CAN BE PROVIDED UPON REQUEST. AUDIT SHALL INCLUDING THE FOLLOWING: a. CABLE MANUFACTURER / CATEGORY
- b. MDF / IDF NUMBER WHERE CABLE IS TERMINATED
  c. JACK NUMBER
  d. CABLE PURPOSE (DATA OR VOICE)


# 

<u>\_1</u>\_\_\_\_


- 1. REMOVE EXISTING WIRELESS ACCESS POINT & CABLING AND TURN OVER TO OWNER FOR FUTURE USE. COIL, LABEL, AND SECURE CABLING FOR REUSE FOR NEW AP LOCATIONS.
- REMOVE EXISTING ACCESS CONTROL DEVICES AND TURN OVER TO OWNER FOR REUSE DURING NEW WORK. PULL BACK, COIL, AND LABEL SECURITY CABLING ABOVE ACCESSIBLE CEILING FOR REUSE.

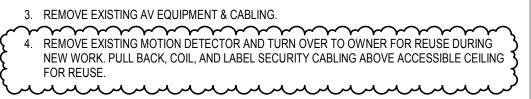



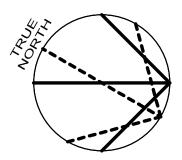

			1
<b>DATE</b> 2024 04 23	50% Construct	IVED FOR	REV
2024 05 16 2024 06 06 2024 06 27	Issued for 100	CD Client Review % CD Client Review and Building Permit	
2024 00 27 2024 07 31	Addendum #2		1
STATE UNIVE	ERSITY and the	ed solely for the use of V re are no representations arty with whom NORR ha	s of any
entered into a			
		I for construction purpose	
or Engineer		igned and dated by the A	Architect
Project Compo	onent		
Key Plan			
Consultants			
Survey: Civil: Architecture:	NORR		
Structural: Mechanical: Electrical:	NORR NORR NORR		
Interiors: Landscape:	NORR		
Seal(s)	ILATIO	ONS DIST.	
	MUM -	RIBU	
		ONS DIST RIFUTION DESC M Schloffel # 102917 5512-31-25	
TERF	BICSI I		
	Expiri	512-31-25 · ·	
	• R	CDD •	
		D	
	OR		
	ferson Avenue	., Suite 1300	
Detroit, MI norr.com	, US 48226		
Project Manag		Drawn PJB Checked	
Project Leade	ſ 	JDK	
	NE STA <sup>.</sup>		SITY
Project		EGE OF	
		NOVATION	S
DETROIT. I	MICHIGAN, US		
Drawing Title			
Scale			
	1/8" = 1	'-0"	
Project No.	ED2024	-0063	
Drawing No.	T00-0	2	

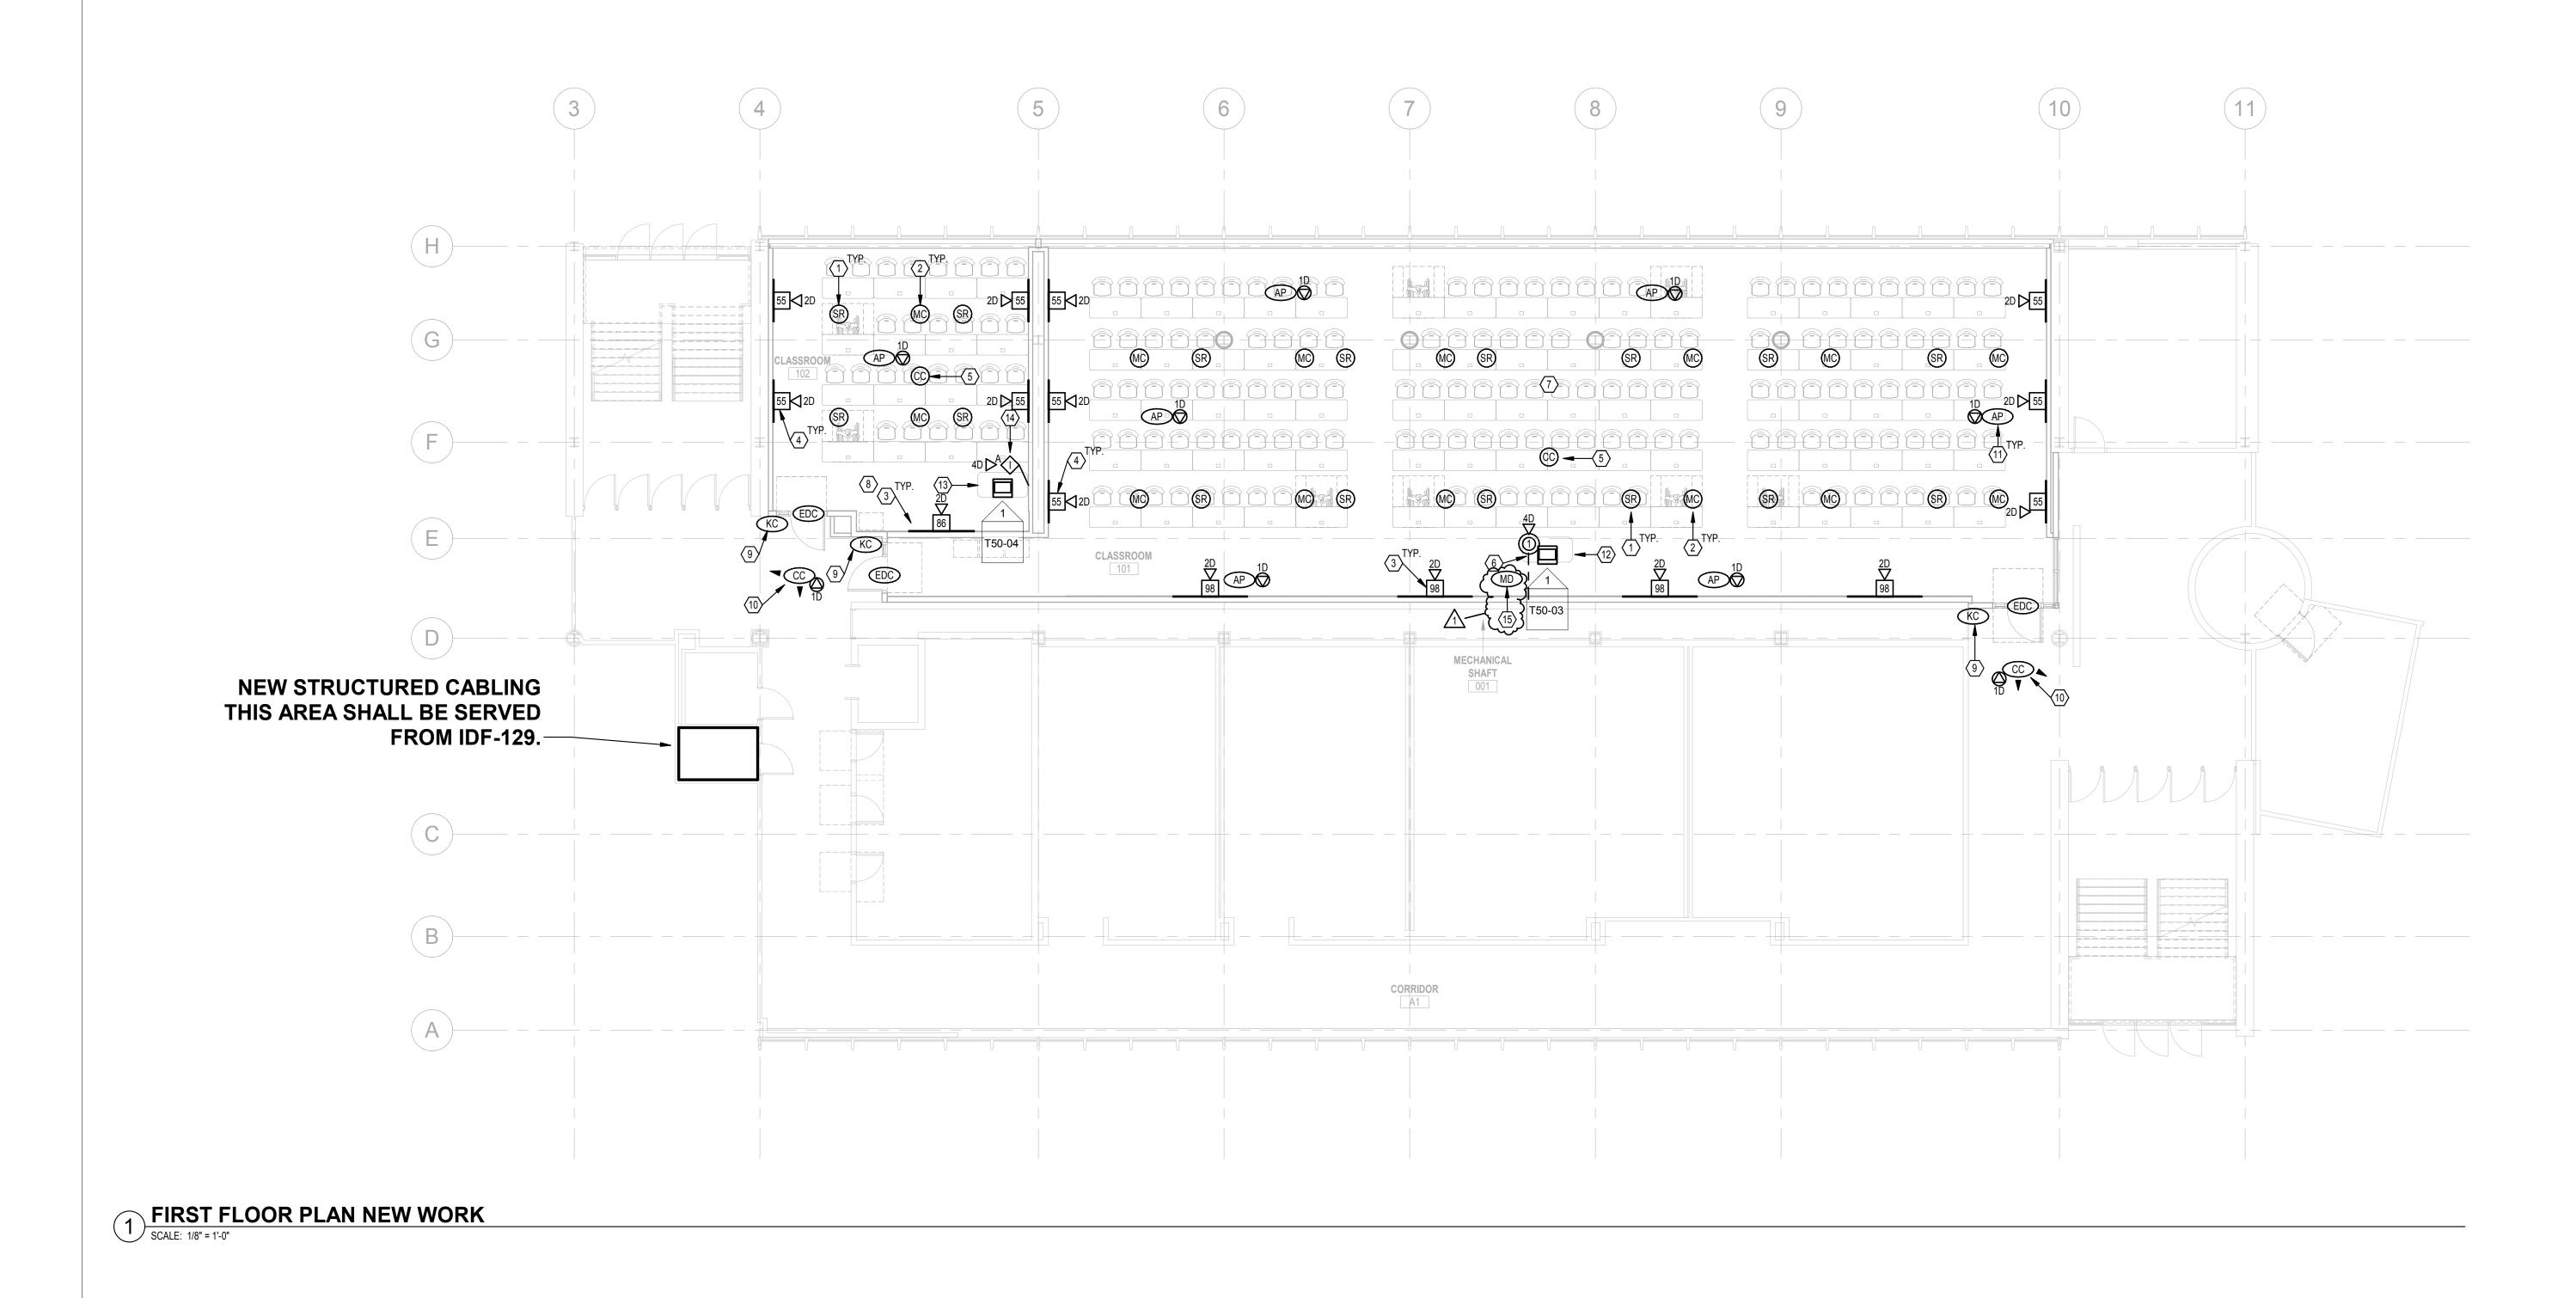

c Docs://WSU - Nursing School Renovations/2024-91003-T-Central.rvt

# **GENERAL NOTES**

### A. CONDUITS SHALL BE SIZED FOR 1" MINIMUM.

- B. AV SYSTEMS ARE BEING FURNISHED BY THE OWNER OR THEIR VENDOR.
- C. ALL JUNCTION BOXES ARE TO BE FLUSH MOUNTED UNLESS OTHERWISE NOTED.
- D. NEW SYSTEM WIRING FOR STRUCTURED CABLING WILL BE OPEN WIRED. PROVIDE J-HOOKS ON FIVE (5) FOOT CENTERS DOWN ALL CORRIDORS AND WITHIN LARGE AREAS.
- E. FIRESTOP ALL PENETRATIONS THRU WALLS.
- F. VERIFY EXACT LOCATION OF ALL CEILING MOUNTED DEVICES WITH REFLECTED CEILING PLAN AND/OR ARCHITECT PRIOR TO ROUGH-IN. COORDINATE LOCATIONS OF CEILING MOUNTED DEVICES WITH LIGHT FIXTURES, MECHANICAL DUCTS, AND SPRINKLER PIPES AND HEADS BEFORE ROUGH-IN TO PREVENT CONFLICTS.
- G. REMOVE EXISTING CEILING TILES AS REQUIRED FOR INSTALLATION OF NEW TECHNOLOGY ITEMS AND REINSTALL TILES IN A SIMILAR MANNER AS NOW EXISTS.
- H. COORDINATE EXACT LOCATION OF ALL SWITCHES, RECEPTACLES, DATA OUTLETS, VOLUME CONTROLLERS, AV SYSTEM CONTROLLERS, THERMOSTATS, ETC. WITH RESPECTIVE CONTRACTORS PRIOR TO ROUGH-INS. ALL MOUNTING HEIGHTS OF DEVICES WHICH ARE MOUNTED ADJACENT TO EACH OTHER SHALL BE AT THE SAME DISTANCE MEASURED ABOVE THE FINISHED FLOOR.
- I. STAGGER RECEPTACLES AND OTHER RECESSED OUTLETS WHEN LOCATED ON OPPOSITE SIDES OF PARTITION / WALL TO ELIMINATE SOUND TRANSMISSION FROM ONE SPACE TO THE OTHER.
- J. WHERE DEVICES ARE MOUNTED IN AREAS WHERE THERE ARE EXPOSED CEILINGS, COORDINATE THE EXACT MOUNTING / LOCATION WITH THE STRUCTURAL SUPPORT MEMBERS AND WORK OF OTHER TRADES. PROVIDE ALL NECESSARY LABOR AND MATERIALS TO ACHIEVE MOUNTING HEIGHTS AND LOCATIONS AS INDICATED ON THE PLANS.
- K. ANY EXPOSED CONDUITS WITHIN THE FINISHED PORTIONS OF THE BUILDING SHALL BE PRIME AND FINISH PAINTED.
- L. ALL EMPTY CONDUITS SHALL BE INSTALLED WITH PULL STRING.
- M. WHERE EXISTING WALLS ARE FURRED ON ONE SIDE, ALL NEW SERVICES SHALL BE INSTALLED IN THE WALL FROM THE FURRED OUT SIDE OF THE WALL.
- N. EXISTING CONDITIONS SHOWN ON THIS DRAWING ARE TAKEN FROM ORIGINAL DRAWINGS AND FIELD INVESTIGATION. ALL EXISTING CONDITIONS SHALL BE VERIFIED PRIOR TO BID.
- O. ALL CONDUIT SLEEVES THRU WALLS AND FLOORS, NOT SPECIFICALLY SHOWN ON DRAWINGS BUT REQUIRED FOR COMPLIANT INSTALLATION OF CABLING SHALL BE PROVIDED AS PART OF THE SCOPE OF WORK.
- P. COMPLETELY AND THOROUGHLY COORDINATE ALL PATHWAYS BEING PROVIDED. ANY PATHWAYS THAT ARE PROVIDED THAT CAUSE CABLING INSTALLATION TO BE NON-COMPLIANT SHALL BE BROUGHT TO THE ATTENTION OF THE ENGINEER PRIOR TO THE INSTALLATION OF CABLING.
- Q. A 3.5" DEEP MASONRY BOX SHALL BE USED IN CMU WALLS.
- R. BOND ALL CABLE RUNWAY SPLICES AND BUTT JOINTS WITH #6 AWG BOLTED TO CABLE RUNWAY. REMOVE PAINT OFF OF CABLE RUNWAY FOR METAL TO METAL CONNECTION AND APPLY ANTI-OXIDANT JOINT COMPOUND OVER ANY REMAINING AREAS WITH BARE METAL EXPOSED.
- S. ALL CONDUITS SHALL HAVE NYLON BUSHINGS INSTALLED.
- T. PULL BOXES SHALL NOT BE USED TO CHANGE DIRECTION AND SHALL BE INSTALLED IN LINE WITH CONDUIT.
- U. ELECTRICAL CONTRACTOR SHALL INSTALL 4" SQ. SHEET STEEL WALL BOXES, MINIMUM 1" TRADE SIZE CONDUIT (OR AS INDICATED ON DRAWINGS) STUBBED 12" ABOVE CEILING WITH 6" RADIUS (OR AS REQUIRED BY ANSI/TIA-569 C), WITH A 90-DEGREE BEND AT TOP IN THE DIRECTION TOWARDS ROUTE DESTINATION, AND PLASTIC BUSHING FOR RECESSED LOCATIONS.
- V. ELECTRICAL CONTRACTOR SHALL INSTALL 4" SQ. CAST BOXES. MINIMUM 1" TRADE SIZE CONDUIT (OR AS INDICATED ON DRAWINGS) STUBBED UP TO 10' AFF (OR AS INDICATED ON DRAWINGS), WITH 6" RADIUS (OR AS REQUIRED BY ANSI/TIA-569 C) FOR SURFACE MOUNTED LOCATIONS.
- W. JACK SYMBOLS ADJACENT TO WALL-MOUNTED DISPLAYS, WIRELESS ACCESS POINTS, & VIDEO SURVEILLANCE CAMERA DEVICES ARE SHOWN FOR ADDITIONAL CLARITY ON NETWORK CONNECTIVITY AND DO NOT NECESSARILY INDICATE ADDITIONAL CABLING. REFER TO OUTLET DETAILS FOR SPECIFIC REQUIREMENTS.

# $\bigcirc$ PLAN NOTES


- 1. CEILING MOUNTED SOUND REINFORCEMENT SYSTEM SPEAKER.
- 2. CEILING MOUNTED MICROPHONE.
- 3. MAIN DISPLAY LOCATION. PROVIDE (2) DATA. WALL MOUNT BRACKET SHALL ALLOW FOR MONITOR TO FULLY PULL AWAY FROM WALL TO ALLOW FOR EASE OF ACCESS. REFER TO ARCHITECTURAL DRAWINGS FOR EXACT LOCATION PRIOR TO ROUGH-IN.
- BREAKOUT GROUP DISPLAY LOCATION. PROVIDE (2) DATA. WALL MOUNT BRACKET SHALL ALLOW FOR MONITOR TO FULLY PULL AWAY FROM WALL TO ALLOW FOR EASE OF ACCESS. REFER TO ARCHITECTURAL DRAWINGS FOR EXACT LOCATION PRIOR TO ROUGH-IN.
   CEILING MOUNTED TELECONFERENCING CAMERA.
- 6. FLOOR BOX FOR CONNECTION TO PODIUM. PROVIDE LEGRAND 10AT PREWIRED EVOLUTION SERIES POKE THRU DEVICE OR EQUAL. PROVIDE (4)-1.25" CONDUITS FOR DATA / AV USE ONLY. PROVIDE 24" SLACK FOR ALL CABLING. ALL CONNECTIONS FROM PODIUM SHALL BE TERMINATED WITHIN FLOOR BOX TO ALLOW COMPLETE DISCONNECTION OF PODIUM BY OWNER.
- REFER TO AV SCHEMATIC ON SHEET T50-03 FOR INFORMATION PERTAINING TO AV SYSTEM SERVING THIS SPACE.
- REFER TO AV SCHEMATIC ON SHEET T50-04 FOR INFORMATION PERTAINING TO AV SYSTEM SERVING THIS SPACE.
- ACCESS CONTROL DEVICES REMOVED DURING DEMOLITION SHALL BE REINSTALLED. REFER TO SECURITY DOOR DETAILS AND ARCHITECTURAL ELEVATIONS FOR EXACT ROUGH-IN REQUIREMENTS. RELOCATE SECURITY CABLING MADE AVAILABLE BY DEMOLITION FOR REUSE ON RELOCATED SECURITY DEVICES AND EXTEND AS NEEDED TO ACCOMMODATE NEW WORK.
- 10. PROVIDE CEILING MOUNTED CAMERA, <u>AXIS MODEL TO BE COORDINATED WITH WSU</u>. WSU SHALL PROVIDE LICENSING AS REQUIRED TO SUPPORT THE NEW CAMERAS. COORDINATE WITH WSU PRIOR TO INSTALLATION OF CAMERAS. PROVIDE TWO (2) DARK PURPLE OR VIOLET PATCH CORDS PER INDOOR CAMERA OUTLET INSTALLED. ANY CAMERA OR DEVICE MUST HAVE ALL REQUIRED ASSOCIATED COMPONENTS INSTALLED. THIS CONTRACTOR MUST PURCHASE THE CAMERAS, THEN PROVIDE ALL CAMERA MAC ADDRESSES AND LOCATIONS ON A C&IT-PROVIDED SPREADSHEET TEMPLATE TO THE CAMERA TEAM. THE SECURITY VENDOR WILL PROGRAM AND APPLY THE LATEST FIRMWARE UPGRADE AVAILABLE FROM THE CAMERA MANUFACTURER. BEFORE A REQUEST FOR IP ADDRESS CAN BE GIVEN OUT, THE INSTALLING VENDOR MUST SUBMIT A SPREADSHEET WITH THE FOLLOWING: CAMERA NAME, LOCATION, JACK/PANEL ID, IDF/ MDF CONNECTED IN, MAKE, MODEL, AND SERIAL
- 11. OFCI CEILING MOUNTED WIRELESS ACCESS POINT.

NUMBER/ MAC ADDRESS.


- 12. PROVIDE <u>SPECTRUM INDUSTRIES MODEL # 55418GTBKCMS100000L3015 W/ LOGO.</u> AV EQUIPMENT SERVING THIS SPACE SHALL BE INSTALLED WITHIN THE INTEGRAL RACK AND PATCHED FROM POKE THRU. COORDINATE FINAL CONFIGURATION AND LOGO DESIGN WITH OWNER PRIOR TO ORDERING AND SUBMIT TO ENGINEER FOR FINAL APPROVAL.
- 13. PROVIDE <u>SPECTRUM INDUSTRIES MODEL # 55542GTBKDS1000000F1A01.</u> AV EQUIPMENT SERVING THIS SPACE SHALL BE INSTALLED WITHIN THE INTEGRAL RACK AND PATCHED FROM FSR WALL BOX. COORDINATE FINAL CONFIGURATION WITH OWNER PRIOR TO ORDERING AND SUBMIT TO ENGINEER FOR FINAL APPROVAL.
- 14. WALL MOUNTED FSR BOX FOR CONNECTION TO PODIUM. PROVIDE (3)-1.25" CONDUITS FOR DATA / AV USE ONLY. PROVIDE 24" SLACK FOR ALL CABLING. ALL CONNECTIONS FROM PODIUM SHALL BE TERMINATED WITHIN FSR BOX TO ALLOW COMPLETE DISCONNECTION OF PODIUM BY OWNER.
- 15. MOTION DETECTOR REMOVED DURING DEMOLITION SHALL BE REINSTALLED. RELOCATE SECURITY CABLING MADE AVAILABLE BY DEMOLITION FOR REUSE ON RELOCATED SECURITY DEVICES AND EXTEND AS NEEDED TO ACCOMMODATE NEW WORK.



<u>\_1</u>\_\_\_\_

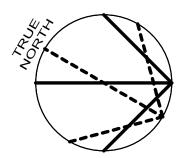

<b>DATE</b> 2024 04 23		UED FOR on Set Owners Review	REV
2024 04 25 2024 05 16 2024 06 06	Issued for 95%	CD Client Review	
2024 06 27 2024 07 31	Issued for Bid a Addendum #2	nd Building Permit	1
			1
STATE UNI	VERSITY and ther	ed solely for the use of W e are no representations	of any
entered into		rty with whom NORR ha	5 HUL
This drawing	shall not be used	for construction purpose	es until
		igned and dated by the A	
Project Com	ponent		
Key Plan	-		
Consultants			
Survey: Civil:			
Architectur Structural: Mechanica	NORR		
Structural: Mechanica Electrical: Interiors:	NORR I: NORR NORR NORR		
Structural: Mechanica Electrical:	NORR I: NORR NORR NORR		
Structural: Mechanica Electrical: Interiors: Landscape	NORR I: NORR NORR NORR		
Structural: Mechanica Electrical: Interiors: Landscape	NORR I: NORR NORR NORR	INS DISTO.	
Structural: Mechanica Electrical: Interiors: Landscape	NORR I: NORR NORR NORR	ONS DISTRIBUT	
Structural: Mechanica Electrical: Interiors: Landscape	NORR I: NORR NORR NORR	NS DISTRIBUTE	
Structural: Mechanica Electrical: Interiors: Landscape	NORR I: NORR NORR NORR	NS DISTRIBUTION DES A Schloffel # 102917	
Structural: Mechanica Electrical: Interiors: Landscape	NORR I: NORR NORR NORR	NS DISTRIBUTION DES Schloffel # 102917 S12-31-25	
Structural: Mechanica Electrical: Interiors: Landscape	NORR I: NORR NORR NORR	ONS DISTRIBUTION DES A Schloffel # 102917 \$12-31-25 CDD	
Structural: Mechanica Electrical: Interiors: Landscape	NORR I: NORR NORR NORR	NS D/S PHENINGES A Schloffel # 102917 S12-31-25	
Structural: Mechanica Electrical: Interiors: Landscape	NORR NORR NORR NORR Jeffrey M BICSI ID Expire R		
Structural: Mechanica Electrical: Interiors: Landscape	NORR I: NORR NORR NORR		
Structural: Mechanica Electrical: Interiors: Landscape Seal(s)	I: NORR NORR NORR NORR I: NORR NORR I: NORR I: NORR NORR I: NORR NORR I: NORR NORR I: NORR NORR I: NORR NORR I: NORR NORR I: NORR NORR I: NORR NORR I: NORR NORR II II II	R	
Structural: Mechanica Electrical: Interiors: Landscape Seal(s)	I: NORR NORR NORR NORR I: NORR NORR I: NORR II DI Jeffrey M BICSI ID Expire RI COR II US 48226	R	
Structural: Mechanica Electrical: Interiors: Landscape Seal(s) Seal(s)	I: NORR NORR NORR NORR I: NORR NORR I: NORR II DI Jeffrey M BICSI ID Expire RI COR II US 48226	R	
Structural: Mechanica Electrical: Interiors: Landscape Seal(s) Seal(s)	I: NORR NORR NORR NORR I: NORR NORR I: NORR II DI Jeffrey M BICSI ID Expire RI COR II US 48226	R	
Structural: Mechanica Electrical: Interiors: Landscape Seal(s) Seal(s)	I: NORR NORR NORR NORR I: NORR NORR I: NORR II DI Jeffrey M BICSI ID Expire RI COR II US 48226	R	
Structural: Mechanica Electrical: Interiors: Landscape Seal(s) Seal(s)	I: NORR NORR NORR NORR SI NORR Jeffrey M BICSI ID EXPIRE R ORR ( NORR SI SI SI SI SI SI SI SI SI SI SI SI SI	R	
Structural: Mechanica Electrical: Interiors: Landscape Seal(s) Seal(s)	I: NORR NORR NORR NORR NORR I: IIIIIIIIIIIIIIIIIIIIIIIIIIIIIIIII	R., Suite 1300	
Structural: Mechanica Electrical: Interiors: Landscape Seal(s) Seal(s) ISOW. J Detroit, M norr.com Project Mana Project Lead Client	I: NORR NORR NORR NORR NORR I: IIIIIIIIIIIIIIIIIIIIIIIIIIIIIIIII	R ., Suite 1300 Drawn PJB Checked	SITY
Structural: Mechanica Electrical: Interiors: Landscape Seal(s) Seal(s) ISOW. J Detroit, M norr.com Project Mana Project Lead Client	I: NORR NORR NORR NORR NORR I: IIIIIIIIIIIIIIIIIIIIIIIIIIIIIIIII	R ., Suite 1300 Drawn PJB Checked JDK	SITY
Structural: Mechanica Electrical: Interiors: Landscape Seal(s) Seal(s) ISOW. J Detroit, M norr.com Project Mana Project Lead Client	I: NORR NORR NORR NORR NORR I: IIIIIIIIIIIIIIIIIIIIIIIIIIIIIIIII	R ., Suite 1300 Drawn PJB Checked JDK	SITY
Structural: Mechanica Electrical: Interiors: Landscape Seal(s) Seal(s) ISEALS IN ISEALS ISEAL	I: NORR NORR NORR NORR NORR I: NORR Jeffrey M BICSI ID EXPIRE RI RI RI RI RI RI RI RI RI RI RI RI RI	R , Suite 1300 Drawn PJB Checked JDK	SITY
Structural: Mechanica Electrical: Interiors: Landscape Seal(s) Seal(s) Seal(s) ISO W. J Detroit, M norr.com Project Mana Project Lead Client WAY	I: NORR NORR NORR NORR NORR I: NORR Jeffrey M BICSI ID ExPIRE RI RI RI COR ICSI ID EXPIRE RI RI RI RI RI RI RI RI RI RI RI RI RI	R , Suite 1300 Drawn PJB Checked JDK TE UNIVERS	
Structural: Mechanica Electrical: Interiors: Landscape Seal(s) Seal(s) Seal(s) ISO W. J Detroit, M norr.com Project Mana Project Lead Client WAY	I: NORR NORR NORR NORR NORR I: NORR Jeffrey M BICSI ID ExPIRE RI RI RI COR ICSI ID EXPIRE RI RI RI RI RI RI RI RI RI RI RI RI RI	R , Suite 1300 Drawn PJB Checked JDK	
Structural: Mechanica Electrical: Interiors: Landscape Seal(s) Seal(s) Seal(s) ISOW. J Detroit, M norr.com Project Mana Project Lead Client WAY	I: NORR NORR NORR NORR NORR I: NORR Jeffrey M BICSI ID ExPIRE RI RI RI COR ICSI ID EXPIRE RI RI RI RI RI RI RI RI RI RI RI RI RI	R , Suite 1300 Drawn PJB Checked JDK TE UNIVERS	
Structural: Mechanica Electrical: Interiors: Landscape Seal(s) Seal(s) Seal(s) ISOW. J Detroit, M norr.com Project Mana Project Lead Client WAY Project Lead Client WAY	I: NORR NORR NORR NORR NORR NORR Jeffrey M BICSI ID ExPIRE R R ORR ORR MICHIGAN, US	R , Suite 1300 Drawn PJB Checked JDK TE UNIVERS	
Structural: Mechanica Electrical: Interiors: Landscape Seal(s) Seal(s) Seal(s) ISOW. J Detroit, M norr.com Project Mana Project Lead Client WAY Project Lead Client WAY	I: NORR NORR NORR NORR NORR NORR Jeffrey M BICSI ID EXPIRE RI RI COR ICSI ID EXPIRE RI RI RI COR ICSI ID EXPIRE RI RI RI COR ICSI ID EXPIRE RI RI RI RI RI RI RI RI RI RI RI RI RI	R , Suite 1300 Drawn PJB Checked JDK TE UNIVERS	
Structural: Mechanica Electrical: Interiors: Landscape Seal(s) Seal(s) Seal(s) ISOW. J Detroit, M norr.com Project Mana Project Lead Client WAY Project Lead Client WAY	I: NORR NORR NORR NORR NORR NORR Jeffrey M BICSI ID ExPIRE R R ORR ORR MICHIGAN, US	R , Suite 1300 Drawn PJB Checked JDK TE UNIVERS	
Structural: Mechanica Electrical: Interiors: Landscape Seal(s) Seal(s) Seal(s) ISOW. J Detroit, M norr.com Project Mana Project Lead Client WAY Project Lead Client WAY	I: NORR NORR NORR NORR NORR NORR Jeffrey M BICSI ID ExPIRE R R ORR ORR MICHIGAN, US	R , Suite 1300 Drawn PJB Checked JDK TE UNIVERS	
Structural: Mechanica Electrical: Interiors: Landscape Seal(s) Seal(s) Seal(s) ISOW. J Detroit, M norr.com Project Mana Project Lead Client WAY Project Lead Client WAY	I: NORR NORR NORR NORR NORR NORR Jeffrey M BICSI ID ExPIRE R R ORR ORR MICHIGAN, US	R , Suite 1300 Drawn PJB Checked JDK TE UNIVERS	
Structural: Mechanica Electrical: Interiors: Landscape Seal(s) Seal(s) Seal(s) ISOW. J Detroit, M norr.com Project Mana Project Lead Client WAY Project Lead Client WAY	I: NORR NORR NORR NORR NORR NORR Jeffrey M BICSI ID ExPIRE R R ORR ORR MICHIGAN, US	R , Suite 1300 Drawn PJB Checked JDK FEUNIVERS EGEOF NOVATION	
Structural: Mechanica Electrical: Interiors: Landscape Seal(s) Seal(s) Seal(s) ISOW. J Detroit, M norr.com Project Mana Project Lead Client WAY Project Lead Client WAY	INORR NORR NORR NORR NORR NORR NORR Jeffrey M BICSI ID ExPIRE RI BICSI ID ExPIRE RI OR RI OR NE STAT	R , Suite 1300 Drawn PJB Checked JDK FEUNIVERS EGEOF NOVATION	
Structural: Mechanica Electrical: Interiors: Landscape Seal(s) Seal(s) Seal(s) ISO W. J Detroit, N norr.com Project Mana Project Lead Client WAY Project Lead Client WAY Scale	I: NORR NORR NORR NORR NORR NORR NORR Jeffrey M BICSI ID ExPIRE RI BICSI ID EXPIRE RI RI RI COR RI COR NE STAT	R , Suite 1300 Drawn PJB Checked JDK FEUNIVERS EGEOF NOVATION	

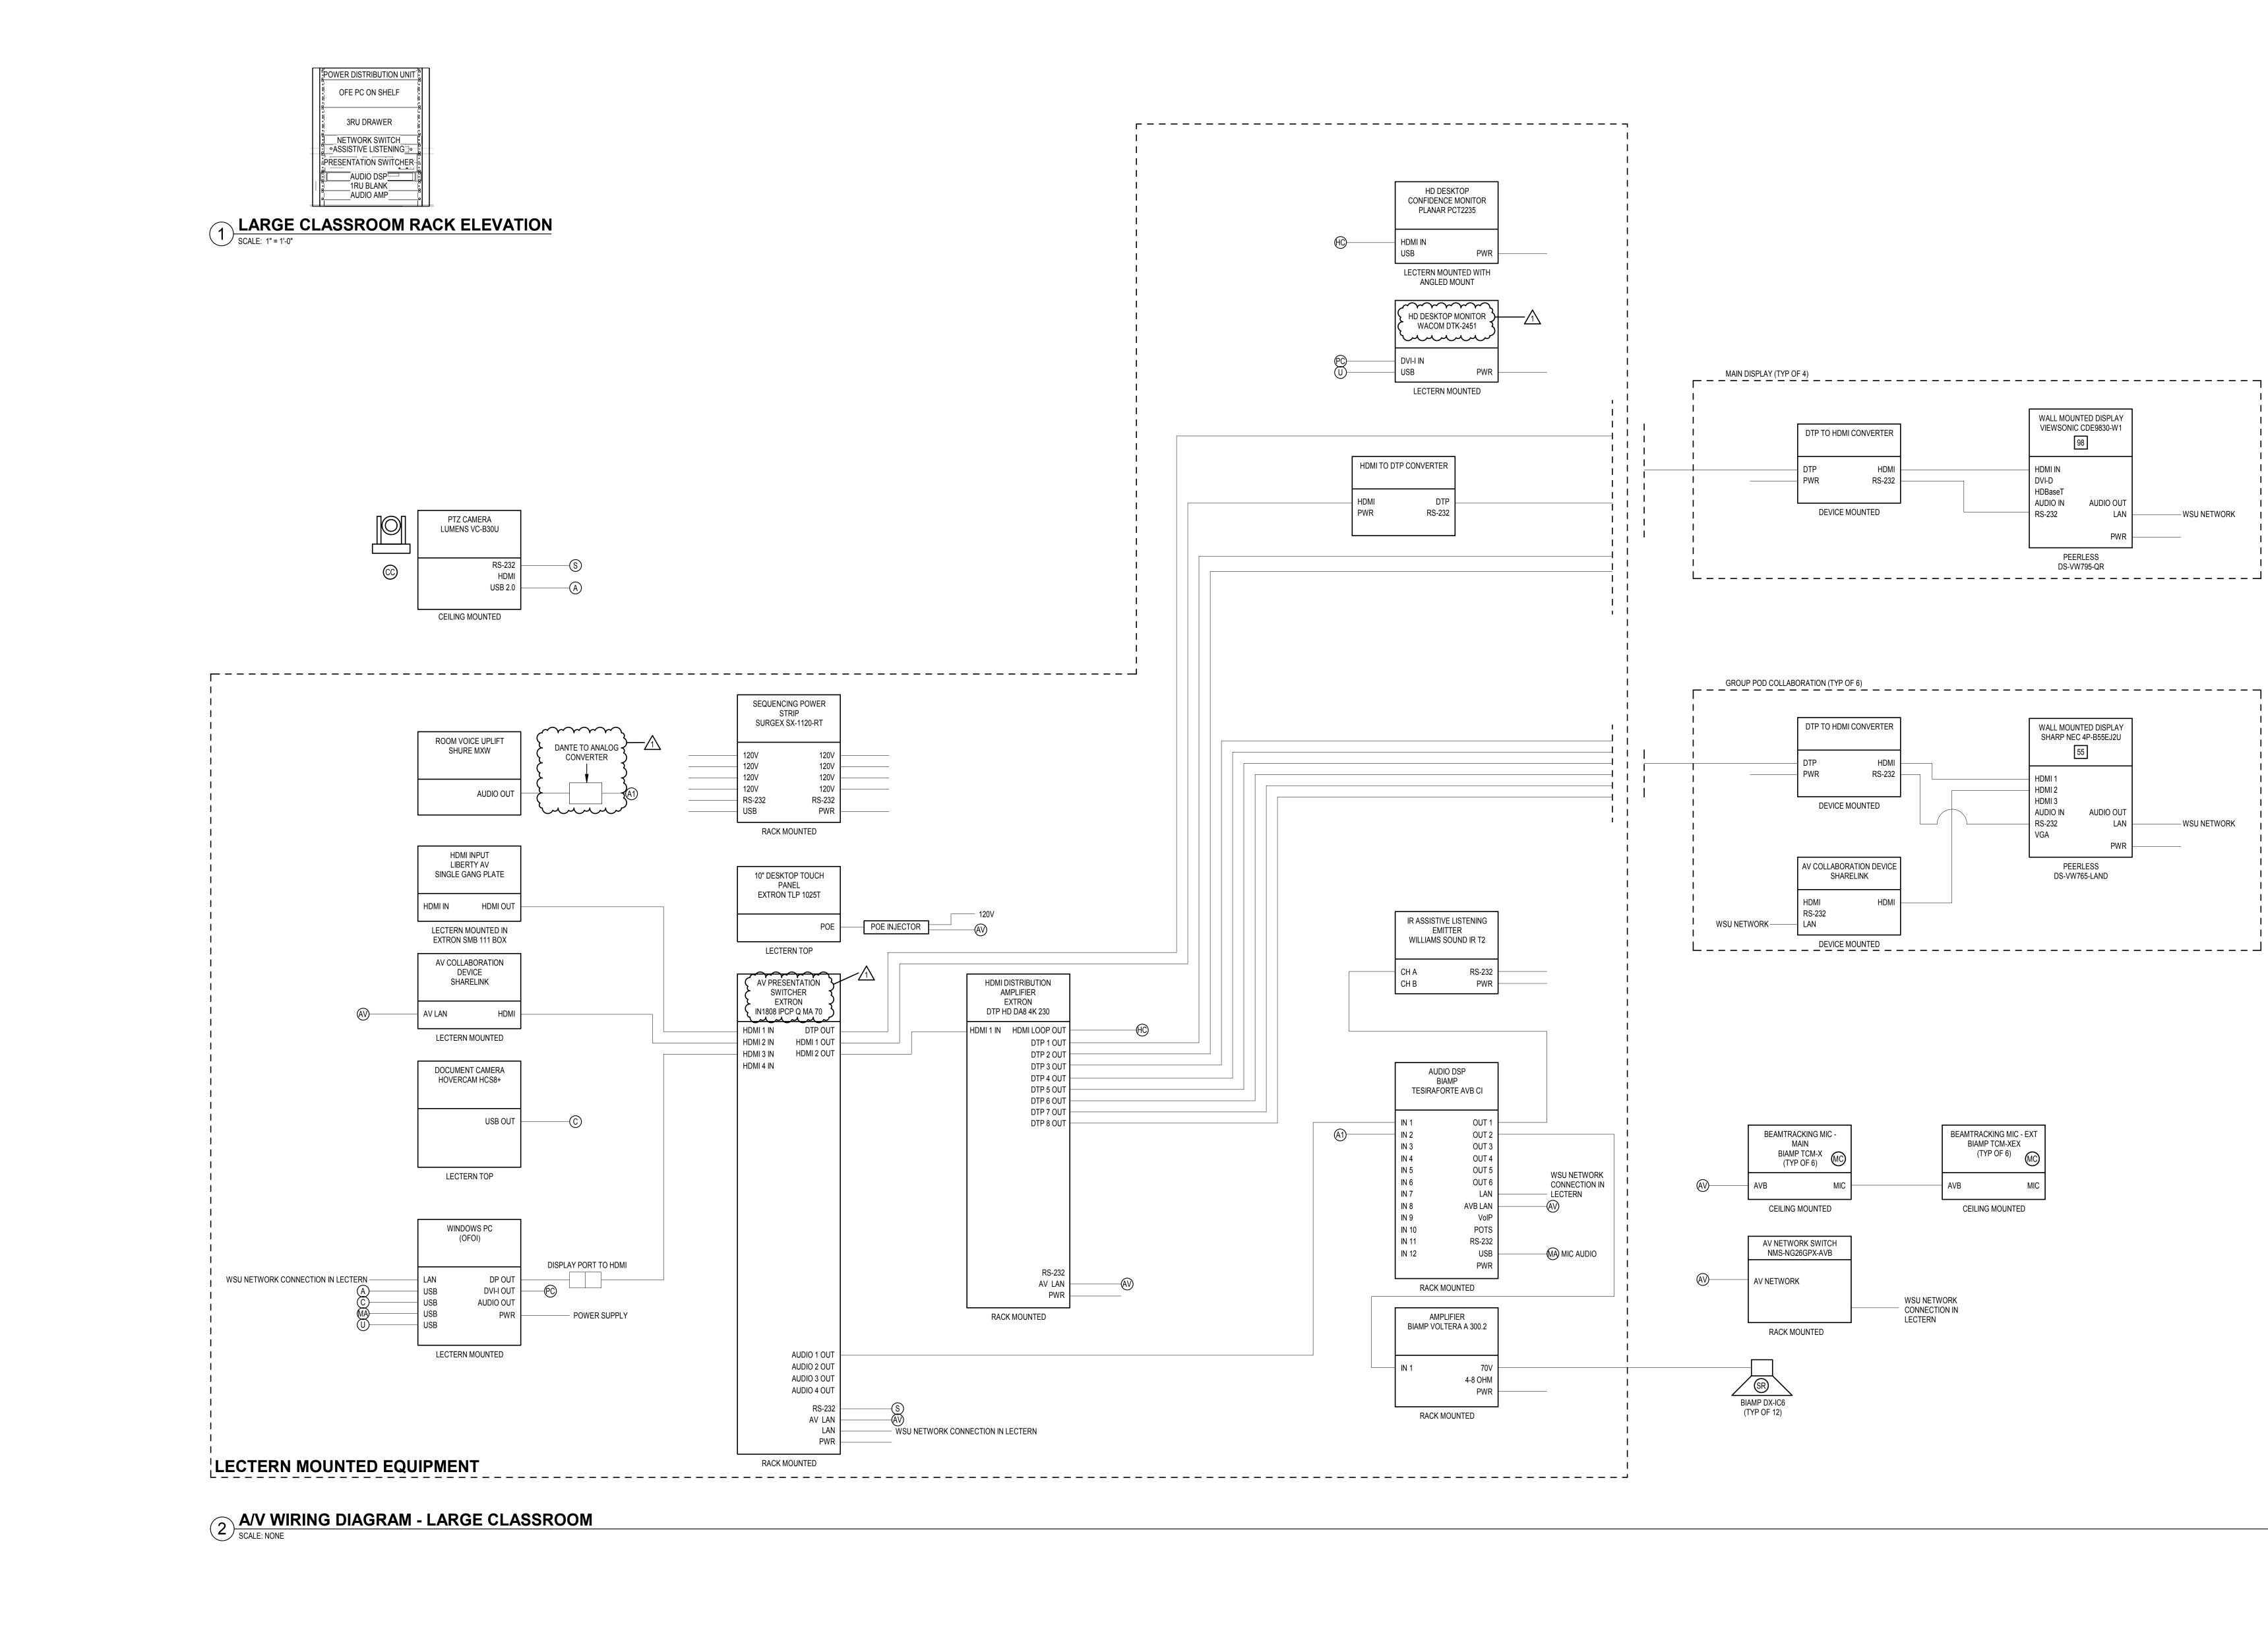


# **GENERAL NOTES**

A. AV DIAGRAMS ARE SCHEMATIC IN NATURE AND ARE INTENDED TO CONVEY GENERAL SIGNAL FLOWS ONLY.



		1
<b>DATE</b> 2024 04 23	ISSUED FOR 50% Construction Set Owners Review	REV
2024 05 16 2024 06 06	Issued for 95% CD Client Review Issued for 100% CD Client Review	
2024 06 27 2024 07 31	Issued for Bid and Building Permit Addendum #2	1
This drawing	has been prepared solely for the use of V	
STATE UNIV kind made by	ERSITY and there are no representations NORR to any party with whom NORR ha	s of any
entered into a	a contract.	
	shall not be used for construction purpose	
the seal appe or Engineer	earing hereon is signed and dated by the A	AT OT IITEC
Project Comp	ponent	
Key Plan		
,		
Consultants		
Survey: Civil: Architecture	: NORR	
Structural: Mechanical:	NORR	
Electrical: Interiors: Landscape:	NORR NORR	
Seal(s)		
	Jeffrey M Schloffel BICSI ID # 102917 Expires 12-31-25	
ć	Ricci	
FDC	Jeffrey M Schloffel	
460	BICSI ID # 102917	
	Expires 12-31-25	
	RCDD	
N	ORR	
Detroit, M	fferson Avenue., Suite 1300 I, US 48226	
norr.com		
Project Mana	ger Drawn	
	PJB	
Project Leade	JDK	
	NE STATE UNIVER	SIT
Project		
	- COLLEGE OF SING RENOVATION	c
NUK		J
	MICHIGAN, US	
Drawing Title	CHEMATIC - LARG	E
	SROOM	-
_		
Scale	As indicated	
Scale Project No.		
	As indicated ED2024-0063 <b>T50-03</b>	

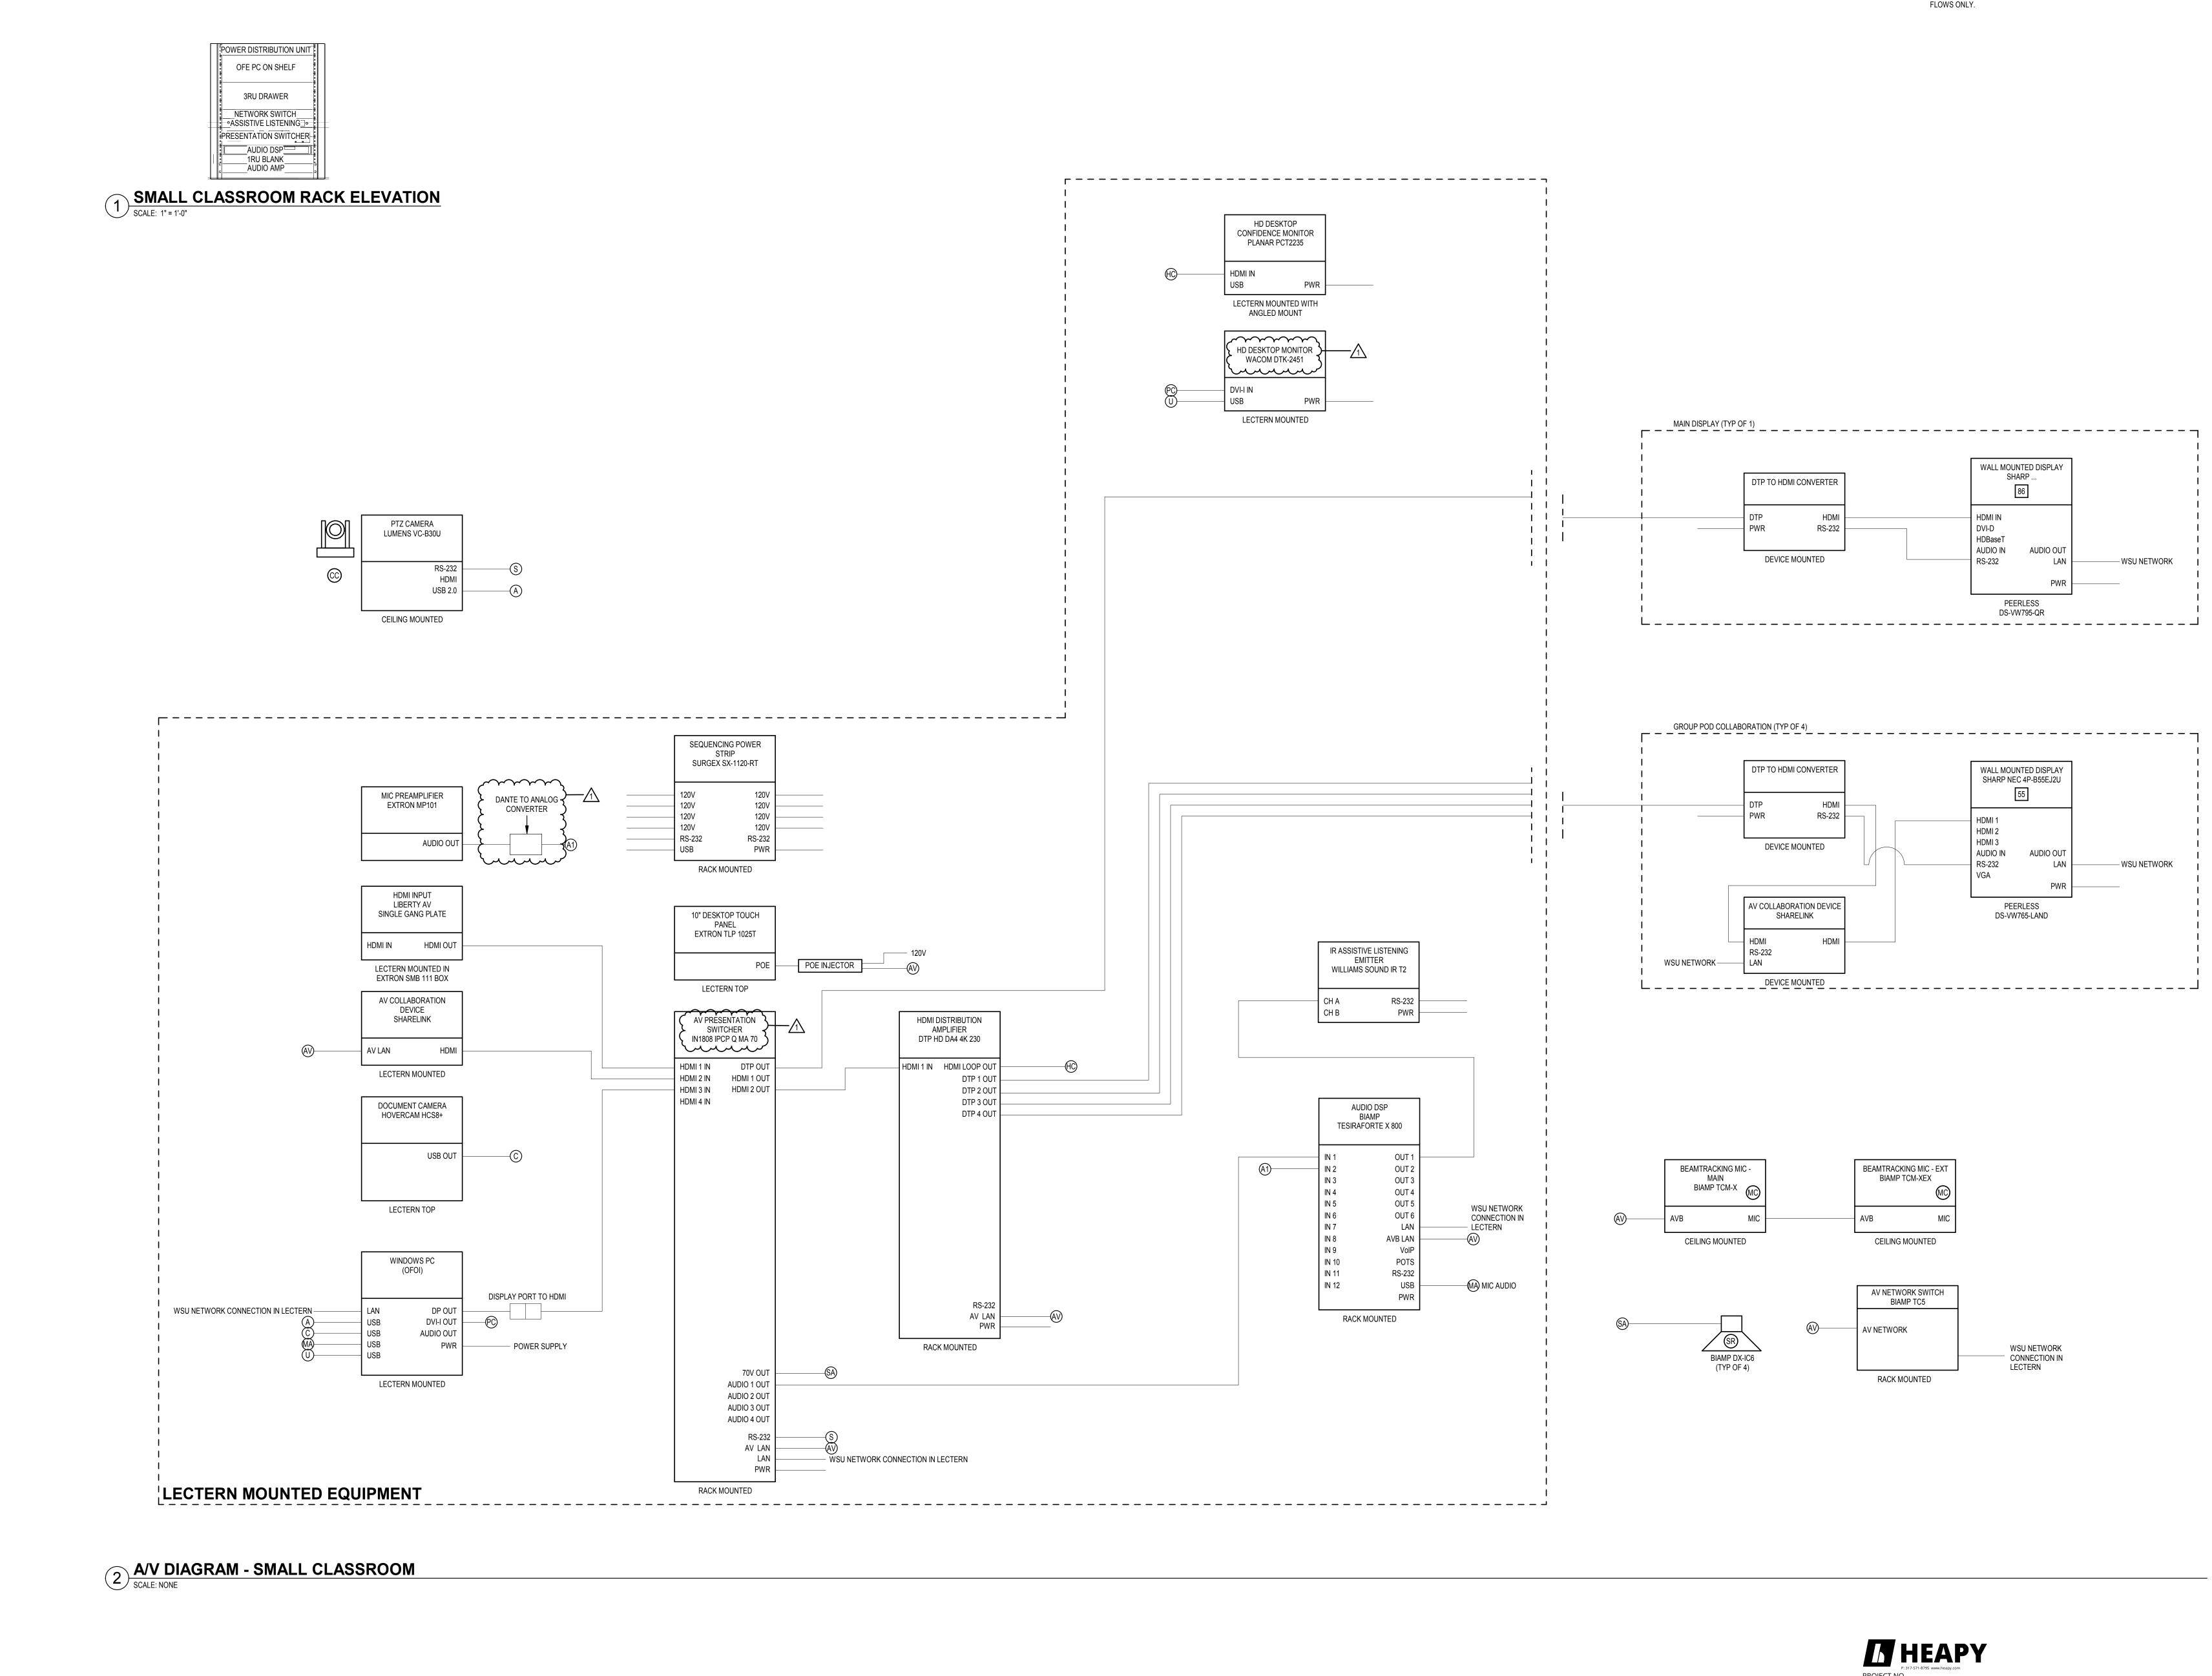

esk Docs://WSU - Nursing School Renovations/2024-91003-T-Central.rv

# **GENERAL NOTES**

A. AV DIAGRAMS ARE SCHEMATIC IN NATURE AND ARE INTENDED TO CONVEY GENERAL SIGNAL FLOWS ONLY.

DATE	ISSUED FOR REV
2024 04 23 2024 05 16	50% Construction Set Owners Review Issued for 95% CD Client Review
2024 06 06 2024 06 27 2024 07 31	Issued for 100% CD Client Review         Issued for Bid and Building Permit         Addendum #2       1
STATE UNIV kind made by	has been prepared solely for the use of WAYNE ERSITY and there are no representations of any NORR to any party with whom NORR has not
entered into a	a contract.
the seal appe	shall not be used for construction purposes until aring hereon is signed and dated by the Architect
or Engineer	
Project Comp	ionent
Key Plan	
Consultants	
Survey: Civil: Architecture	
Structural: Mechanical:	NORR NORR
Electrical: Interiors: Landscape:	NORR NORR
Seal(s)	Jeffrey M Schloffel BICSI ID # 102917 Expires 12-31-25
Ċ	MULTIN PIER
EDC	Jeffrey M Schloffel
760	BICSI ID # 102917
	RCDD
	אנשט
N	ORR
Detroit, M	fferson Avenue., Suite 1300 I, US 48226
norr.com	
Project Mana	ger Drawn PJB
Project Leade	er Checked JDK
Client	NE STATE UNIVERSITY
Project WSU	- COLLEGE OF
	SING RENOVATIONS
DETROIT,	MICHIGAN, US
Drawing Title	CHEMATIC - SMALL
	SROOM
I	
Scale	<b>.</b>
Scale Project No.	As indicated
	As indicated ED2024-0063 <b>T50-04</b>