MATTHAEI ACADEMIC RESOURCE CENTER RENOVATION

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ARCHITECT

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MECH/PLUMB/ELEC ENGINEER

MA ENGINEERING 180 HIGH OAK RD BLOOMFIELD HILLS, MI 48304 (248) 258-1610

PROJECT INFORMATION

WSU PROJECT NUMBER: 080-349977

PROJECT DESCRIPTION RENOVATION OF EXISTING ACADEMIC RESOURCE CENTER IN MATTHAEI BUILDING INTO STUDENT ATHLETE LOUNGE.

APPLICABLE CODES 2015 MICHIGAN REHABILITATION CODE FOR EXISTING BUILDINGS (MRC) 2015 MICHIGAN MECHANICAL CODE (MMC) 2015 MICHIGAN ENERGY CODE (MEC) 2013 ANSI/ASHRA/IES 90.1


2011 NATIONAL ELECTRICAL CODE (NEC) 2009 ICC A117.1

2015 NFPA 101 LIFE SAFETY CODE


BARRIER FREE REQUIREMENTS: 2010 ADA STANDARDS FOR ACCESSIBLE DESIGN (DOJ) MBC-2009, CHAPTER 11 ICC / ANSI 117.1 - 2006, EXCEPT SECTION 611 & 707

CHAPTER 3 - USE AND OCCUPANCY CLASSIFICATION ORIGINAL MATTHEI - EDUCATION: E 2012 ADDITION - BUSINESS: B

SHEET DESIGNATION

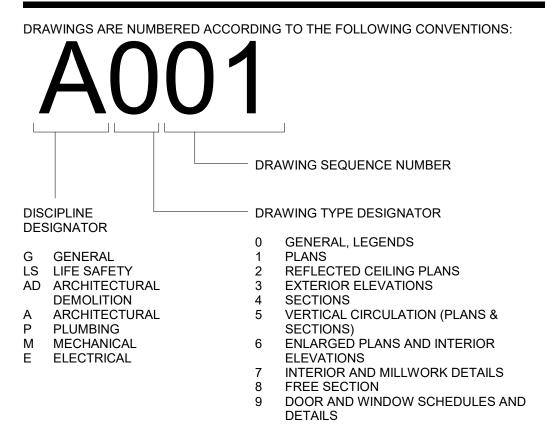

PROJECT AREA

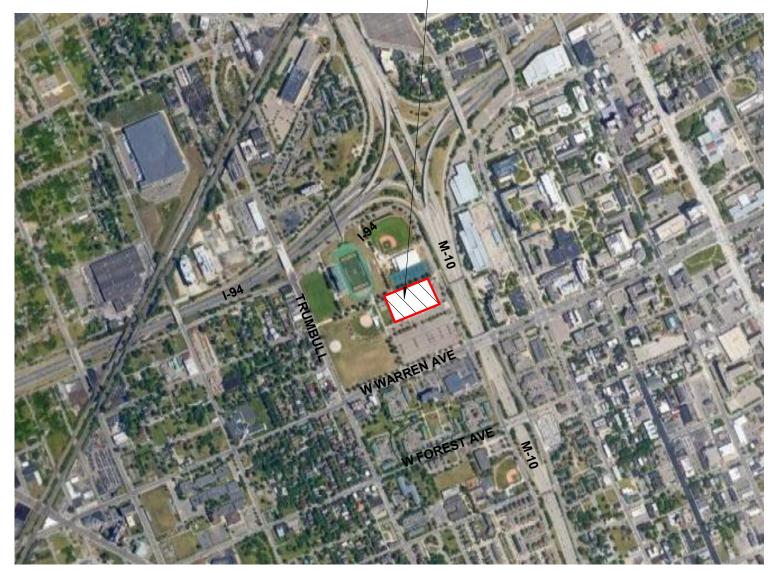

LOCATION MAP 6" = 1'-0"

	SHEET INDEX - GENERA	L	
DWG #	DRAWING NAME	ISSUED FOR	DATE
G001	COVER SHEET, GENERAL INFORMATION, DRAWING INDEX	BID / PERMIT	07.07.22
G002	STANDARD MOUNTING HEIGHTS, PARTITION TYPES AND DETAILS	BID / PERMIT	07.07.22
DRAWIN	GS: 2		
	SHEET INDEX - LIFE SAFE	ТҮ	

011011		ICCOLD I OIX	DATE
LS110	CODE INFORMATION AND FLOOR LIFE SAFETY PLAN - EGRESS	BFS RESPONSE	08.29.22
	PLANS		
DRAWING	S: 1		

	SHEET INDEX - ARCHITECTU	RAL	
DWG #	DRAWING NAME	ISSUED FOR	DATE
AD100	ARCHITECTURAL DEMOLITION PLANS	BULLETIN #1	08.24.22
A110	FIRST LEVEL NEW CONSTRUCITON AND RCP	BFS RESPONSE	08.29.22
A610	INTERIOR ELEVATIONS AND ENLARGED PLANS FIRST LEVEL	BFS RESPONSE	08.29.22
DRAWIN	GS: 3		

	SHEET INDEX - ME	ECHANICAL	
DWG #	DRAWING NAME	ISSUED FOR	DATE
M000	MECHANICAL SYMBOLS LIST, INDEX,	BID / PERMIT	07.07.22
M100 DEMOLITION & NEW WORK		BID / PERMIT	07.07.22
DRAWIN	GS: 2		

	SHEET INDEX - ELECTRICAL		
DWG#	DRAWING NAME	ISSUED FOR	DATE
E001	ELECTRICAL LEGEND, SHEET INDEX AND SPECIFICATION	BID / PERMIT	07.07.22
ED001	DEMOLITION PLANS	BID / PERMIT	07.07.22
E100	ELECTRICAL PLANS	BID / PERMIT	07.07.22
DRAWING	DRAWINGS: 3		

	SHEET INDEX - FIRE PROTECTI	ON	
DWG#	DRAWING NAME	ISSUED FOR	DATE
F100 FIRST LEVEL NEW WORK FIRE PROTECTION PLAN BID / PERMIT 07.		07.07.22	
DRAWING	DRAWINGS: 1		


THESE CONSTRUCTION DRAWINGS WERE PREPARED FOR COMPLIANCE WITH THE MICHIGAN CONSTRUCTION CODES IN EFFECT AT THE TIME OF PERMIT SUBMITTAL. ALL ENGINEERS, CONTRACTORS AND SUPPLIERS INVOLVED WITH THIS PROJECT SHALL COMPLY WITH THE SAME CODES, ISSUED AND APPROVED CODE MODIFICATIONS AND/OR CITY CODE AUTHORITY CONSTRUCTION BOARDS OF APPEALS RULINGS AND WHENEVER REQUIRED SHALL PROVIDE SHOP DRAWINGS AND SUBMITTALS CLEARLY DESCRIBING COMPLIANCE TO THE REGISTERED DESIGN PROFESSIONAL IN RESPONSIBLE CHARGE FOR REVIEW AND APPROVAL.

MATERIAL LEGE		S
	EARTH	
	SAND	
	GRAVEL FILL	
	CONCRETE	
	MASONRY	
	GROUT	
	MORTAR	
	STEEL	(
	STAINLESS STEEL	
	RIGID INSULATION	
	GYPSUM BOARD	F
	CEMENT BOARD	F
TYPICAL DETAI	L SYMBOLS	
Ĩ	STEEL MEMBER	_
I	SPRAY ON FIREPROOFING	
	HARDWOOD	
	PLYWOOD	
	CONTINUOUS BLOCKING	
	SHIM	_
	BATT INSULATION	

PARTITION PLAN DESIGNATIONS

	SMOKE SEPARATION
	1 HOUR FIRE SEPARATION
	2 HOUR FIRE SEPARATION
	3 HOUR FIRE SEPARATION
	METAL STUD PARTITION
	CMU PARTITION
A	CONCRETE WALL

SEALANT WITH BACKER ROD

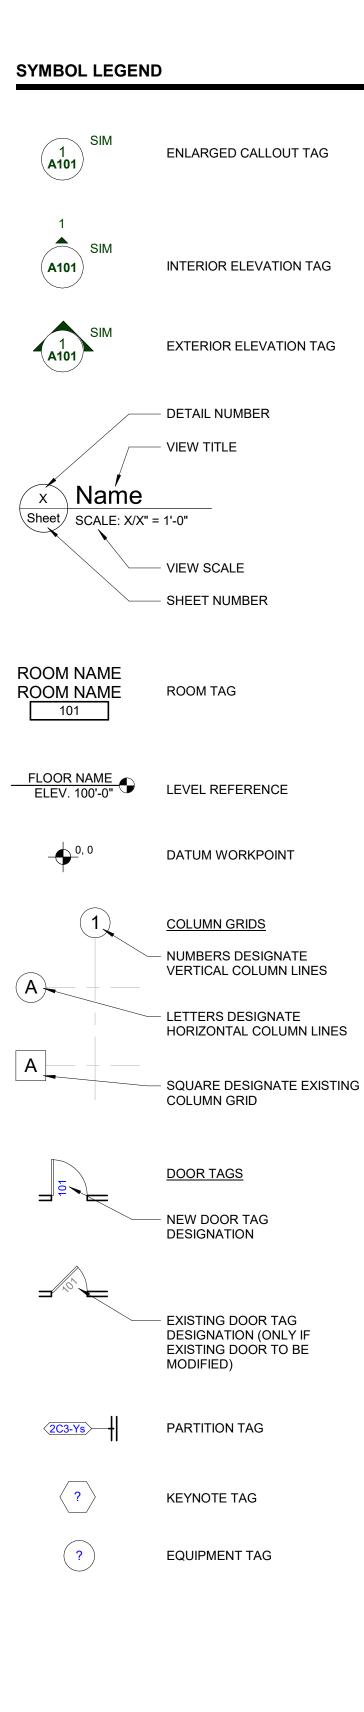

ABBREVIATION LEGEND

&	AND
بی	AT
100 ک	CENTERLINE
L ACCESS.	ACCESSIBILITY
ACOUS.	ACOUSTICAL
ACT	ACOUSTICAL CEILING TILE
A.D.	AREA DRAIN
ADJ	ADJUSTABLE
AL	ALUMINUM
ASPH.	ASPHALT
BD.	BOARD
BLDG.	BUILDING
BLK.	BLOCKING
BR	BRICK
CAB.	CABINET
CEM.	CEMENT
CER.	CERAMIC
CFMF	COLD FORMED METAL FRAMING
C.J.	CONTROL JOINT
CLG	CEILING
CLKG.	CAULKING
CLR.	CLEAR
COL.	COLUMN
CONC.	CONCRETE
CONT.	CONTINUOUS
CORR.	CORRIDOR
CPT	CARPET
D.F.	DRINKING FOUNTAIN
DET.	DETAIL
DIA.	DIAMETER
DIM.	DIMENSION
DN.	DOWN
D.O.	DOOR OPENING
DR.	DOOR
DWR.	DRAWER
D.S.	DOWN SPOUT
DSP	DRY STAND PIPE
DWG. EA	DRAWING
E.J.	EXPANSION JOINT
EL	ELEVATION
ELEC.	ELECTRICAL
	ELEVATOR EDGE OF SLAB
E.O.D./EOD EP	ELECTRICAL PANEL
EPX	EPOXY
EQ.	EQUAL
EQPM	EQUIPMENT
EXIST./EX	EXISTING
EXT.	EXTERIOR
FA	FIRE ALARM
FD	FLOOR DRAIN
FON	FOUNDATION
FE	FIRE EXTINGUISHER
FEC	FIRE EXTINGUISHER CABINET
FHC	FIRE HOSE CABINET
FIN	FINISH
FL	FLOOR
FPRF	FIREPROOF
FRP	FIBERGLASS REINFORCED PANEL
F.S.	FULL SIZE
FT.	FOOT OR FEET
FTG.	FOOTING
FUR	FURRING
GA.	GAUGE
GALV.	GALVANIZED
GFRC.	GLASS FIBER REINFORCED
GL.	CONCRETE GLASS
GYP.	GYPSUM
H.B.	HOSE BIBB
H.C.	HOLLOW CORE
HDWE	HARDWARE
HM	HOLLOW METAL
HORIZ.	HORIZONTAL
INSUL	INSULATION
JC	JANITOR'S CLOSET
LT	LIGHT
LVT	LUXURY VINYL TILE
MAX	MAXIMUM
MECH	MECHANICAL
MTL	METAL
MFR.	MANUFACTURER
MIN.	MINIMUM
MISC.	MISCELLANEOUS
M.O.	MASONRY OPENING
NIC	NOT IN CONTRACT
NTS	NOT TO SCALE
O/C	ON CENTER
OFC	OFFICE
OPP	OPPOSITE
PL	PLATE
PLAM	PLASTIC LAMINATE
PNT	PAINT
PLYWD	PLYWOOD
RD	ROOF DRAIN
RCP	REFLECTED CEILING PLAN
RQD	REQUIRED
SC	SOLID CORE
SCHED	SCHEDULE
SIM	SIMILAR
SPEC	SPECIFICATIONS
SQ	SQUARE
S.S.	STAINLESS STEEL
SS	SOLID SURFACE
ST	STONE
STD	STANDARD
STL	STEEL
STOR	STORAGE
SUSP	SUSPENDED
SYM	SYMMETRICAL
TRD	TREAD
T.O.C.	TOP OF CURB
T&G	TONGUE AND GROOVE
THK	THICK
T.O.P.	TOP OF PARAPET
TA	TOILET ACCESSORY
TV	TELEVISION
T.O.W. TOS/ T.O.S.	
TYP.	TYPICAL
U.N.O.	UNLESS NOTED OTHERWISE
VCT	VINYL COMPOSITION TILE
VERT.	VERTICAL
VEST	VESTIBULE
VF	VINYL FLOORING
W/	WITH
WB	WALL BASE
W.C.	WATER CLOSET
WC	WALLCOVERING
WD	WOOD
W/O	WITHOUT
WSCT.	WAINSCOT
WT.	WEIGHT



07.07.22

Drawn by : SVA

Checked by : JAV, MJB, AJD Sheet Title :


COVER SHEET, GENERAL INFORMATION, DRAWING INDEX

Project No.

2022.038


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Sheet No.

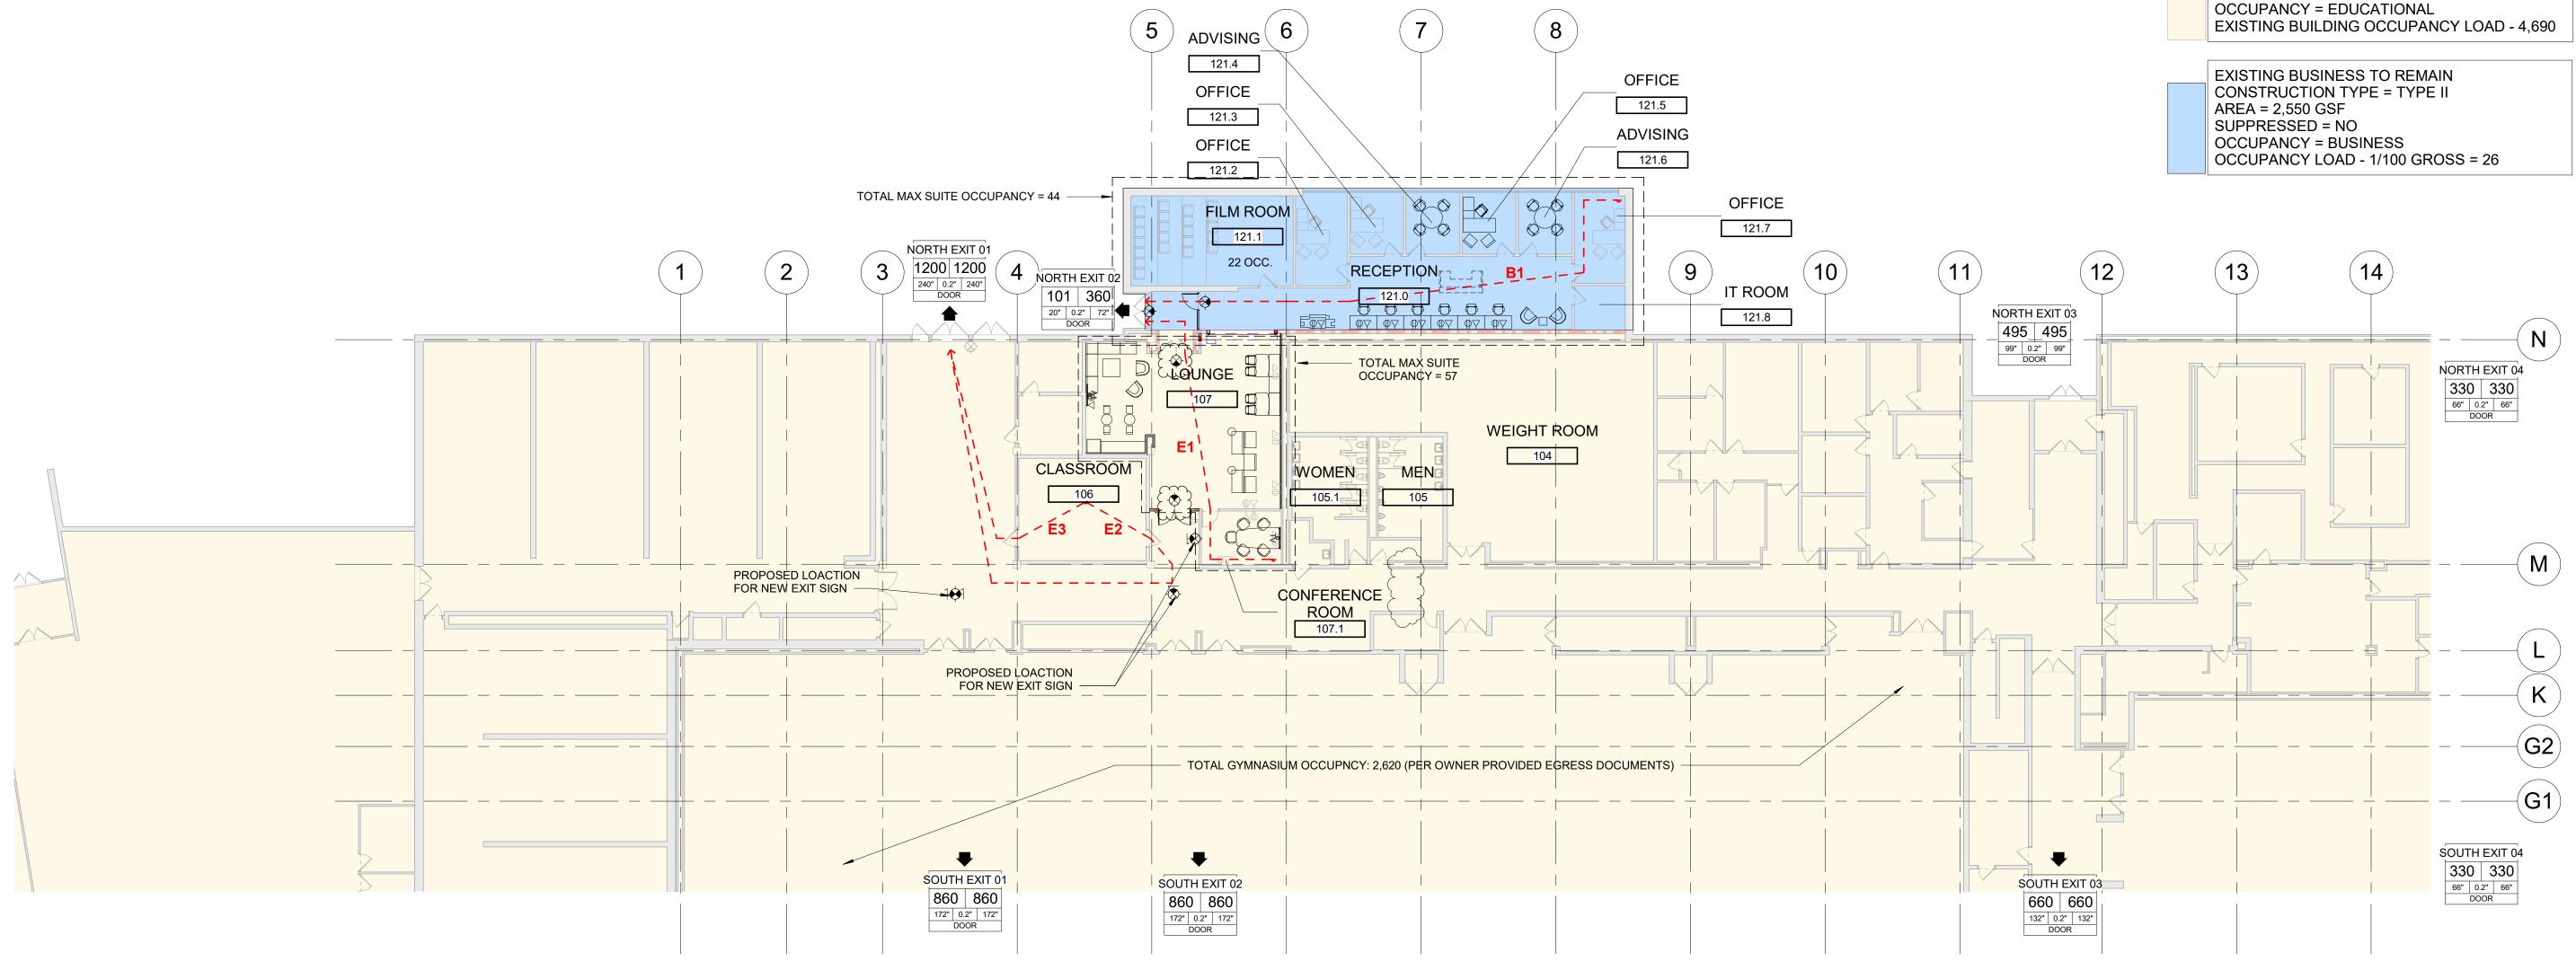

1 Level 1 Life safety LS110 1/16" = 1'-0"

LIFE SAFETY SYMBOL LEGEND

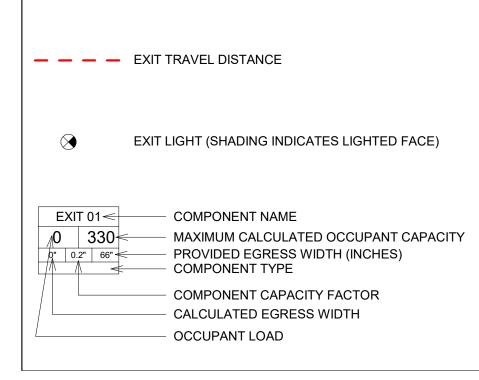

EGRESS TRAVEL DISTANCE SCHEDULE Egress Path Travel Distance 101' - 8" B1 63' - 8" E1 E2 101' - 0" E3 54' - 3"

EXISTING EDUCATIONAL BUILDING OCCUPANT LOAD = 4,690 EXISTING BUSINESS + EDUCATIONAL OCCUPANT LOAD = 101 TOTAL FACILITY OCCUPANT LOAD = 4,791

TOTAL OCCUPANT EGRESS CAPACITY PROVIDED = 5,095

> EXISTING EDUCATIONAL TO REMAIN CONSTRUCTION TYPE = TYPE II AREA = 108,500 SF SUPPRESSED = NO


EXISTING BUSINESS TO REMAIN CONSTRUCTION TYPE = TYPE II AREA = 2,550 GSF SUPPRESSED = NO OCCUPANCY = BUSINESS OCCUPANCY LOAD - 1/100 GROSS = 26
SUPPRESSED = NO OCCUPANCY = BUSINESS OCCUPANCY LOAD - 1/100 GROSS = 26




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SYMBOL D \bigcirc W/ \mathbb{H} W

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GENERAL RCP NOTES

- 1. CONTRACTOR TO CENTER ALL CEILING MOUNTED ITEMS (i.e., RECESSED LIGHT FIXTURES, SMOKE DETECTORS, FIRE SUPPRESSION HEADS) WITHIN THE ASSOCIATED CEILING TILE AS SHOWN. COORDINATE FINAL LOCATION WITH THE APPROPRIATE MECHANICAL, ELECTRICAL, FIRE ALARM, AND FIRE SUPPRESSION DRAWINGS AS REQUIRED.
- 2. CONTRACTOR SHALL VERIFY IN FIELD IF DESIGNATED CEILING HEIGHTS IN ROOMS AREA POSSIBLE. IF NOT, MAXIMIZE CEILING HEIGHTS AND NOTIFY ARCHITECT, ENGINEER OR PROJECT MANAGER OF ANY DISCREPANCY.
- 3. SPRINKLER HEADS SHOWN FOR REFERENCE ONLY, DESIGN-BUILD FIRE PROTECTION CONTRACTOR SHALL BE RESPONSIBLE FOR FINAL LOCATIONS, QUANTITY, TYPE AND FULL FIRE PROTECTION DESIGN. FIRE PROTECTION SYSTEM SHALL BE IN ACCORDANCE WITH ALL APPLICABLE LOCAL, STATE AND FEDERAL CODES AND BUILDING STANDARDS INCLUDING NFPA 101 LIFE SAFETY CODE (SPECIFICALLY CHAPTER 20).
- 4. CONTRACTOR SHALL PROVIDE ACOUSTIC SOUND BATT INSULATION ABOVE THE ENTIRE CEILING IN THE FOLLOWING ROOMS (TYPICAL UNO): TOILET ROOMS, OFFICES, RECEPTION AREAS, EXAM ROOMS AND CONFERENCE
- 5. CONTRACTOR TO PROVIDE DENS ARMOR PLUS WALL BOARD (MOISTURE RESISTANT) IN ALL CEILING AREAS AND WALLS OF TOILET ROOMS AND VESTIBULES (TYPICAL UNO).
- 6. ACCESS PANELS TO BE INDEPENDENTLY MOUNTED, DO NOT SUPPORT ON CEILING TILE GRID ASSEMBLY, SUPPORT FROM STRUCTURE ABOVE ONLY. COORDINATE SIZE, QUANTITY AND LOCATIONS WITH ARCHITECTURAL AND MECHANICAL DRAWINGS; IF NOT SHOWN, CONTRACTOR TO PROVIDE WHERE REQUIRED AND COORDINATE FINAL LOCATIONS IN FIELD WHERE REQUIRED PER MEP EQUIPMENT AND DRAWINGS.
- PROVIDE EXTERIOR MOUNTED EMERGENCY EGRESS LIGHT AT ALL EXTERIOR EXITS AS REQUIRED BY CODE, BATTERY BACK-UP AND MOUNTED 36" ABOVE DOOR UNO.
- 8. SOFFITS ABOVE UPPER CABINETS SHALL BE 16" DEEP AND SHALL BE CONSTRUCTED OF 5/8" GYPSUM BOARD ON 3 5/8" METAL FRAMING AT 16"
- 9. REFER TO WALL TYPES FOR WALLS THAT PENETRATE CEILINGS.
- 10. REFER TO MECHANICAL HVAC PLANS FOR DIFFUSER / GRILLE SIZES.
- 12. REFER TO DIMENSIONS ON REFLECTED CEILING PLAN TO LOCATE / LAYOUT CEILING GRID AND LIGHT FIXTURES.

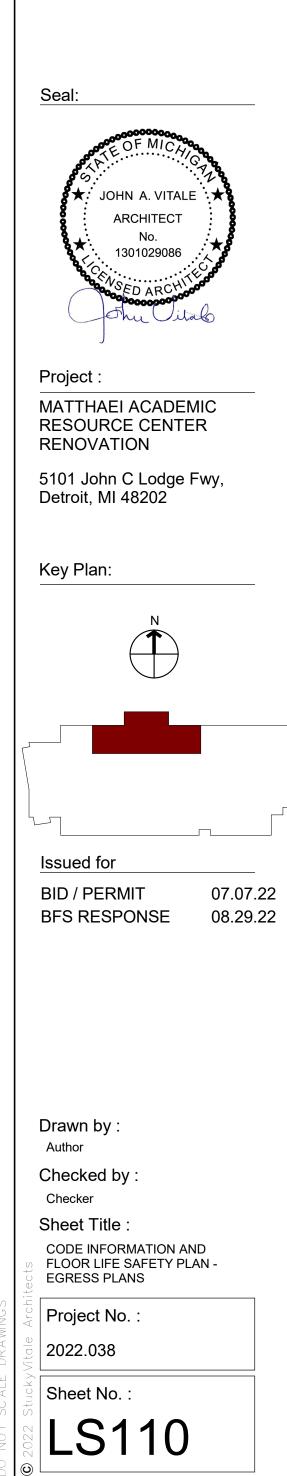RCP KEYNOTE LEGEND

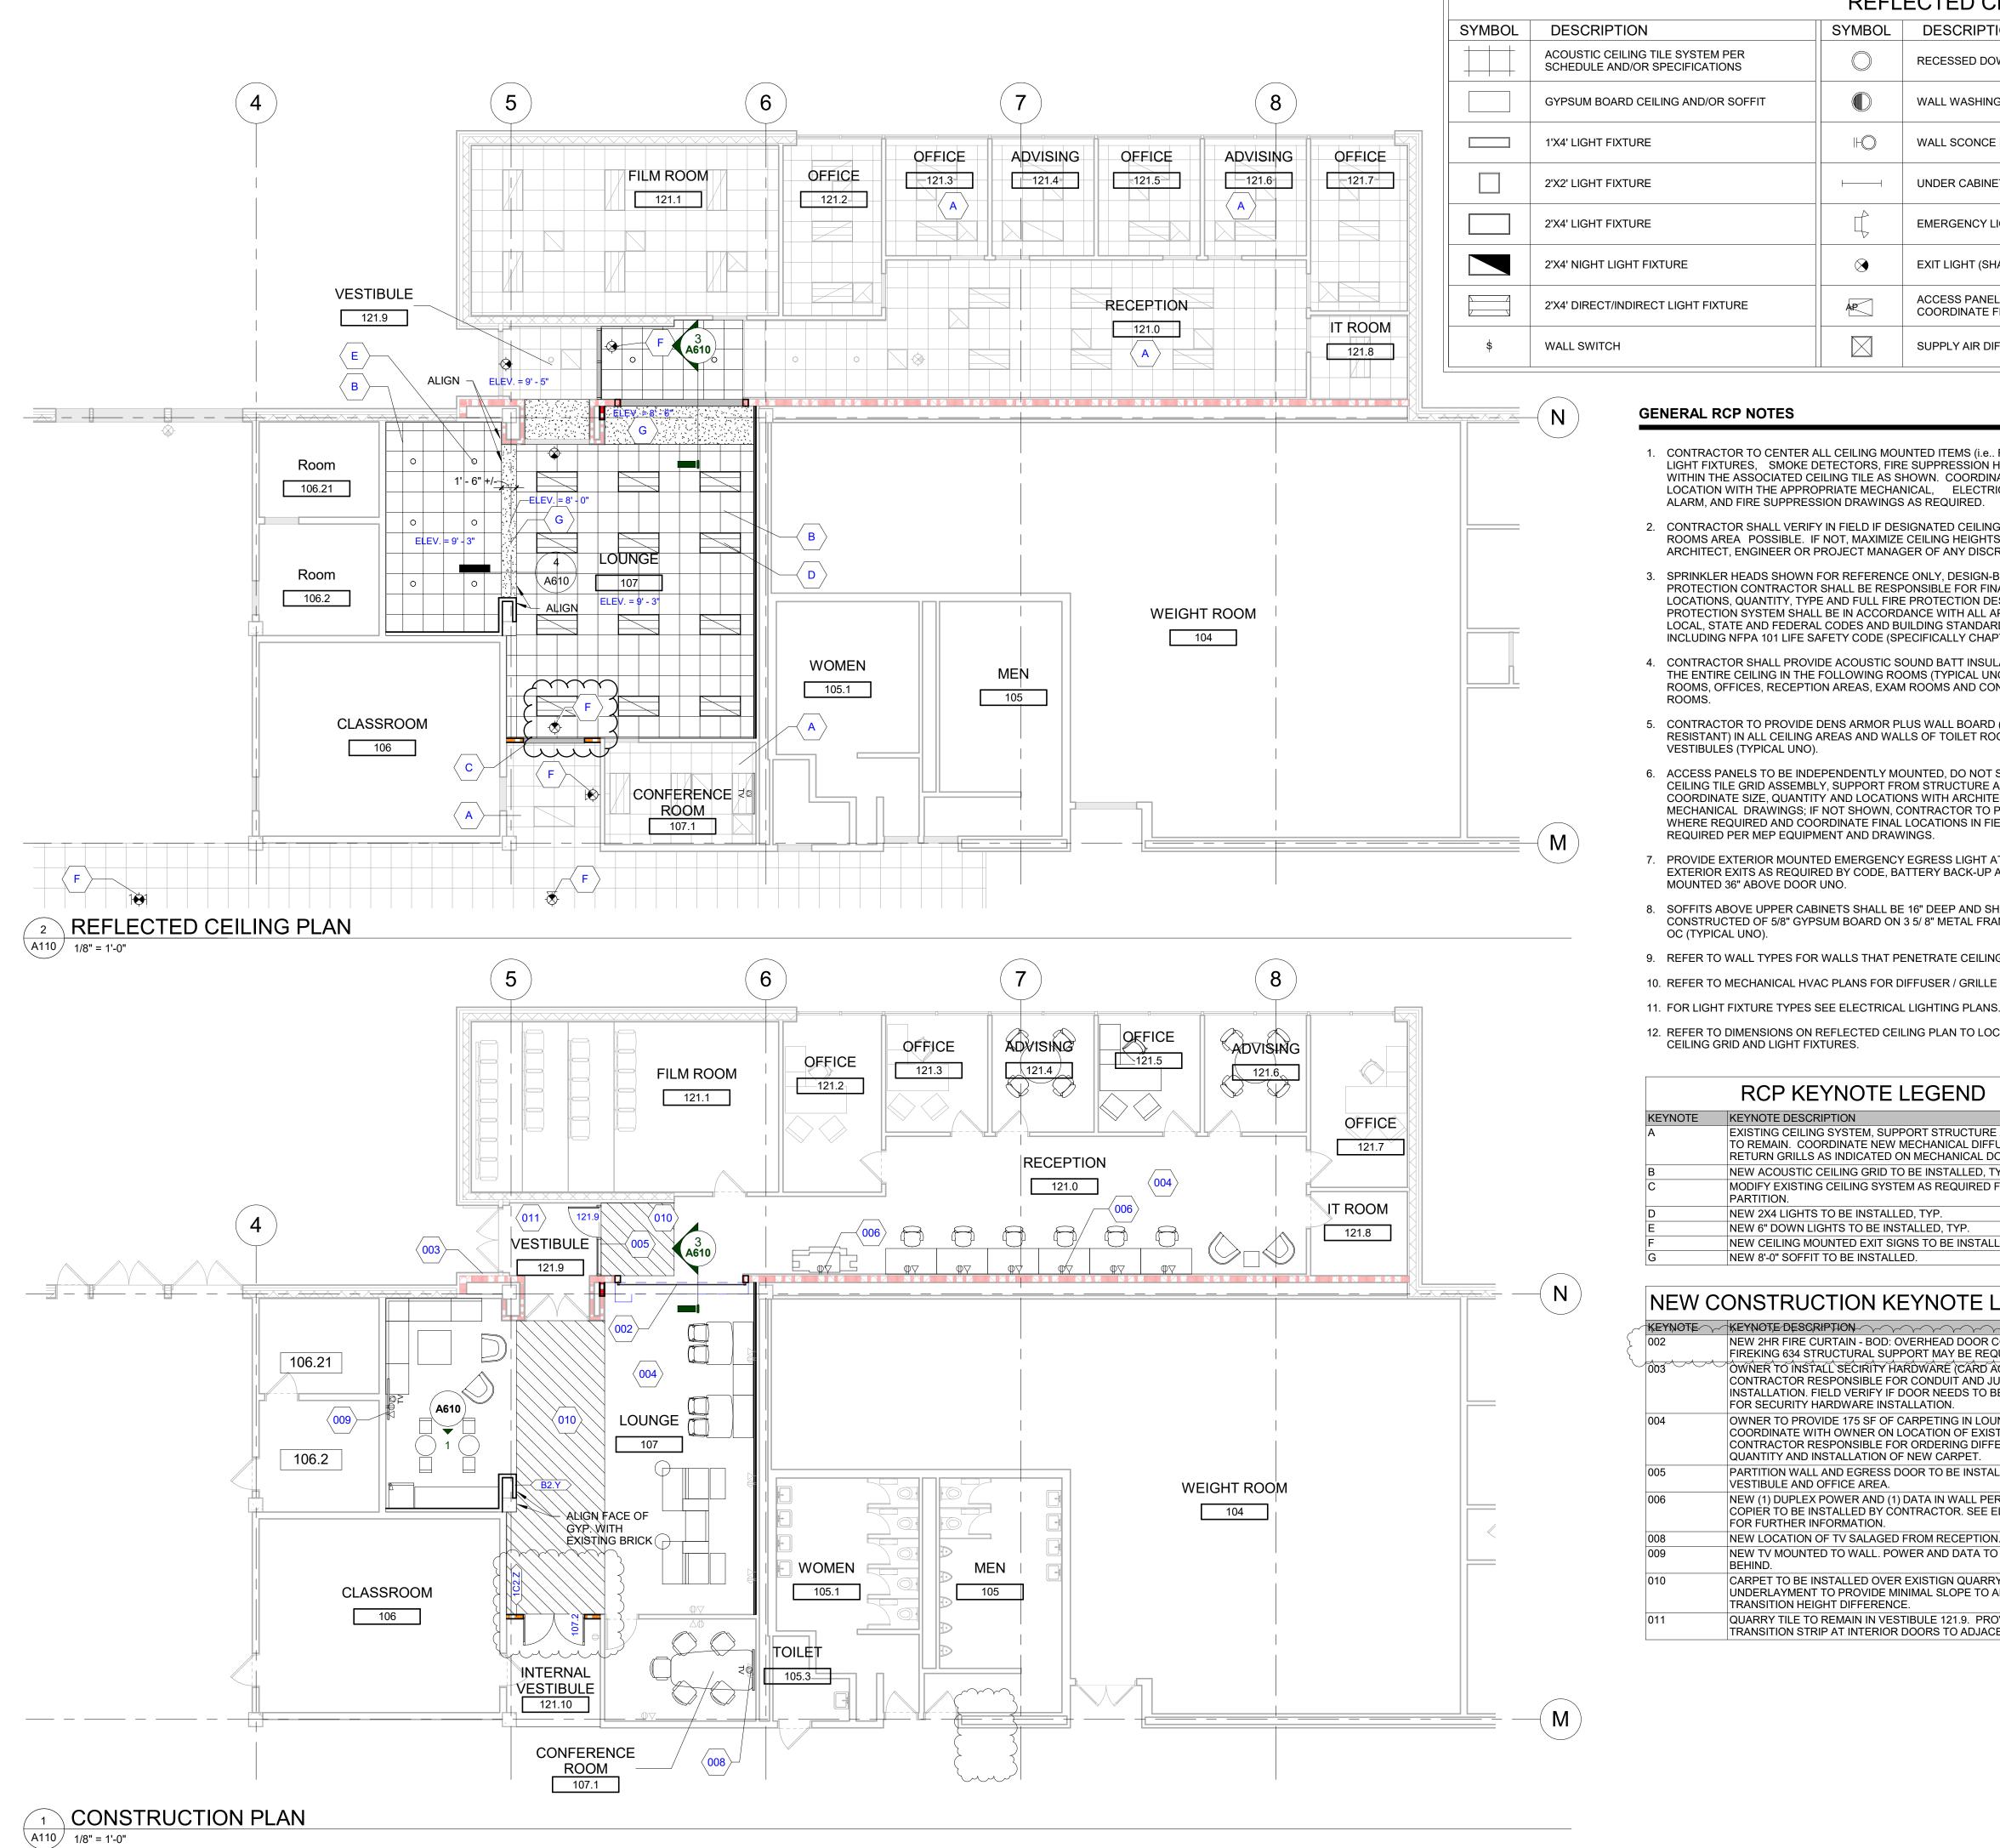KEYNOTE	KEYNOTE DESCRIPTION
A	EXISTING CEILING SYSTEM, SUPPORT STRUCTURE AND LIGHTS TO REMAIN. COORDINATE NEW MECHANICAL DIFFUSER AND RETURN GRILLS AS INDICATED ON MECHANICAL DOCUMENTS.
В	NEW ACOUSTIC CEILING GRID TO BE INSTALLED, TYP.
С	MODIFY EXISTING CEILING SYSTEM AS REQUIRED FOR NEW PARTITION.
D	NEW 2X4 LIGHTS TO BE INSTALLED, TYP.
E	NEW 6" DOWN LIGHTS TO BE INSTALLED, TYP.
F	NEW CEILING MOUNTED EXIT SIGNS TO BE INSTALLED.
G	NEW 8'-0" SOFFIT TO BE INSTALLED.

NEW CONSTRUCTION KEYNOTE LEGEND

KEYNOTE	KEYNOTE DESCRIPTION
002	NEW 2HR FIRE CURTAIN - BOD: OVERHEAD DOOR COMPANY FIREKING 634 STRUCTURAL SUPPORT MAY BE REQUIRED.
003	OWNER TO INSTALL SECIRITY HARDWARE (CARD ACCESS). CONTRACTOR RESPONSIBLE FOR CONDUIT AND JUNCTION BOX INSTALLATION. FIELD VERIFY IF DOOR NEEDS TO BE MODIFIED FOR SECURITY HARDWARE INSTALLATION.
004	OWNER TO PROVIDE 175 SF OF CARPETING IN LOUNGE. COORDINATE WITH OWNER ON LOCATION OF EXISTING CARPET. CONTRACTOR RESPONSIBLE FOR ORDERING DIFFERENCE IN QUANTITY AND INSTALLATION OF NEW CARPET.
005	PARTITION WALL AND EGRESS DOOR TO BE INSTALLED BETWEEN VESTIBULE AND OFFICE AREA.
006	NEW (1) DUPLEX POWER AND (1) DATA IN WALL PER DESK AND COPIER TO BE INSTALLED BY CONTRACTOR. SEE ELECTRICAL FOR FURTHER INFORMATION.
008	NEW LOCATION OF TV SALAGED FROM RECEPTION.
009	NEW TV MOUNTED TO WALL. POWER AND DATA TO BE INSTALLED BEHIND.
010	CARPET TO BE INSTALLED OVER EXISTIGN QUARRY TILE. SKIM UNDERLAYMENT TO PROVIDE MINIMAL SLOPE TO ADDRESS TRANSITION HEIGHT DIFFERENCE.
011	QUARRY TILE TO REMAIN IN VESTIBULE 121.9. PROVIDE TRANSITION STRIP AT INTERIOR DOORS TO ADJACENT CARPET.

REFLECTED CEILING LEGEND

DESCRIPTION	SYMBOL	DESCRIPTION
RECESSED DOWNLIGHT FIXTURE		RETURN AIR GRILL
VALL WASHING LIGHT FIXTURE		EXHAUST AIR GRILL
VALL SCONCE FIXTURE	Ś	SMOKE DETECTOR
JNDER CABINET LIGHT FIXTURE	۲	FIRE SUPPRESSION HEAD
EMERGENCY LIGHT FIXTURE W/ BATTERY SUPPLY	S	SPEAKER
EXIT LIGHT (SHADING INDICATES LIGHTED FACE)	+ HEIGHT	ELEVATION ABOVE FINISHED FLOOR
ACCESS PANEL - COORDINATE FINAL LOCATION WITH MEP	E	EXISTING FIXTURE TO REMAIN
SUPPLY AIR DIFFUSER	R	EXISTING FIXTURE TO BE RELOCATED

GENERAL PLAN NOTES

- 1. THIS DRAWING IS DIAGRAMMATIC AND SHOULD BE USED TO DETERMINE THE DESIGN INTENT. THE CONTRACTOR IS RESPONSIBLE FOR THE COMPLETE SET OF WORK AS INDICATED AND SHALL FIELD VERIFY ALL WORK, COORDINATE ALL DRAWINGS / NEW WORK AND SHALL NOTIFY ARCHITECT IMMEDIATELY OF ANY DISCREPANCIES IN THE DOCUMENTS BEFORE PROCEEDING, FAILURE TO DO SO WILL RESULT IN THE CONTRACTOR TAKING FULL RESPONSIBILITY AND LIABILITY FOR SAID DISCREPANCIES.
- 2. ALL DIMENSIONS ARE SHOWN FROM FINISH FACE TO FINISH FACE OF PARTITION UNLESS OTHERWISE NOTED.
- 3. WALL THICKNESS' ARE NOMINAL NOT ACTUAL DIMENSIONS. SEE WALL SCHEDULE FOR ACTUAL DIMENSIONS.
- 4. ALL WOOD, INCLUDING BLOCKING, USED ON THE PROJECT SHALL BE FIRE RETARDANT TREATED.
- 5. ALL WORK SHALL BE DONE IN ACCORDANCE WITH ALL LOCAL, STATE, COUNTY CODE REGULATIONS, O.S.H.A., AND THE AMERICAN WITH DISABILITIES ACT (ADA). REFER TO THE CODE PLAN FOR MORE INFORMATION.
- 6. PROVIDE POSITIVE SLOPE TO ALL FLOOR DRAINS WHILE KEEPING FLOOR LEVEL AT WALL BASE CONDITION.
- 7. PROVIDE TRANSITION STRIPS AT EACH CHANGE IN FLOOR FINISH MATERIALS.
- 8. PAINT, PATCH AND REPAIR THE FOLLOWING TO MATCH EXISTING MATERIALS: FLOOR, WALL, AND CEILING SURFACES AS REQUIRED ADJACENT TO AREAS BEING DEMOLISHED. REFER TO DEMOLITION DRAWINGS FOR MORE INFORMATION.
- 9. REINFORCE WALL AND PROVIDE BLOCKING AS REQUIRED TO SUPPORT WALL CABINETS AND COUNTERTOPS.
- 10. THE CONTRACTOR SHALL PROVIDE AND INSTALL WALL REINFORCING FOR INSTALLATION OF ACCESSORIES, COAT RACKS, CHART RACKS, CASEWORK, AND OTHER WALL MOUNTED ITEMS.
- 11. CLEAN AND REPAIR ALL EXISTING FLOOR FINISHES AS NECESSARY.
- 12. ALL EXPOSED PIPES, DUCTS, AND CONDUIT TO BE PAINTED TO MATCH EXISTING.
- INTS IN GYPSUM BOARD PARTITIONS AT 30'-0" O.C. 13. PROV ATED IN THE CONTRACT DOCUMENTS. MAXI
- 14. COOF NER'S EQUIPMENT SUPPLIER FOR INSTALLATION REQUIREMENTS / LOCATIONS OF FLOOR / WALL / CEILING MOUNTED ITEMS; IE. CAMERAS, TV'S, SPEAKERS, SENSORS, SECURITY WIRING, VAULTS, ATM'S.
- 15. CONTRACTOR SHALL CONDUCT A ROUGH ELECTRICAL INSPECTION WITH OWNER, PRIOR TO ENCLOSING WALLS, FOR THE PURPOSE OF CONFIRMING ALL J-BOX LOCATIONS FOR POWER, DATA, VOICE, SWITCH, THERMOSTAT, FTC
- 16. CONTRACTOR TO FILL ANY AND ALL EQUIPMENT PENETRATIONS OR DEPRESSIONS INTO OR THROUGH THE EXISTING SLAB THAT WILL NOT BE UTILIZED TO FEED NEW EQUIPMENT (I.E. ABANDONED FLOOR CORES, IMPRESSION FROM PREVIOUS EQUIPMENT FLOOR PLATE REMOVAL). PENETRATIONS SHALL BE FILLED WITH NON- SHRINK GROUT. THE SIDES OF ANY EXISTING OPENINGS SHALL BE MODIFIED/TAPERED SO THAT THEY ARE WIDER AT THE TOP THAN AT THE BOTTOM. FOR LARGE OPENINGS, PROVIDE ONE (1) #5 BAR 2" UP FROM BOTTOM OF HOLE.
- 17. A TACTILE SIGN STATING 'EXIT' AND COMPLYING WITH ICC-A117.1 SHALL BE PROVIDED ADJACENT TO EACH DOOR TO AN 'AREA OF REFUGE', AN EXTERIOR AREA FOR ASSISTED RESCUE, AN EXIT STAIRWAY, AN EXIT RAMP, AN EXIT PASSAGEWAY, AND THE EXIT DISCHARGE.
- 18. PROVIDE PERMANENT MIN 3-INCH HIGH CONTRASTING COLOR MARKING AND IDENTIFICATION AT ALL FIRE WALLS, FIRE BARRIERS, FIRE PARTITIONS, SMOKE BARRIERS, SMOKE PARTITIONS OR ANY OTHER WALL REQUIRED TO HAVE PROTECTED OPENINGS OR PENETRATIONS WITHIN 15 FEET AT THE END OF EACH WALL, AND NOT EXCEEDING 30 FEET MAXIMUM HORIZONTAL INTERVALS, MINIMUM 2 LOCATIONS EACH WALL. TYPICAL FOR ACCESSIBLE CONCEALED FLOOR, FLOOR-CEILING, OR ATTIC SPACES PER CODE (MBC 703.7)
- 19. CONTRACTOR TO COORDINATE WITH FURNITURE VENDOR ON FURNITURE SPECIFICATIONS, LAYOUT, AND INSTALL



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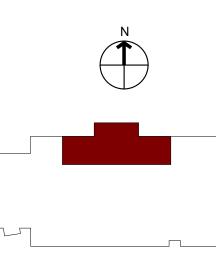


Project :

MATTHAEI ACADEMIC RESOURCE CENTER RENOVATION

5101 John C Lodge Fwy, Detroit, MI 48202

Key Plan:



Issued for

BID / PERMIT BULLETIN #1 BFS RESPONSE

07.07.22 08.24.22 08.29.22

Drawn by : ARR

Checked by ARR

Sheet Title :

FIRST LEVEL NEW CONSTRUCITON AND RCP

Project No.

2022.038

Sheet No.


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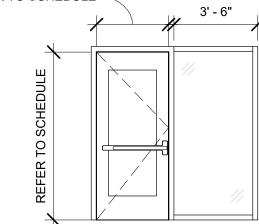
	JRAL CASEWORK			OF MATE		099	10 - PA	INT	
PL-1 PLASTIC LAMINA MANUFACTUREI MODEL:STANDA PRODUCT #: 155 COLOR: CHARCO FINISH: TRACEL LOCATION: REFI	R: WILSONART RD HPL 504 OAL VELVET	EXACT	CT-1 CARPET MANUFACTURER: MATCH EXISTING COLOR: STEEL MATCH EXISTING LOCATION: LOUNGE RB-1 RUBBER WALL BASE MANUFACTURER: PORPE				M/ CC FII LC	ITERIOR I ANUFAC OLOR: RE NISH: EG DCATION DCATION	
CONTACT:			MANUFACTURER: ROPPE COLOR: LUNAR DUST 114 SIZE: 4 1/4"h, 1/4" THICK (USE 8' LENGTHS, NOT COIL)			1500	 00 - EL'		
09510 - SUSPENDED	ACOUSTICAL CEI	LING	LOCÁT	ION: LVT & CPT, REFER DCATION. CT:	TO FINISH PLAN			ACE PLA ⁻ OLOR: S ⁻	
ACT-1 ACOUSTIC CEILI MANUFACTURE COLLECTION: UI	R: ARMSTRONG					-	DI	EVICES	
COLOR: WHITE SIZE: 2 X 2 EDGE: SQUARE	LAY IN EDGE KEEP EXISTING (WARRE	N)				1200		MULATE	
LOCATION: SEE	RCP FOR MORE DETAIL	,				SS-1	SI	IMULATE	
							M Pl C	IANUFAC IODEL: Q RODUCT OLOR: G HICKNES	
				FINISH SCHEDU					
RM # ROOM NAME 107 LOUNGE	FLOOR FINISH CT-1 - SEE NOTE 004 ON SHEET A110	BASE FINISH RB-1	NORTH WALL MATCH RECEPTION	EAST WALL MATCH RECEPTION	SOUTH WALL MATCH RECEPTION	WEST W MATCH RECE		REMARI	
107.1CONFERENCE ROOM121.0RECEPTION	EXIST'G TO REMAIN EXIST'G TO REMAIN	EXIST'G TO REMAIN EXIST'G TO REMAIN	PATCH AND RE-PAINT AS NECESSARY	PATCH AND RE-PAINT AS NECESSARY	PATCH AND RE-PAINT AS	PATCH AND RE-PAINT AS			
121.4 ADVISING	EXIST'G TO REMAIN	EXIST'G TO REMAIN	EXIST'G TO REMAIN	EXIST'G TO REMAIN	NECESSARY EXIST'G TO REMAIN	EXIST'G TO F			
121.6 ADVISING 121.9 VESTIBULE	EXIST'G TO REMAIN	EXIST'G TO REMAIN EXIST'G TO	EXIST'G TO REMAIN	EXIST'G TO REMAIN	EXIST'G TO REMAIN	EXIST'G TO F	REMAIN		
121.10 INTERNAL VESTIBULE		REMAIN EXIST'G TO REMAIN	MATCH EXIST'G CORRIDOR	MATCH EXIST'G CORRIDOR	N/A	MATCH EXIS	T'G		
CONTRACTOR SHALL VER EXISTS DIFFERS FROM TH ALL WORK TO COMPLY W REQUIREMENTS OF ICC/A ALL WORK SHALL MEET T CLEARANCES, LIMITATION THESE DRAWINGS ARE PI CONTRACTED. THE ARCH WILL RESULT IN COMPLET ALL DOORS REQUIRED TO PROVIDED WITH APPROV ALL DESIGNATED EXIT DO FURNISH HARDWARE AS S CONFERENCE AND KEY S KEYS FOR EACH LOCKING	AT WHICH IS SHOWN O ITH CURRENT FEDERAL NSI A117.1 AND THE AMI HE MOST STRINGENT RI IS, ACCESSORIES, ETC. REPARED IN ACCORDAN HITECT MAKES NO REPR FE COMPLIANCE WITH T D BE LABELED SHALL BE ED SELF-CLOSING DEVIC OORS SHALL BE EQUIPPE SCHEDULED WITHOUT S S, COMBINATED IC CORE YSTEM SCHEDULE. WH G DEVICE SPECIFIED; PLU	N DRAWINGS. , STATE AND LO ERICANS WITH E EQUIREMENTS (ICE WITH THE LI ESENTATION THE ADA. SET IN LABELEI CES AND POSITI ED WITH THE RE GUBSTITUTION, N ES AND KEYS; KE ERE "PDQ2" IS IN JS SIX MASTER	CAL CODES, LAWS ANI DISABILITIES ACT (ADA) DF BOTH INCLUDING, B MITED SERVICES FOR IAT THE INTERPRETAT D FRAMES AND IDENTII VE LATCHING HARDWA QUIRED EGRESS HARI NO ALTERNATES WILL I EYED TO MASTER SYST NDICATED, FURNISH A KEYS AND TWO CONTI	D ORDINANCES. THE ARE TO BE FULLY SATION WHICH THE ARCHITECT ION OF THESE DOCUME FIED WITH UL LABEL AN ARE. DWARE. BE APPROVED. FEM. INCLUDE KEY KEYED CORE AND TWO ROL KEYS.	ISFIED. F WAS ENTS ID BE	6 1 2 2 <u>Hardw</u> 3 1 1 1 2 1 1	ea. set ea. ea. ea. ea. ea. ea. ea. ea. ea.	Butt Hin Custom Push Ba Closer 7 2 – Rim Pa (Require Butt Hin Rim Pa Mortise Rim Cyl SFIC Fi Pull 115 Closer 7	
PROVIDE ONE EACH LUNE ACCESSORIES -KEY GATH SIGNATURE RECEIPT FOR THE NUMBER OF LOCKS F FURNISH AND PROVIDE A PROVIDE A COMPLETE FL PROVIDE COMPLETE SHO AND VERTICAL FORMAT D DOORS, FRAMES & HARD' MODULES, READERS AND VOLTAGE, CIRCUITS, CAB	IERING ENVELOPES, HO RMS, VISIBLE INDEX AND REQUIRED FOR THE PRO INCTIONING OPENING. OP DRAWINGS, SUBMITT OUBLE SPACED HARDW WARE TO BE FURNISHEI ACCESS CONTROL PEF	OK LABELS, PER INSTRUCTION E DJECT. RCEMENTS, BRA ALS AND CUT SH /ARE SCHEDULE D BY DOOR HAR RIPHERALS FURI SHED AND INST/	BOOK. PROVIDE WITH C ACKETS, FASTENERS, S HEETS COMPLYING WIT E. DWARE SUPPLIER AS NISHED AND INSTALLE ALLED BY LICENSED EL	CAPACITY FOR 150 PER SPACERS AND FILLERS TH DHI PRESCRIBED ME SPECIFIED. ACCESS CC D BY SECURITY VENDEI ECTRICIAN.			- 8"	Z UFACTUI	


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RIOR FIELD PAINT UFACTURER:SHERWIN WILLIAMS DR: REPOSE GRAY H: EGG-SHELL ATION: REFER TO FINISH PLAN FOR EXACT ATION	
TRICAL	
E PLATES OR: STAINLESS STEEL	
CES DR: WHITE	
LATED STONE	
JLATED STONE UFACTURER: WILSONART DEL: QUARTZ DUCT #: Q6012 OR: GREY WOLF KNESS: 3 CM	
]
EMARKS ILLWORK TO BE PL-1 AND SS-1	

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Push Pull Set [Always Unlocked] + Closer Stop Requires min. 4" stiles, 6" top rail and 10" bottom rail)			· \
utt Hinge 4B81 4 ½" x 4 ½" NRP ustom WSU Handles, Coordinate with Owner ush Bar 147 x 4 134 Mount at loose ends loser 7101 BC SCS Stop x DPPA-BS-NFB	26D 32D 689	PBB TBD Don Jo PDQ	- - - -
Rim Panic w/ Pull Trim [Lock / Unlock] + Closer Stop Requires min. 4" stiles, 6" top rail and 10" bottom rail)			کر کر
utt Hinge 4B81 4 ½" x 4 ½" NRP im Panic 6400R CD (03) ortise Cylinder Housing I5307 (CD) im Cylinder Housing I5308 (03) FIC Final Cores – By WSU ull 1157 x 4 134 Mount loser 7101 BC SCS Stop x DPPA-BS-NFB	26D 32D 26D 26D 26D 32D 689	PBB PDQ PDQ PDQ WSU Don Jo PDQ	、 、 、 、 、 、 、 、 、 、 、 、 、 、



		DOOR SIZE			DOOR			ТҮРЕ		
NUMBER	ROOM NAME	WIDTH	HEIGHT	HDWE. SET	ТҮРЕ	MATERIAL	FINISH	GLASS	THRESHOLD TY	MATEDIAL
Level 1										-
107.2	LOUNGE	6' - 0"	7' - 0"	1	GLS- 2	ALUM	PFN	GL-2	PER MNF.	AL
121.9	VESTIBULE	3' - 0"	7' - 0"	2	GLS- 1	ALUM	PFN	GL-1	PER MNF.	AL

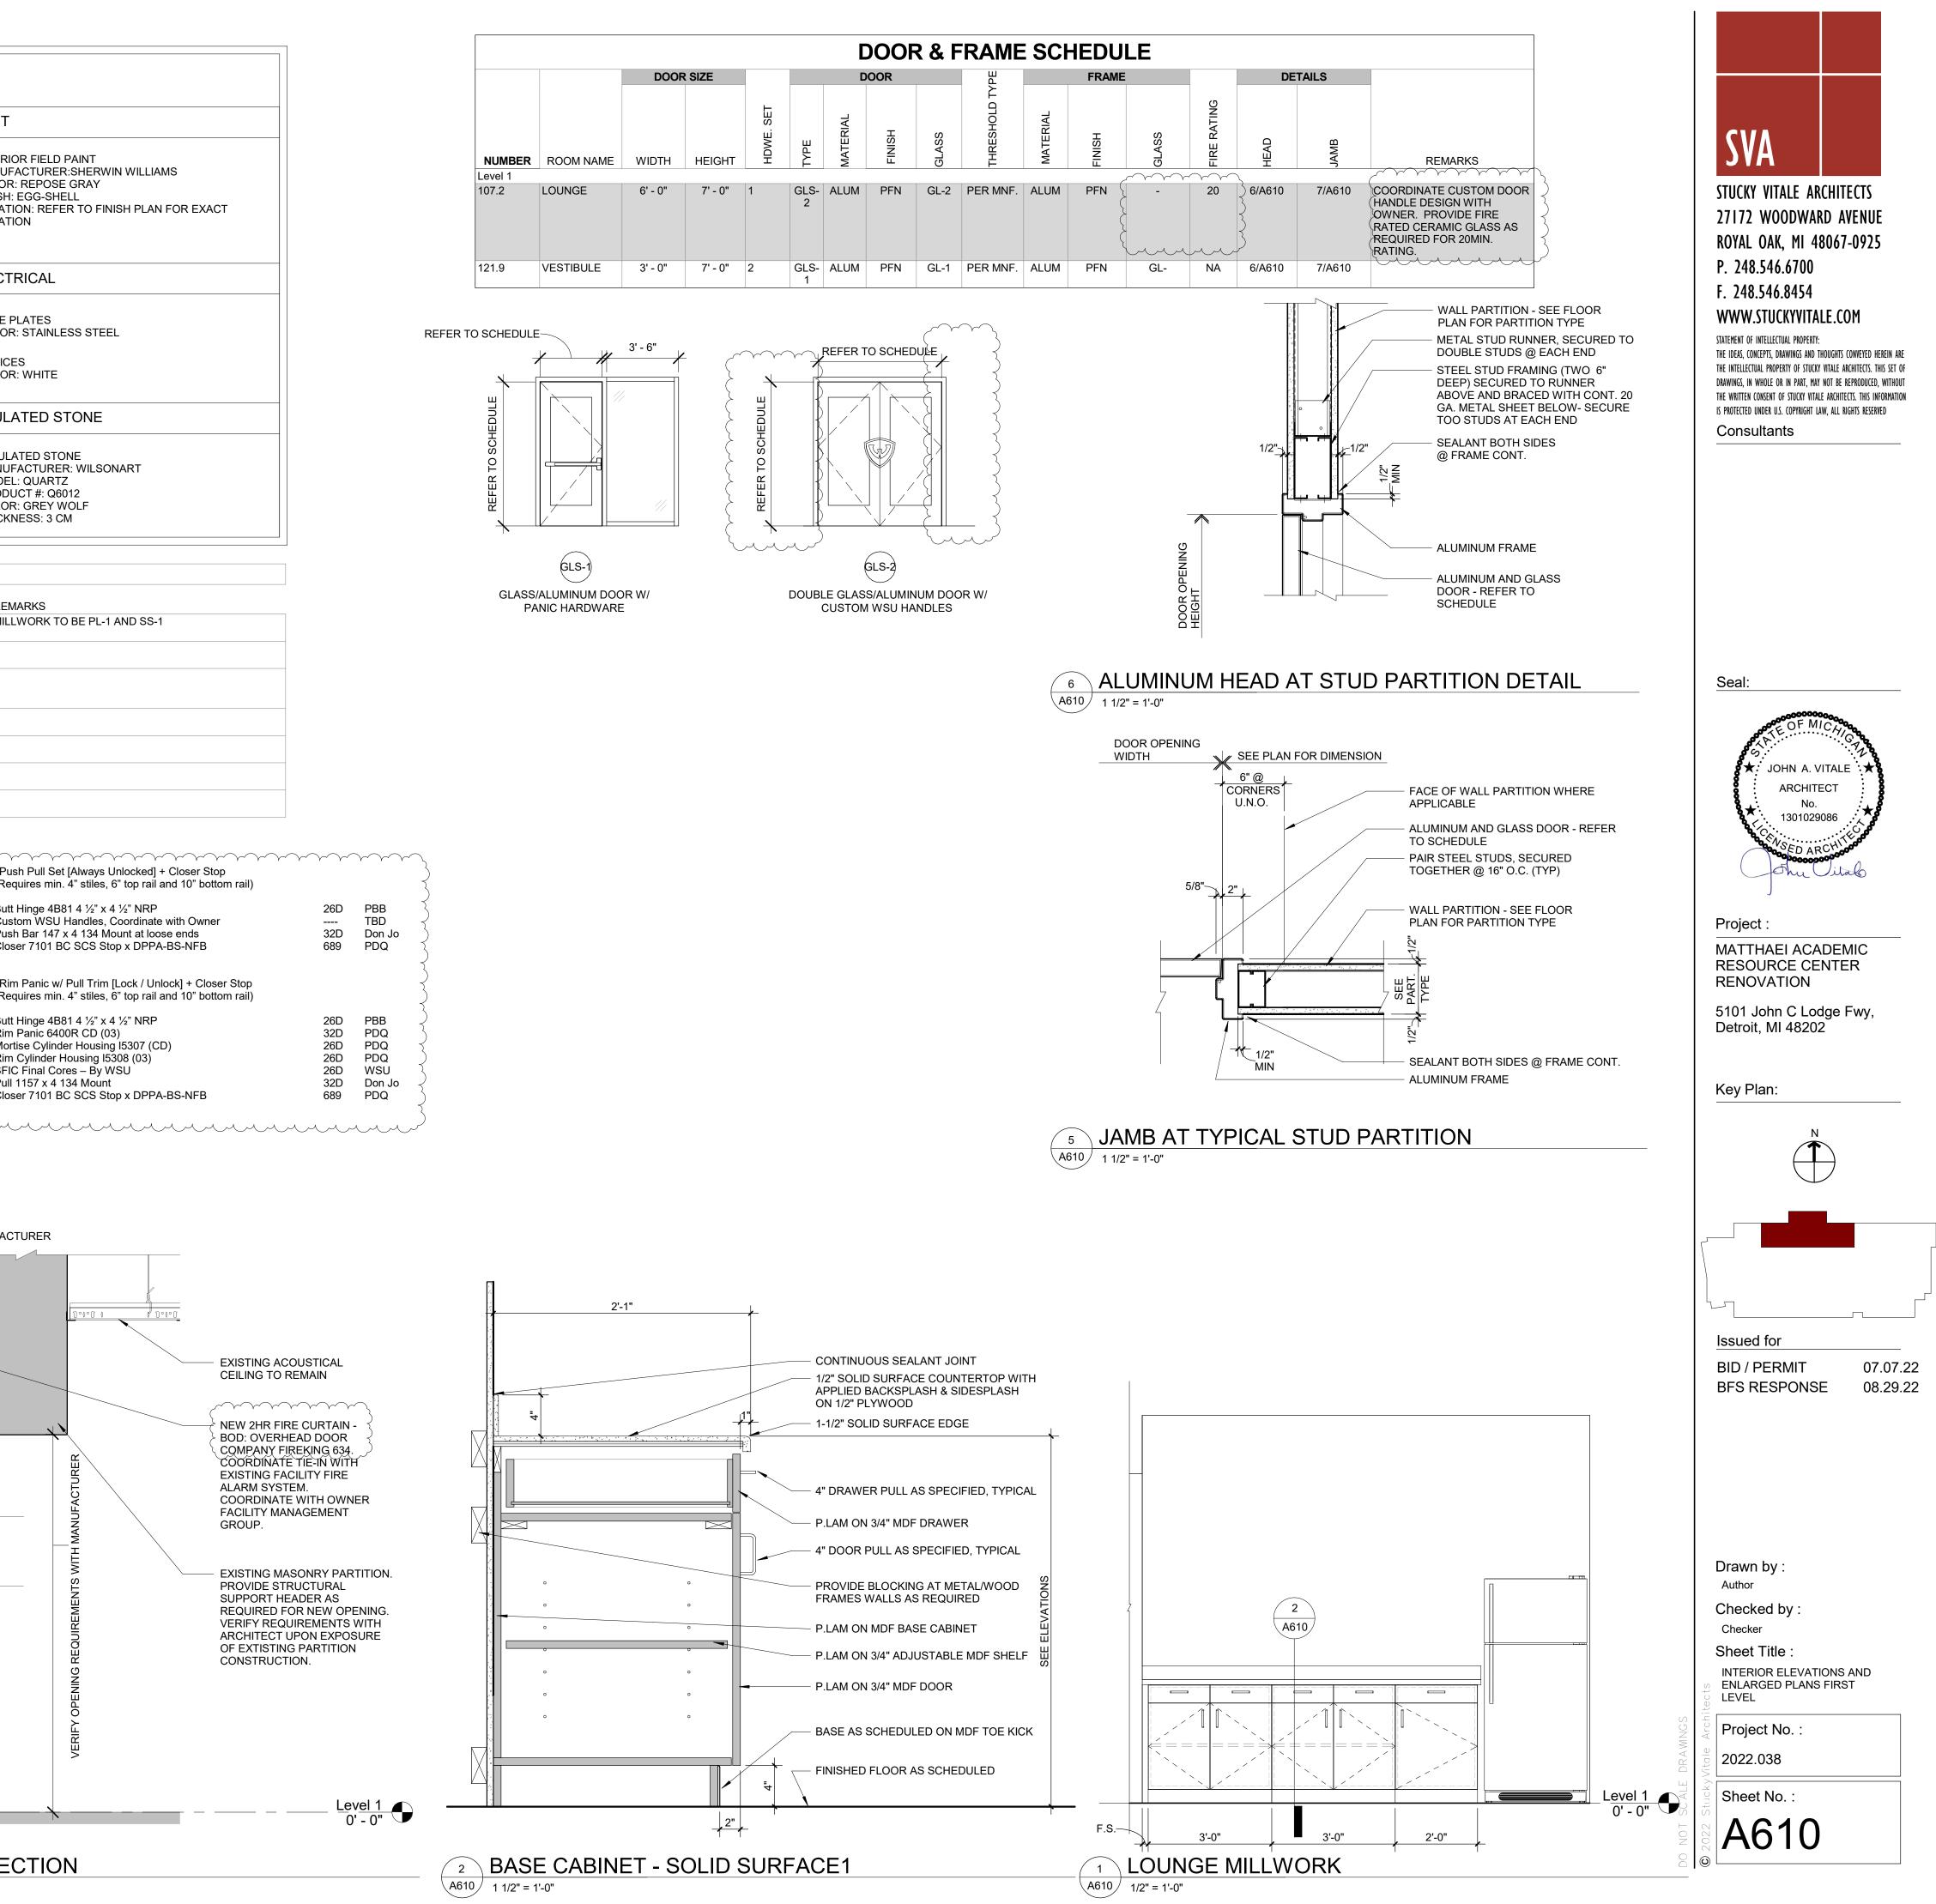

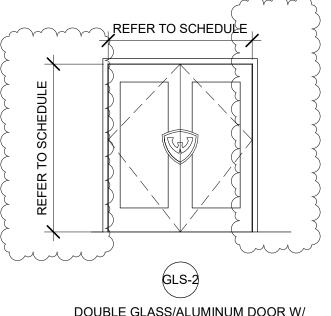



8:56am 1 2022 Jul 07 Thu, δ б Ne CAD\ELEC\81520-E100 atio Re σ Ð H:\ACAD\FILES\81\81520-WSSU Matth <u>KEY NOTES :</u>

- 1 PROVIDE SEPARATE 20A-120V-1P CIRCUIT FROM NEAREST AVAILABLE PANEL. VERIFY PANEL LOCATION.
- $\langle 2 \rangle$ connect to building fire alarm system per building fire alarm system vendor's direction.
- 3 FIRE CURTAIN, PROVIDE SEPARATE (1)20A-120V-1P LIFE SAFETY CIRCUIT FROM NEAREST AVAILABLE SOURCE. VERIFY SOURCE LOCATION IN FIELD.
- $\langle \mathbf{4} \rangle$ connect to existing lighting circuit.
- $\langle 5 \rangle$ rework switching as indicated.
- 6 PROVIDE EXIT LIGHT FIXTURE TO MATCH EXISTING-VERIFY INFIELD. CONNECT TO NEAREST AVAILABLE LIFE SAFETY LIGHTING CIRCUIT.
- RECESSED 6" DIAMETER LED DOWNLIGHT WITH LENS, 2000 LUMENS, 3500°K, 80CRI, 0-10V DIMMING, MULTI-VOLT DRIVER. GOTHAM EVO-6 OR APPROVED EQUAL.



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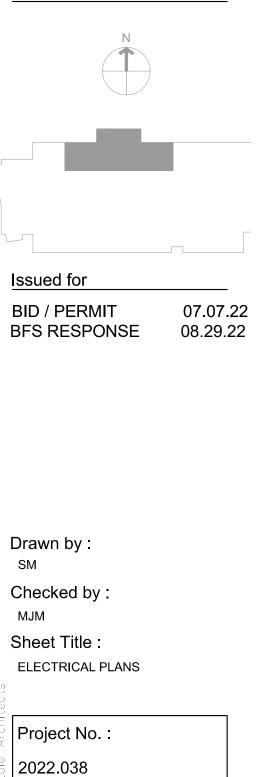


Project :

MATTHAEI ACADEMIC RESOURCE CENTER RENOVATION

5101 John C Lodge Fwy, Detroit, MI 48202

Key Plan:



Sheet No. : E100